

1. SITE LOCATION



2. LANDSCAPE DESIGN INTENT

The landscape design intent for the Masters Home Hardware Store located in Maroochydore, Qld, is to increase the site's environmental amenity and enhance the visual appearance of the development in complement with the proposed building, while making a positive contribution on the surrounding community.

This will be achieved through the implementation of the following landscape strategies:

- The installation of feature garden beds (including sculptural statement planting, earth mounding, ground covers, boulders etc.) in high visibility locations and pedestrian circulation routes.
- Mitigation of site stormwater.
- The careful selection and placement of appropriate, advanced endemic trees, floral shrubs and groundcovers, to create a positive environment which maximises user comfort levels while ensuring a high level of pedestrian safety (e.g. the use of clear trunked canopy trees to the carpark to maintain safety sight lines) with reference to **CPTED principles**.
- Car park and amenity planting addresses the provision of natural shade provision. The selection of shrubs and trees are to complement the scale of the proposed building.
- Plant species were selected with reference to "Take Another Look ...Our Locals are Beauties Fourth Coastal Edition" and Sunshine Coast Biodiversity Strategy 2010-20.
- Shrub, groundcover and tree planting beds between Dalton Drive and car parking are to be a minimum 3m width to provide landscape screening and this is to occupy a minimum of 50% of the proposed building elevation as viewed from the street in approximately 5 years time. Gentle mounding is to be incorporated into the design of these areas (Priority Development Area (PDA) Guideline 10: Industry & Business).
- Inclusion of a mix of two street tree species along Dalton Drive to provide variation in the Streetscape.
- **VEGETATED BUFFER:** Refer to drawing **LC-05** for specific treatment and compliance with relevant codes. Drawing **LC-06** details the proposed creation of a dense landscape buffer to the eastern boundary.
- The landscape design also addresses the following Government Guidelines (as well as those mentioned above):
 - PDA Guideline 9: Centres
 - Subtropical Design in SEQ a Handbook for Planners, Developers and Decision Makers.

| Drg no. | Drawing Title | Scale @ A3 |
|---------|---|------------|
| LC-01 | SITE LOCATION & DESIGN INTENT | nts |
| LC-02 | LANDSCAPE CONCEPT PLAN | 1:1,000 |
| LC-03 | LANDSCAPE CONCEPT - WEST ELEVATION | 1:500 |
| LC-04 | LANDSCAPE CONCEPT - SOUTH ELEVATION | 1:250 |
| LC-05 | LANDSCAPE CONCEPT - VEGETATED BUFFER SECTION ELEVATION | 1:100 |
| LC-06 | LANDSCAPE CONCEPT - EAST ELEVATION: PROPOSED 10m VEGETATED BUFFER | 1:200 |
| LC-07 | LANDSCAPE CONCEPT - EAST ELEVATION: COMPARISON 20m VEGETATED BUFFER | 1:200 |
| LC-08 | LANDSCAPE CONCEPT - PROPOSED PLANT SPECIES: VEGETATED BUFFER | nts |
| LC-09 | LANDSCAPE CONCEPT - PROPOSED PLANT SPECIES | nts |

RARLA


Richard Anderson AILA Registered Landscape Architect

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PROJECT NAME: Masters, Delton Drive East, Marcochydore QLD


CUENT: Hydrox Nominees

DRAWING TITLE: LANDSCAPE CONCEPTSITE LOCATION & DESIGN INTENT

LA102 LC-01

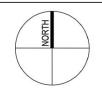DRAWING NUMBER:

SCALE: nts
SHEET: 1/9
DRAWN: SC/RA
DATE: 09/10/2015
ISSUE: **K**

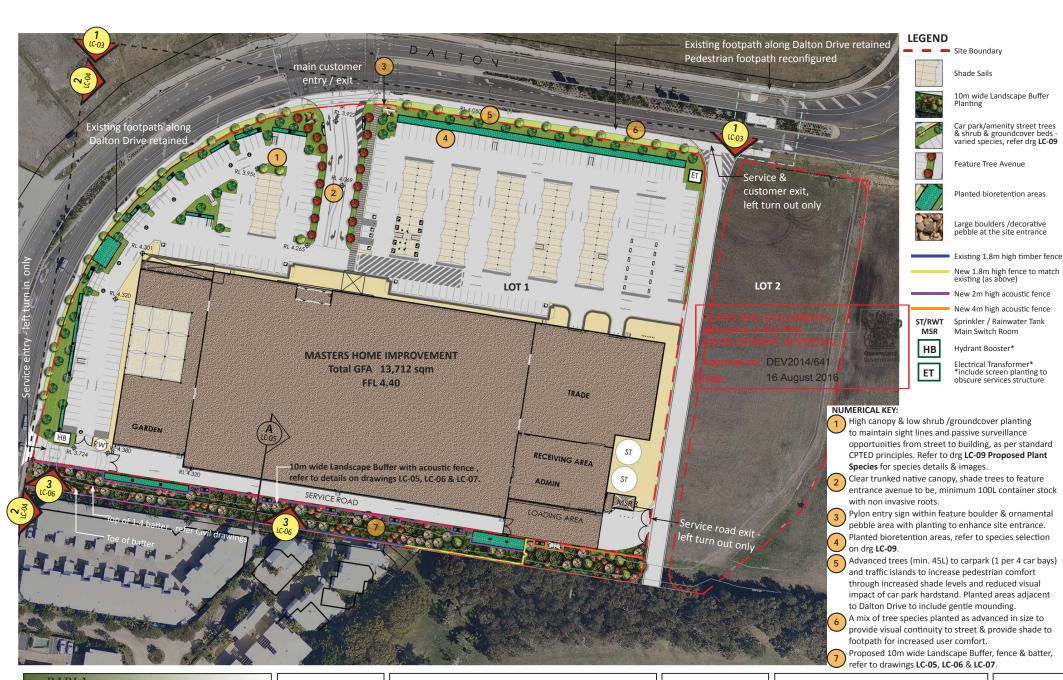

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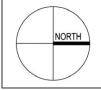
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PROJECT NAME: Masters, Dalton Drive East, Maroochydore QLD CLIENT: Hydrox Nominees

LEGEND

ST/RWT

НВ

ET

Site Boundary

10m wide Landscape Buffer

Feature Tree Avenue

Planted bioretention areas

Large boulders /decorative pebble at the site entrance

New 4m high acoustic fence

Sprinkler / Rainwater Tank Main Switch Room

Electrical Transformer*

*include screen planting to

obscure services structure

Hydrant Booster*

Shade Sails

DRAWINGTITLE: LANDSCAPE CONCEPT PLAN

DRAWING NUMBER: LA102 LC-02 SCALE: 1:1.000@A3 SHFFT: 2/9 DRAWN: SC/RA DATE: 09/10/2015

ISSUE: K



PLANS AND DOCUMENTS referred to in the PDA DEVELOPMENT APPROVAL


Queensland Government

Approval no: DEV2014/641

Date: 16 August 2016

LC-02)

SCALE 1:500 @ A3

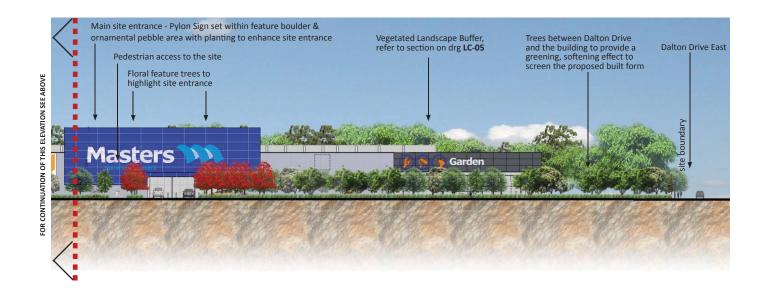

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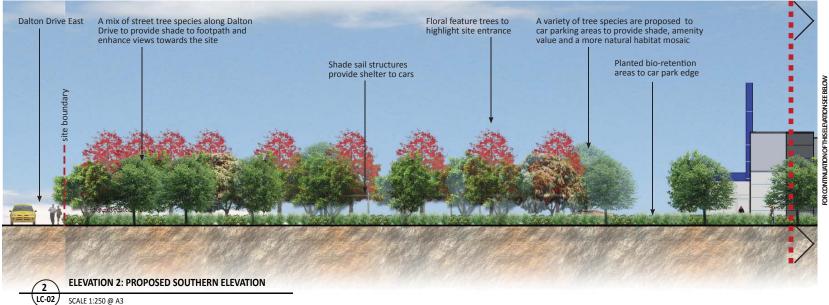
CLIENT: Hydrox Nominees

DRAWINGTITLE: LANDSCAPE CONCEPT -

WESTELEVATION

DRAWING NUMBER: LA102 LC-03

SCALE: 1:500@A3
SHEET: 3/9
DRAWN: SC/RA
DATE: 09/10/2015
ISSUE: **K**



PLANS AND DOCUMENTS
referred to in the PDA
DEVELOPMENT APPROVAL

Queensland Government

Approval no: DEV2014/641

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PROJECT NAME: Masters, Dalton Drive East, Maroochydore QLD

CLIENT: Hydrox Nominees

DRAWINGTITLE: LANDSCAPE CONCEPT -

LANDSCAPE CONCEPT -SOUTH ELEVATION

DRAWING NUMBER: LA102 LC-04


SHEET: 4/9

DRAWN: SC/RA

DATE: 09/10/2015

ISSUE: **K**

SCALE: 1:250@ A3

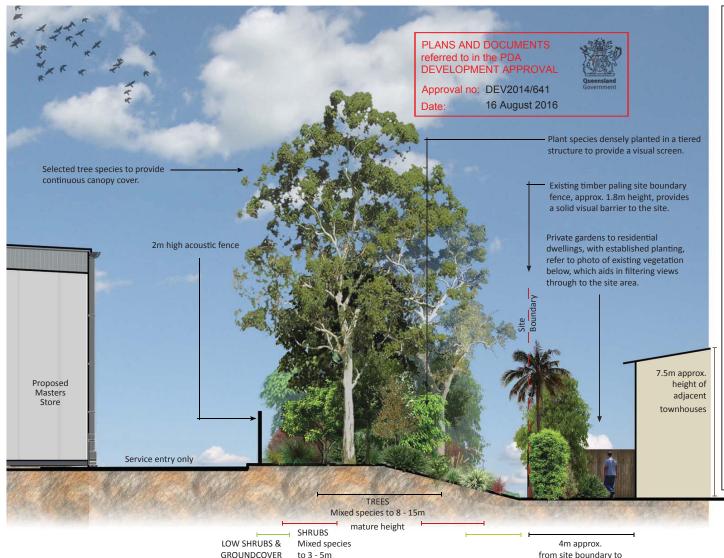

VEGETATED LANDSCAPE BUFFER:

The planted buffer is to provide an effective visual screen within 3 to 5 years, refer to drg LC-06 for predicted growth rate and to drg LC-08 for proposed plant species. Planting will be set out in line with recommendations in the Sunshine Coast Planning Scheme, with:

- large trees at 6m centres:
- small trees at 2m centres:
- shrubs at 1m centres; and
- tufting plants, vines and groundcovers at 0.5m to 1m centres.

The creation of a dense Landscape Buffer to the eastern site boundary. This will effectively protect the edge of the existing native vegetation to the north-eastern edge of the site, this is in line with local ecological values and the Vegetation Management Act (QLD). The Buffer will also provide a substantial visual screen to the proposed acoustic attenuation fencing and the proposed builtform, providing separation between the Site and existing residential dwellings.

Plant species have been selected that are robust and hardy, with some advanced stock (up to 200L) in order to create an instant visual impact. Broad canopy trees, dense foliage shrubs and plants that display vigorous growth habits have been selected so as to create an effective natural foil to the development. The buffer is to consist of native and locally endemic species, selected to provide variation in colour, texture and form. A priority of the buffer is to appear natural, through the creation of upper, mid and understory strata and create a transition corridor.

The use of closely planted endemic screening species, with dense foliage and low growing canopies, to buffer undesirable views to building service areas and car park hardstands from adjacent properties and screen the building from adjacent residential dwellings and Dalton Drive to the east. The visual depth of the Landscape Buffer varies to provide interest and convey a natural appearance. This is in accordance with **PDA Guideline 18: Interfaces**. Vigorous pioneer species are selected in order to create a filtered visual screen in a relatively short time.

Mounding of the Buffer is to a maximum height of 1.2m height, with a batter of 1:4, which assists in screening of proposed builtform and service area to the store, as well as aiding acoustic attenuation. The above strategies satisfy Sunshine Coast Planning Scheme 2014, in particular;


- The Landscape Code (Part 9) with reference to plant selection and stock size, Landscape Buffers and Screening.
- Planning Scheme policies (Schedule 6) referring to vegetative buffer densities.

The proposed 2m high coloured acoustic fencing is to be of an attactive textural design that will integrate with the landscape and proposed vegetation. Colour and design selections will be based on the intended creation of a visually recessive feature in the landscape.

Refer to drg LC-07 for comparison over time of a 20m vegetated buffer.

from site boundary to existing townhouses

> The configuration of the vegetated buffer will be as set out with reference to the Sunshine Coast Planning Scheme 2014, as the adjacent extract displays (Figure 9.4.2 Landscape buffer design from the Landscape Code).

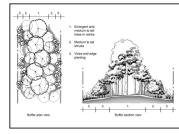

Existing established vegetation along the site's eastern boundary.



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SCALE 1:100 @ A3

6m wide service road

SECTION A: PROPOSED VEGETATED BUFFER

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mature height

10m wide vegetated buffer

Mixed species to

0.5 - 1.5m height

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PROJECT NAME: Masters, Dalton Drive East, Maroochydore QLD

CLIENT: Hydrox Nominees

LANDSCAPE CONCEPT -DRAWINGTITLE: SECTION: VEGETATED BUFFER

DRAWING NUMBER: LA102 LC-05 SCALE: 1:100@A3 SHFFT: 5/9 DRAWN: SC/RA DATE: 09/10/2015 ISSUE: K

Min. Height x

1600 x 700 1

3300x1600 2

1600 x 800 1

3300x1600 2

2000 x 700 2

3300x1600 2

1200 x 500 1

1600 x 500 1

1200 x 500 n/a

1400 x 600 n/a

400 x 300 n/a

600 x 300 n/a

900 x 400 n/a

400 x 300 n/a

500 x 200 n/a

500 x 300 n/a

400 x 300 n/a

1200 x 900 n/a

400 x 300 n/a

400 x 200 n/a

1200 x 800 n/a

400 x 300 n/a

400 x 300 n/a

300 x 200 n/a

300 x 200 n/a

300 x 200 n/a

300 x 200 n/a

300 x 300 n/a

140mm | 300 x 200 | n/a

(plants /m2

n/a

n/a

3

3

2

Width (mm)

1600 x 700

1200 x 400

1200 x 400

2000 x 700

1800 x 800

45L

45L

300mm

200L

45L

45L

45L

200L

45L

200L

300mm

45L

45L

300mm

300mm

200mm

200mm

300mm

200mm

200mm

300mm

200mm

200mm

100L

200mm

200mm

140mm

140mm

140mm

140mm

140mm



PLANS AND DOCUMENTS referred to in the PDA **DEVELOPMENT APPROVAL**

Approval no: DEV2014/641

Date: 16 August 2016



PLANT SCHEDULE

ACA mel

BAC myr

BUC cel

CAL col

CAS equ

COR ter

FLA ret

EUC mic

GRE rob

LOP con

MEL qui

XAN chr

ACA hub

ACM smi

BAE vir

BAN spi

GRE OM

HAK aci

HOV acu

LEP pol

MEL nod

MEL pac

MEL aff

PHE woo

UNDERSTOREY SYZ AB

GROUNDCOVER CIS ant

SYZ ole

WES fru

DIA cae

HAR vio

MEL thy

VIO hed

IIDDLE STOREY

Botanical Name

Acacia melanoxylon

Backhousia myrtifolia

Buckinghamia celsissima

Casuarina equisetifolia

Corymbia tereticornis

Elaeocarpus reticulatus

Eucalyptus microcorys

Lophostemon confertus

Melaleuca quinquenervia

Acacia hubbardiana

Baekea virgata

Hakea acites

Hovea acutifolia

Melaleuca nodosa

Melastoma affine

Melaleuca pachyphylla

Phebalium woombye

Syzygium "Aussie Boomer"

Dianella caerulea "Breeze

Hardenbergia violacea

Melaleuca thymifolia

Syzygium oleoseum

Syzygium wilsonii

Cissus antarctica

Viola hederacea

Westringia fruticosa

Acmena smithii "Minor"

Banksia spinulosa "Giant Candles"

Grevillea "Orange Marmalade"

Leptospermum polygalifolium

Xanthostemon chrysanthus

Grevillea robusta

Banksia integrifolia

Callitris columellaris

Common Name

Blackwood

Grey Myrtle

Swamp Banksia

Ivory Curl Tree

Blueberry Ash

Tallow Wood

Silky Oak

Brush Box

Horse-tail She Oak

Swamp Paperbark

Golden Penda

Prickly Moses

Creek Lily Pilly

Giant Candles

Wallum Hakea

Wild May

Blue Tongue

Woombye Bush

Blue Lilly Pilly

Lily Pilly

Purple Pea Bush

Twiggy Heath Myrtle

Orange Marmalade

Prickly leaved Paperbark

Wallum Bottlebrush

Powder puff Lily Pilly

Native Rosemary

Kangaroo vine

Native Viola

Common Flax Lily

Native Sarsaparilla

Thyme Honey Myrtle

Queensland Blue Gum

Coastal Pine

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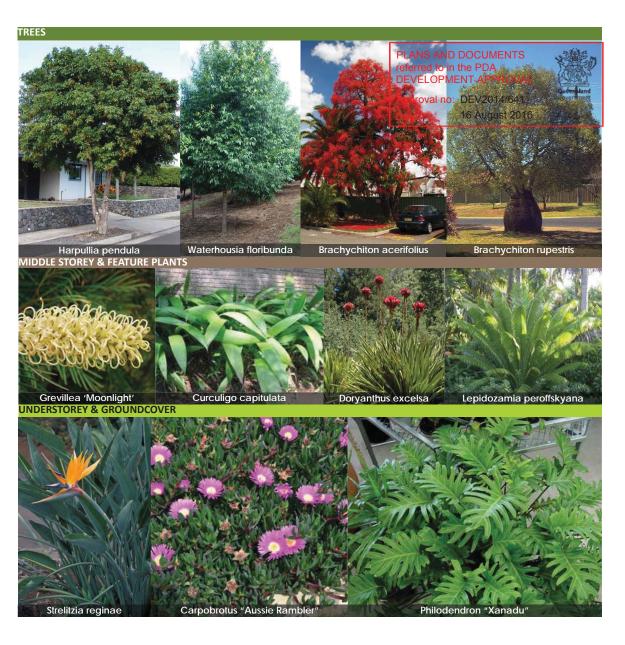
CLIENT: Hydrox Nominees

> DRAWINGTITLE: LANDSCAPE CONCEPT -PROPOSED PLANT SPECIES: VEGETATED BUFFER

DRAWING NUMBER: LA102 LC-08 SCALE: nts SHFFT: 8/9 DRAWN: SC/RA DATE: 09/10/2015 ISSUE: K

3

3



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| PLANT SCHEDULE | | | | Dependent on pot size | | | |
|-------------------------|---------------------------------------|------------------------|----------|-----------------------|-------|-------------|--|
| Code | Botanical Name | Common Name | Pot Size | Min. Height x | Stake | | |
| TREES | | | | Width (mm) | | (plants /m2 | |
| BRA ace ^ | Brachychiton acerifolius | Flame Tree | 100L | 1500 x 500 | 2 | n/a | |
| BRA rup ^ | Brachychiton rupestris | Queensland Bottle Tree | 45L | 1500 x 500 | 2 | n/a | |
| BUC cel ^ | Buckinghamia celsissima | Ivory Curl Tree | 100L | 2000x800 | 2 | n/a | |
| CUP ana ^ | Cupaniopsis anacardiodes | Tuckeroo | 45L | 1600x600 | 2 | | |
| FLA obv*^ | Elaeocarpus obvatus | | 45L | | 2 | n/a | |
| | ' · | Hard Quandong | - | 1200 x 500 | _ | n/a | |
| HAR pen +^ WAT flo + | Harpullia pendula | Tulipwood | 100L | 1800 x 800 | 2 | n/a | |
| | Waterhousia floribunda | Weeping Lilly Pilly | 100L | 1200 x 600 | 2 | n/a | |
| FEATURE PLA | | I | | | | | |
| COR nig | Cordyline nigra | Black Cordyline | 200mm | 600 x 300 | n/a | n/a | |
| CUR cap | Curculigo capitulata | Palm Grass | 300mm | 800 x 400 | n/a | n/a | |
| DOR exc | Doryanthes excelsa | Gymea Lily | 200mm | 500 x 400 | n/a | n/a | |
| LEP per | Lepidozamia peroffskyana | Scaly Zamia | 300mm | 500 x 500 | n/a | n/a | |
| LIR SW | Liriope "Stripey White" | Stripey White | 140mm | 300 x 200 | n/a | n/a | |
| TRA jas | Trachelospermum jasminoides | Chinese Star Jasmine | 140mm | 300 x 250 | n/a | n/a | |
| MIDDLE STOR | REY | | | | | | |
| BAE fru | Baeckea frutescens | Sweet Baeckea | 200mm | 400 x 200 | n/a | n/a | |
| ELA PD | Elaeocarpus reticulatus "Prima Donna" | Prima Donna | 45L | 1600 x 500 | 2 | n/a | |
| GRE ML | Grevillea "Moonlight" | Moonlight Grevillea | 200mm | 800 x 300 | n/a | n/a | |
| UNDERSTORE | EY | | | | | | |
| MEL CT | Melaleuca "Claret Tops" | Dwarf Red Paperbark | 200mm | 400 x 300 | n/a | 2 | |
| STR reg | Strelitzia reginae | Bird of Paradise | 140mm | 500 x 300 | n/a | 2 | |
| WES fru | Westringia fruticosa | Native Rosemary | 140mm | 300 x 200 | n/a | 3 | |
| GROUNDCOV | YERS | | | | | | |
| CAR gla | Carpobrotus "Aussie Rambler" | Pig Face | 140mm | 300 x 200 | n/a | 3 | |
| MYO eli | Myoporum ellipticum | Coastal Boobialla | 140mm | 400 x 300 | n/a | 3 | |
| PHI Xan | Philodendron "Xanadu" | Xanadu | 140mm | 300 x 200 | n/a | 3 | |
| BIO-RETENTION | ON AREAS | | | | | | |
| CAR app | Carex appressa | Tall Sedge | tube | n/a | n/a | 3 | |
| ISO nod | Isolepsis nodosa | Knobby Club Rush | tube | n/a | n/a | 3 | |
| JUN usi | Juncus usitatus | Common Rush | tube | n/a | n/a | 3 | |
| LOM hys | Lomandra hystrix | Mat Rush | tube | n/a | n/a | 3 | |
| | | | | | | | |

- ^ Denotes Car Park Tree Species + Denotes Street Tree
- * Denotes that this tree is to be planted adjacent to bio-retention areas, not within.



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PROJECT NAME: Masters, Dalton Drive East, Maroochydore QLD

CLIENT: Hydrox Nominees

DRAWINGTITLE: LANDSCAPE CONCEPT -

PROPOSED PLANTSPECIES

LA102 LC-09 DRAWING NUMBER:

SCALE: nts SHEET: 9/9 DRAWN: SC/RA DATE: 09/10/2015 ISSUE: K