

MIRVAC

ROL13 – Precincts 5, 6 & 7 Everleigh

ENGINEERING SERVICES REPORT

Report No: MIR-1300/R2403580

Rev: 1

11 November 2024



PLANS AND DOCUMENTS
referred to in the PDA
DEVELOPMENT APPROVAL

Approval no: DEV2024/1517

Date: 16 May 2025



AMENDED IN RED




By: Jennifer Sneesby

Date: 09/05/2025



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DOCUMENT AUTHORISATION					
Revision	Revision Date	Proposal Details			
0	24/05/24	Issue for Approval			
1	11/11/24	Response to Further Issues			
Prepared By		Reviewed By		Authorised By	
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CONTENTS

1.	INTRODUCTION	2
2.	SITE CHARACTERISTICS	3
3.	DATA	5
4.	SERVICES FOR DEVELOPMENT	6
4.1	EARTHWORKS.....	6
4.2	EROSION & SEDIMENT CONTROL.....	7
4.3	ROADWORKS.....	7
	4.3.1 INTERNAL ROADS	7
4.4	NOISE ATTENUATION	8
4.5	TRAFFIC	8
4.6	STORMWATER DRAINAGE	9
4.7	STORMWATER QUANTITY & QUALITY.....	9
4.8	SEWER RETICULATION	10
	PUMP STATION A	10
4.9	WATER RETICULATION	12
5.	CONCLUSION	14

APPENDICES

APPENDIX A	MASTERPLAN LAYOUT.....	15
APPENDIX B	PRELIMINARY EARTHWORKS PLANS	16
APPENDIX C	ROAD HEIRARCHY PLAN.....	17
APPENDIX D	INTERNAL ROAD FUNCTIONAL PLANS.....	18
APPENDIX E	TRAFFIC IMPACT ASSESSMENT	19
APPENDIX F	PRELIMINARY STORMWATER DRAINAGE PLANS.....	20
APPENDIX G	PRELIMINARY SEWER RETICULATION PLANS	21
APPENDIX H	PRELIMINARY WATER RETICULATION PLANS.....	22

1. INTRODUCTION

Premise was commissioned by Mirvac to prepare an Engineering Services Report for Precincts 5, 6 & 7, known as RoL 13, of the Everleigh development. Everleigh is located at Teviot Road, Greenbank and is part of the Priority Development Area (PDA) with EDQ being the assessing authority.

The proposed development consists of Precinct 5, Precinct 6 and Precinct 7. The deliverables of these precincts are list below with the Reconfiguration of a Lot (RoL) plan by Urbis shown in Figure 1.1.

- 354 residential lots
- A 13.4Ha super lot which will be subject to a future application for residential use.
- A 9.3Ha lot for a proposed high school.
- Delivery of a sewer pump station and associated mains (DCOP references SPS001, GM005, GM006 and RM003)
- Portion of trunk water main (DCOP reference WM005)
- Stormwater quality devices
- Neighbourhood and linear parks.

This report covers all engineering services that will be required to service the proposed development at a conceptual level for Development Approval. This report should be read in conjunction with the reports provided by Urbis (Town Planning). RoL Layouts by Urbis are included in Appendix A.





Precincts 5, 6 and 7 have an approximate combined area of 53.4 ha and are located towards the east of the overall site. They adjoin Primary School and Central Park precincts to the west and Precincts 8 and 10 to the north.

The natural surface topography across RoL 13 includes an overland flow path running west to east, with maximum grades of up to 7% raising from this channel. The western edge of the subject area is bounded by completed earthworks and a completed road in the northern half.

Earthworks is currently being completed in the northern portions of RoL 13 to fill a shortfall of material in the approved Precincts 8 and 10. As such clearing of these borrow pits have also been completed under the Precincts 8 and 10 VCFMP.

The site is bound by conservation land to the east. The site has an active EPBC approval in place.

The proposed site location within the overall Everleigh development can be seen in Figure 2.1.





Figure 2.1: Site Location



3. DATA

Data for this report has been gathered from the following sources:

- Urbis Townplanners – Lot layout
- Economic Development Queensland (EDQ) – Greater Flagstone Priority Development Area plans and documents;
- Saunders Havill Group – Detail Survey (check);
- Premise Movement Network Infrastructure Master Plan, report number P000170/R02, Rev D (approval pending);
- Premise Sewerage Infrastructure Masterplan, report number MIR-0020/R01 (approval pending);
- Premise Water Infrastructure Masterplan, report number P000196/R01 (approval pending);
- Logan City Council – Existing services location (where applicable and relevant) and Planning Scheme 2015 development information;
- Detailed design and construction from DEV2018/999, DEV2020/1131 and DEV2022/1277
- Dial Before You Dig.
- ATP Consulting Engineers 'Traffic Noise Impact Assessment, Everleigh Green Bank, RoL 13 Application
- Engeny Everleigh Stormwater Masterplan, report number QC4060_005-REP-701-2
- Stormwater technical letter 'Everleigh RoL13 – Stormwater Quantity And Stormwater Quality Analysis' prepared by Engeny



4. SERVICES FOR DEVELOPMENT

4.1 EARTHWORKS

Earthworks will be required to facilitate the construction of the roads, allotments and parks proposed within Precincts 5, 6 and 7. The earthworks will consist of excavations, filling, permanent batters to existing surface level with maximum slope of 1 in 4 and batters between lots with a maximum slope of 1 in 2. Retaining walls will be constructed during civil works to provide level allotments. Retaining walls will be provided to lots where the height difference is 450mm or greater to a maximum height of 2.5m.

A preliminary 'as if complete' earthworks design has been carried out over the RoL 13 area. While the target for the earthworks design was to minimise the cut and fill volumes associated with the earthworks operation along with targeting a cut to fill volume balance, there were several constraints that needed to be considered which influenced levels. These constraints included:

- Interface to natural surface levels and adjoining developed precincts
- Interface to the conservation area
- Road Gradings
- Benching of allotments
- Maintaining the maximum grade across of the school site of 5%.
- Relationship between benched allotments and retaining walls
- Coordination with landscape design in linear parks and pedestrian lanes
- Stormwater drainage outlet and channel levels

The preliminary earthworks design for the site has identified that the overall earthworks cut and fill volumes result in a slight surplus of material, however this is based on concept levels through the future residential area in Precinct 5. The aim will be to reduce the cut through this area to have a slight shortfall in material.

To maintain 1 in 4 maximum batters along the conservation edge, 600mm high sandstone retaining walls have been utilised so that earthworks does not cross the boundary. This approach has been discussed with Logan City Council who stipulated the 600mm maximum height for passive surveillance. Areas where walls are required are shown on plan.

We note that due to the location of certain pad mount transformers along the conservation edge, an Energex retaining wall be required within their normal 4.8m x 5.0m to allow a flat surface for them to sit on.

Vegetation clearing will be required to allow earthworks operations to commence up to the conservation edge. Typically, a 100m bushfire buffer zone to maintenance as per the Bushfire Management Plan. Due to the conservation edge, this cannot be met. To achieve a suitable BAL rating, a 20m esplanade road reserve borders the entire edge. The additional 6m in this road reserve is to allow for interface earthworks to the natural surface.



The proposed earthworks design and extent can be seen on the Preliminary Earthworks Sketch Plans Provided in Appendix B.

4.2 EROSION & SEDIMENT CONTROL

Erosion and Sediment Control (ESC) measures will be required during all stages of development from site establishment to project completion. An Erosion and Sediment Control program will be designed and detailed during the detailed design phase.

4.3 ROADWORKS

Vehicle access to the site area will be via Anderson Drive and Ivory Parkway/Everleigh Drive through the recently completed Precinct 9 and previously completed school precinct. There will another, lower order access, through Guroman Drive once Precincts 8 and 10 are constructed which will link back up to the nearest roundabout on Anderson Drive to Teviot Road.

4.3.1 INTERNAL ROADS

The road layout has been developed in accordance with the road typologies nominated in the approval pending Movement Network Infrastructure Master Plan (MNIMP). Noting however the typologies are consistent with the existing MNIMP.

The roads servicing the Precincts 5, 6 and 7 include:

- Anderson Drive – Neighbourhood Connector 1
- Unnamed Road 103 – Neighbourhood Connector 1
- Guroman Drive – Neighbourhood Connector 2
- All other roads – Access Street (typical, park & conservation), including driveway extension.

The conservation typology of the Access Street is a new type for this application and has been included in the recently submitted MNIMP update. This road type is an Access Street pavement type within a 20m road reserve to allow for interface earthworks to the conservation area and additional bush fire management.

It is noted that Guroman Drive fronting the southern boundary of the proposed high school does not fit a typical cross section. This is because the internal design is not yet known for the high school and there is a high chance any works along this boundary would need retrofitting and not suit that intended use. Parking along this stretch (typical cross section) does not want to be offered to the public to then be removed by the school and its needs. If the school has not advised on their desired outcome prior to construction, the typical cross section for a Neighbourhood Connect 2 will be constructed.

A Road Hierarchy Plan showing the above road typologies located within the precincts can be seen in Appendix C.



All allotments can be accessed from the proposed internal road network via direct driveway access or the dedicated driveway access reserves provided. The proposed roads will be provided with concrete kerb and channel, 1.5m minimum width concrete footpaths or shared paths and minimum 4m wide verges which accommodate necessary service corridors as required by Logan City Council. We note that certain verges are reduced to 2.2m when fronting park or open space.

Internal Road Functional plans detailing the Precinct 5, 6 and 7 internal road network can be seen in Appendix D.

4.4 NOISE ATTENUATION

A traffic noise impact assessment has been undertaken by ATP Consulting Engineers (ATP). ATP undertook traffic noise propagation modelling to consider the future traffic flows for a planning horizon of 2044. Based on the results of the traffic noise impact assessment for the ROL 13 (Precincts 6 and 7) of the Everleigh development, the following is concluded:

- Teviot Road does not affect the noise amenity at the allotments within ROL 13
- Residential dwellings fronting Anderson and Guroman Drive have to be designed as per AS3671-1989 to mitigate traffic noise ingress. Refer Figure 6.1 of the below mentioned report.
- A setback distance of 10m and 5m from the lot boundary facing Anderson and Guroman Drive, respectively, must be imposed to comply with the outdoor play area and outdoor learning area criterion for educational facilities.
- Acoustic upgrades are required for educational facilities located within 50m from the boundary facing Anderson and Guroman Drive.

ATP Engineers have stated within their Traffic Noise Impact Assessment Everleigh, Greenbank ROL10 Application report *'Provided the recommended planning and design noise control measures are implemented in the construction of Everleigh development ROL 13, road traffic noise will not impose any further constraints on the establishment of this stage of the development.'*

Refer to ATP Consulting Engineers 'Traffic Noise Impact Assessment, Everleigh Green Bank, RoL 13 Application' report attached as part of the application documentation for further information.

4.5 TRAFFIC

A Traffic Impact Assessment has been prepared which addresses the suitability of the proposed Precincts 5, 6 and 7 site layout and road typologies, and determines traffic volumes in accordance with overall site data. The Traffic Impact Assessment provides confirmation of the above items with consideration to relevant guidelines, standards, and approved documents.

The Traffic Impact Assessment can be seen in Appendix E (supplied in separate document due to size).



4.6 STORMWATER DRAINAGE

The proposed piped roofwater drainage, underground drainage and major storm overland flow for this site will be designed in accordance with EDQ Guideline 13, Logan City Council and QUDM stormwater design guidelines. It is proposed that a network of gully pits and underground pipes will be constructed to capture and convey stormwater collected from allotments and roadways towards two new bioretention basins at a discharge point in the southeastern corner of the subject site. The area is nominated as Precinct 7.3 on the reconfiguration plans. There is a portion of the RoL 13 piped network which will discharge into the existing Anderson Drive pipe network which discharges into the future wetland.

The major storm overland flows generated from the Precincts 5, 6 and 7 catchments will be contained in the road reserves and conveyed to multiple discharge points including Anderson Drive for a portion of the north western catchment where it discharges into the interim wetland/detention arrangement, and various points along the conservation boundary for the eastern catchments. The overland flows discharging directly into the conservation area will flow through riparian revegetation zones.

Refer to the Preliminary Stormwater Drainage Plans provided in Appendix F and stormwater technical letter 'Everleigh RoL13 – Stormwater Quantity And Stormwater Quality Analysis' prepared by Engeny for further details.

4.7 STORMWATER QUANTITY & QUALITY

To allow for the multiple discharge points directly into the conversation area, the majority of flows from Precincts 5, 6, 7 are not detained. In accordance with the Everleigh Stormwater Masterplan prepared by Engeny, the central wetland area is designed to hold back major flows from that receiving catchment to allow the flows generated in this subject area first. Small catchments in the north and west of the precincts flow into the wetland area for detention.

Details on the proposed Stormwater Quantity and Quality treatments proposed for this precinct are provided within the stormwater technical letter 'Everleigh RoL13 – Stormwater Quantity And Stormwater Quality Analysis' prepared by Engeny. This stormwater technical letter outlines the water quantity and quality analysis undertaken in support of the Reconfiguration of a Lot (ROL) submission for Precincts 5, 6 and 7 of the Everleigh development.



4.8 SEWER RETICULATION

All proposed residential allotments within Precincts 5, 6 and 7 will be provided with a sewer property service. Property services will be connected to a sewer reticulation pipe network located within the road reserves.

The sewer reticulation network will be designed and installed in accordance with SEQ D&C Code, Logan City Council requirements and Premise prepared whole of site sewer design master plan.

There is one (1) internal sewer catchments within the ROL 13 area, however future Precincts 3 and 4 of the Everleigh development feed into the proposed pump station located within this application. This pump station also will also service the existing primary school and 7 lots within P10.5. There is a temporary pump station servicing the school located on the southeastern side of the Ivory Parkway/Anderson Drive roundabout. This temporary station must remain operational until the proposed pump station A is commissioned.

Sewer Pump Station A and its receiving 300mm gravity main and outgoing rising main are offsetting works under the Greater Flagstone Developer Charges and Offset Plan. Their DCOP IDs are SPS001, GM005, GM005 and RM003 respectively.

Table 4.8.1 below calculates the equivalent persons that Pump Station A will service.

1. Table 4.8.1

Catchment	Unit	EP / Unit	Total EP
Proposed RoL			
Precinct 6 & 7	354 Lots	2.8 EP per Lot	992
High School	1,800 students & 190 staff	0.1 EP per Lot	199
Total			1,191
Future RoL*			
Precinct 5.3	332 Lots	2.8 EP per Lot	930
Precinct 3 & 4	917 Lots	2.8 EP per Lot	2,565
Total			3,495
Existing			
Primary School	1,400 students & 140 staff	0.1 EP per Lot	154
Precinct 10.5	7 Lots	2.8 EP per Lot	20
Total			174
TOTAL OVERALL			4,860

Note - The future residential have been included for the sizing of the SPS and downstream gravity main systems. These future lots will be completed as part of a future ROL approval.*

PUMP STATION A

Pump Station A (SPS001) is positioned in Precinct 5 of the RoL. This pump station services the largest catchment within the Everleigh development and considered offsetable under the DCOP. The rising main



is proposed to head north from the pump station, then west along the proposed new neighbourhood collector road, on the opposite side of the road to the school, where it will tunnel bore under the existing roundabout. From here, it will run parallel to the existing temporary 63mm rising main but just internal to the future southern sports park lot, within an easement. The rising main will discharge into an existing discharge manhole on Ivory Parkway (east to drain) where it gravity feeds into the regional pump station.

The demand on the SPS A is summarised in the table 4.8.2 below

2. Table 4.8.2

Category	Unit	EP / Unit	Total EP	Total ADWF	Total PWWF
Residential	1,610 Lots	2.8 EP per Lot	4,861	11.25 L/s	56.26 L/s
School	3,200 students & 330 staff	0.1 EP per pupil			

Note, A residential lot average day weather flow (ADWF) of 200L/EP/Day and peak wet weather flow (PWWF) of 1000L/EP/Day were adopted in accordance with the Logan Water Alliance Desired Standards of Service (DSS) April 2014

A summary of the wet well sizing is shown in the table below. The required operational storage of the wet well was calculated as 162.03m³ and a wet well diameter of 2m was adopted. The preliminary calculated depth of the wet well is 9.48m.

3. Table 4.8.3

Wet Well Details	Value
Capacity (PWWF) (L/s)	56.26
Operating Storage (m ³)	4.22
Wet Well diameter (m)	2.0
Operating Depth (m)	1.34
Surface Level (m)	34.27
Incoming Invert Level (m)	27.53
Alarm RL (m)	27.38
Standby RL (m)	27.08
Pump TWL RL (m)	26.93
Pump BWL RL (m)	25.59
Floor Level RL (m)	25.19
Wet Well Depth (m)	9.48
Emergency Storage Time	4 hours at ADWF of 11.25L/s
Total Emergency Storage Volume Required (m ³)	162.03
Emergency Storage in Wet Well (Above Alarm Level) (m ³)	21.65
Additional Emergency Storage Required (m ³)	140.39

A summary of the SRM sizing calculations is shown in table 4.8.4 below. An DN250 PE100 DR11 pipe will have a suitable velocity of 1.74m/s with a PWWF of 56.26L/s. The duty point of the pump station was



calculated as 56.26L/s at 24.42m. Preliminary design plans for the Sewage Pump Station and rising main are attached with the Preliminary Sewer Reticulation Plans in Appendix H.

4. Table 4.8.4

	Value
PWWF	56.26 L/s
Length of SRM	560
Pipe Type	PE100 DR11
Nominal Size	DN250
Internal Diameter (mm)	203
Area (m²)	0.032
Velocity (m/s)	1.74
C value	130
Friction Head (m)	8.31
Low point (Pump BWL) (m)	25.59
High point (m)	41.70
Static Head Requirement (m)	16.11
Total Pump Head (m)	24.42
Pump Duty Point	56.26 L/s at 24.42m

The detailed design submission for pumping infrastructure and the receiving system shall be accompanied by the Odour Impact Assessment Report. This Impact Assessment shall address the odour impacts at the air discharge of associated gravity mains at the SPS location, the operation of the SPS, at the rising main discharge point to the downstream gravity network, and gas release valve arrangements.

As mentioned, the system will be discharging into an existing system which has already taken these loads into the account.

The sewer reticulation system details described above are shown on the Preliminary Sewer Reticulation Plans in Appendix H.

4.9 WATER RETICULATION

All proposed allotments in Precincts 5, 6 and 7 will be provided with a potable water service connection. A water reticulation pipe network will be provided in Precincts 5, 6 and 7 to provide service connections to each allotment. The water reticulation network will be designed and installed in accordance with the SEQ D&C Code, Logan City Council requirements and the recently resubmitted Water Infrastructure Masterplan prepared by Premise.

In the ultimate, fully developed, scenarios Precincts 5, 6 & 7 are serviced from a low-level connection on Greenbank Road. Due to how the site has been delivered, this connection will not occur until during or after the construction of these precincts, without a significant clearing and bulk earthworks operation occurring on top of what is required for the subject area. As such, to minimise the environmental exposure of the site and to ensure delivery of key pieces of infrastructure, such as the school lot and SPS, temporary pressure



reducing valves are proposed in similar locations to the boundary valves. The PRVs will be set to have minimal impact/pressure affect when the connection points switch.

However, it is proposed that the low-level water main is constructed and live by the time the final lot in Precinct 5, 6, 7 is registered.

The Anderson Drive extension will carry a portion of the 250mm main which is covered by the DCOP. ID number WM005.

The details described above are shown on the Preliminary Water Reticulation Plans in Appendix K



5. CONCLUSION

Based on the information collected and preliminary investigations carried out it has been established that the proposed development can be adequately serviced.

All service and infrastructure layouts are generally in accordance with the relevant approved infrastructure master plans, EDQ requirements, and other relevant and appropriate design standards and guidelines.



APPENDICES

APPENDIX A

MASTERPLAN LAYOUT



APPENDIX B

PRELIMINARY EARTHWORKS PLANS



LEGEND - PROPOSED

- EXTENT OF CUT
- EXTENT OF FILL
- PROPOSED BORROW AREA. FINAL EXTENT TO BE CONFIRMED DURING DETAILED DESIGN
- BORROW AREA EXTENT FOR PRECINCTS 8 AND 10 EARTHWORKS. FURTHER EARTHWORKS TO BE DONE TO GET TO FINISHED SURFACE LEVEL
- PROPOSED FUTURE RESIDENTIAL PRECINCT 5.3
- 12.0

FINISHED MAJOR CONTOURS (0.50m)
- FINISHED MINOR CONTOURS (0.25m)
- RETAINING WALL
- VEGETATION CLEARING LINE
- ROL BOUNDARY
- PRECINCT BOUNDARY

LEGEND - EXISTING


- EARTHWORKS TO BE DONE AS PART OF PRECINCTS 8, 9 AND 10. FOR DETAILS, REFER TO APPROVED DRAWINGS DEV2022/1277 DATED 11 NOVEMBER 2022 FOR PRECINCTS 8 AND 10 AND APPROVED DRAWINGS DEV2020/1160 DATED 26 AUGUST 2021 FOR PRECINCT 9
- 12.0

EXISTING CONTOURS (0.50m)
- RETAINING WALL
- EXISTING VEGETATION CLEARING LINE

ROL13 EARTHWORKS VOLUMES

	CUT	FILL
ROL13 EARTHWORKS	407,025m ³	390,543m ³
TOTAL VOLUMES	407,025m ³	390,543m ³

NOTE:
1. BULK EARTHWORKS INCLUDES ROAD BOXING.
2. ROAD BOXING DEPTHS FOR PRECINCTS 6 AND 7 ARE 335mm FOR ACCESS STREETS, OTHERWISE 450mm. NO BOXING ALLOWANCE FOR PRECINCT 5.3.

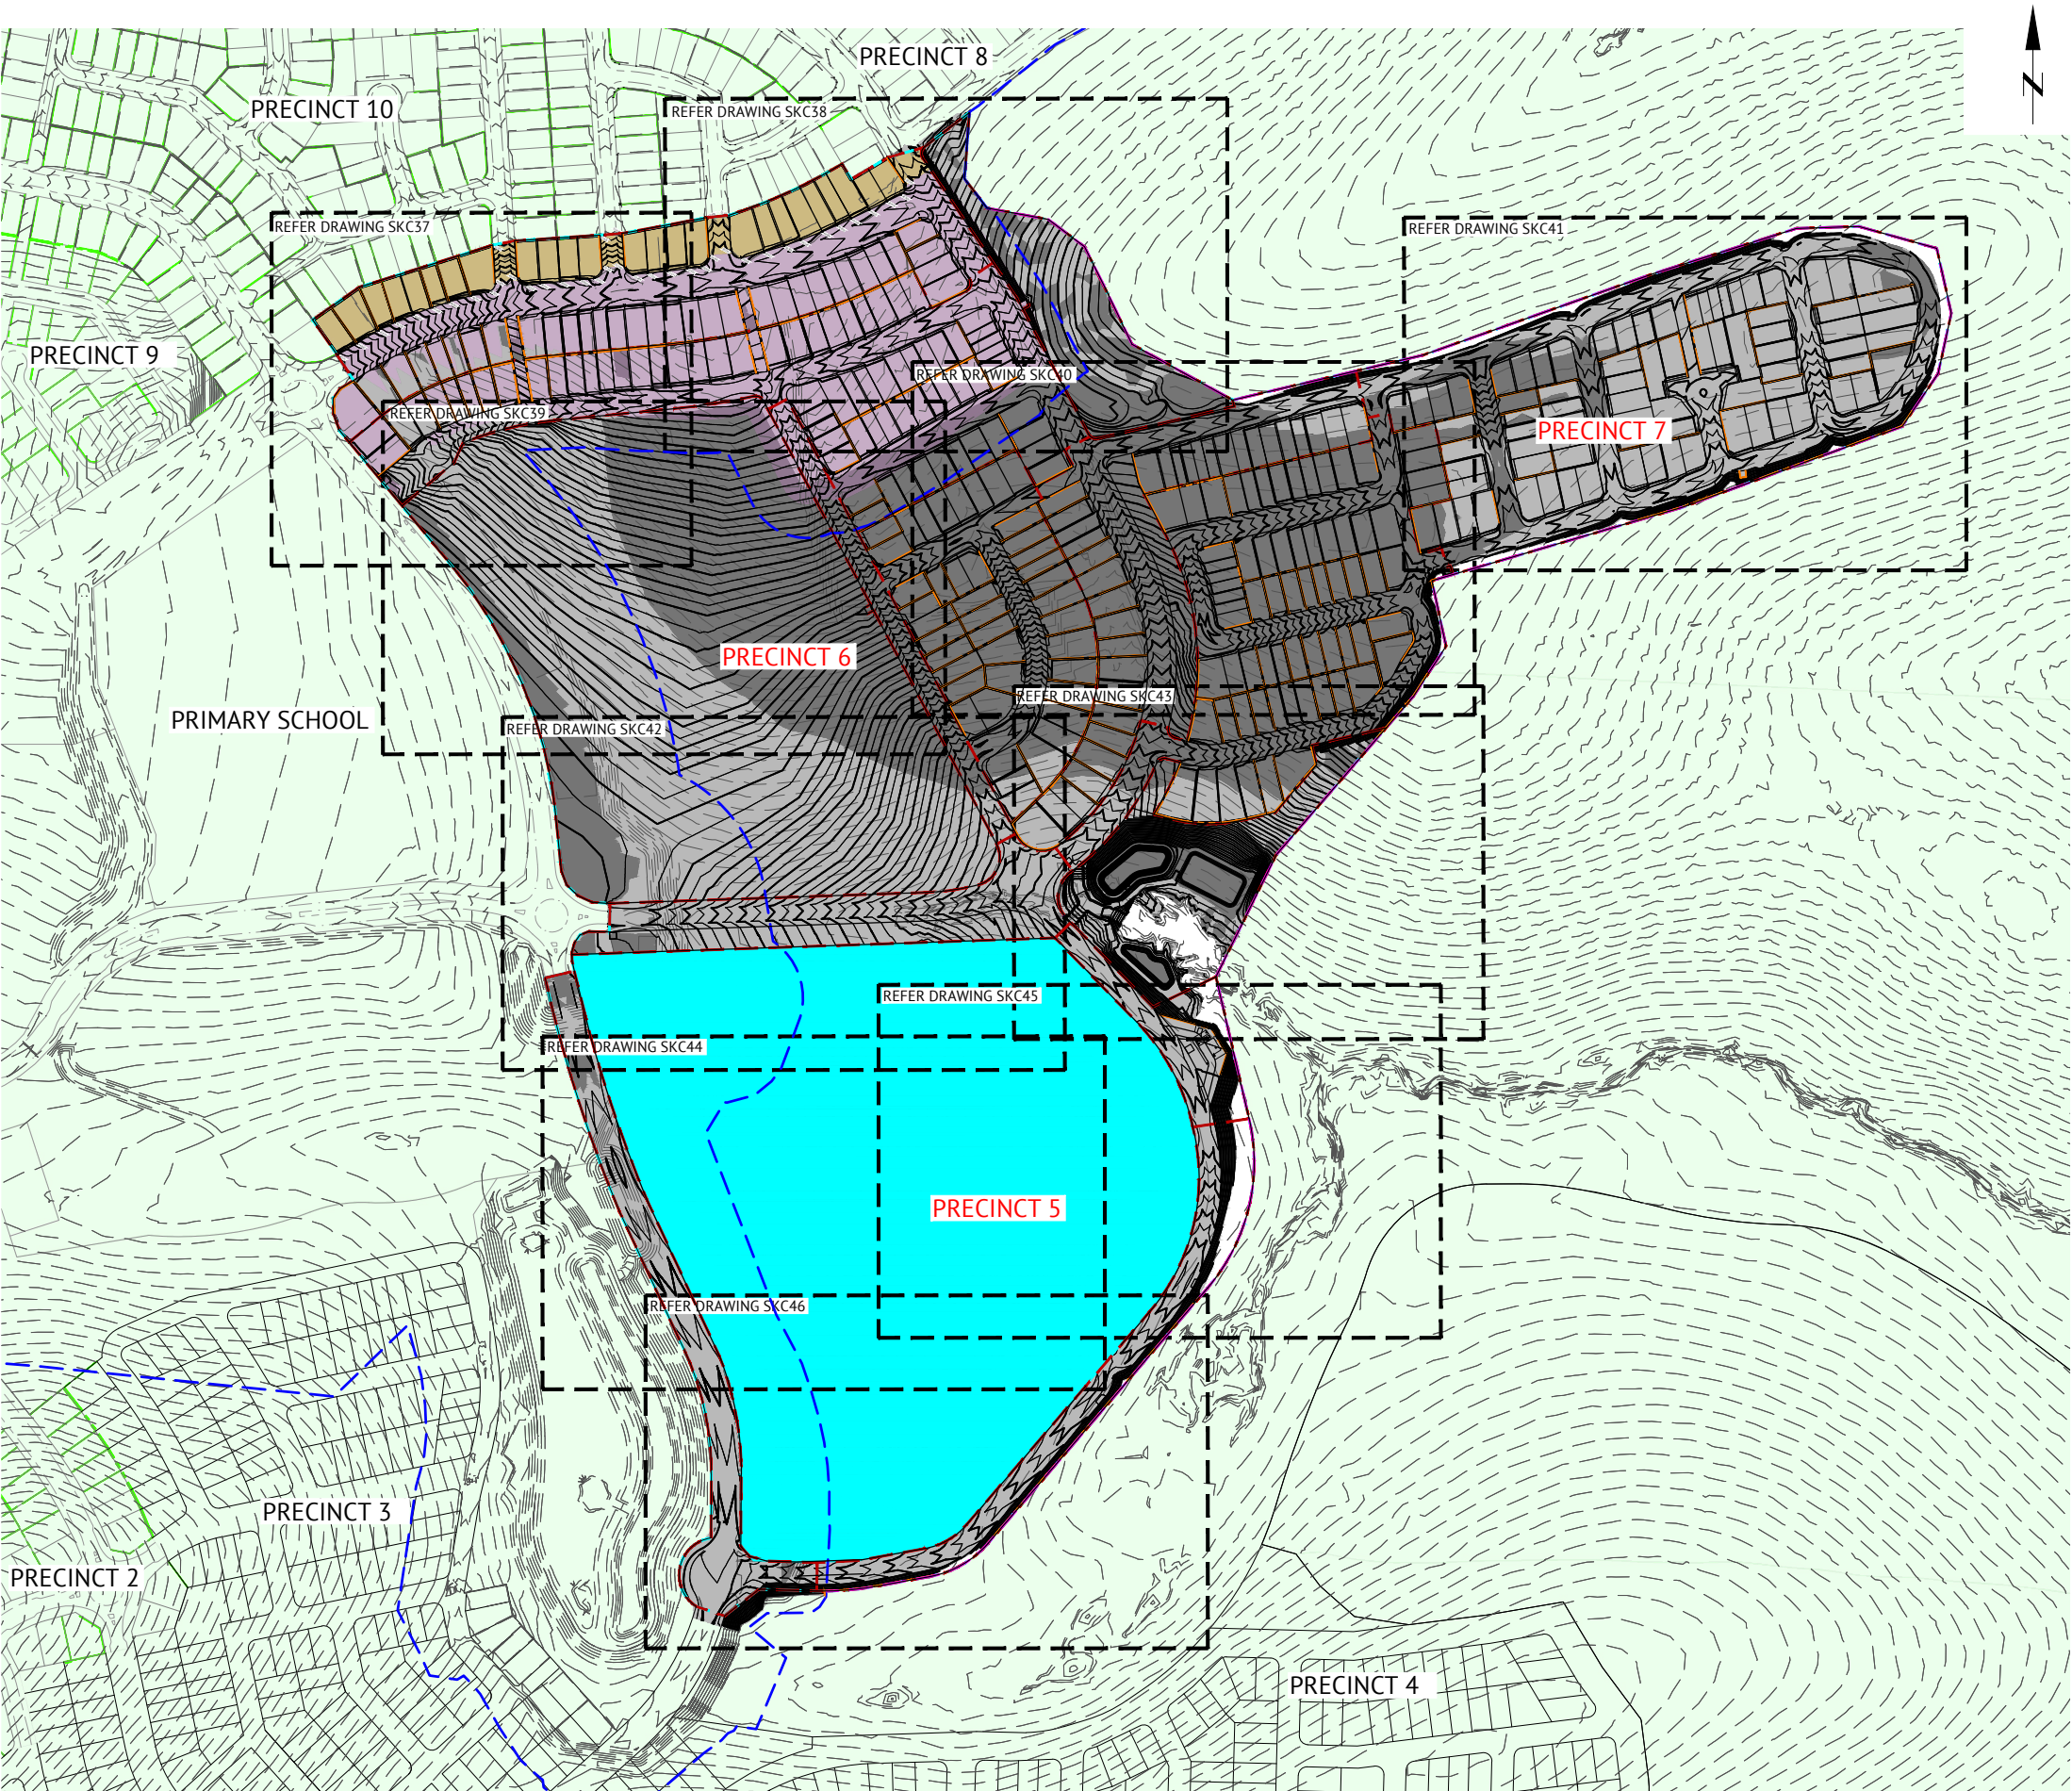

PRELIMINARY - NOT FOR CONSTRUCTION

DATE	REV	DESCRIPTION	REC	APP
05/11/2024	4	UPDATED EARTHWORKS AS PER CHANGES TO LOT LAYOUT	KK	NS
22/05/2024	3	UPDATED BASIN LAYOUT AND ADDED PMT PADS	KK	NS
08/05/2024	2	UPDATED LAYOUT AND EARTHWORKS	KK	NS
25/10/2023	1	PRELIMINARY - NOT FOR CONSTRUCTION	KK	NS


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CLIENT

MIRVAC QLD PTY LTD

PROJECT

EVERLEIGH ROL13 SUBDIVISION DEVELOPMENT

LOCATION

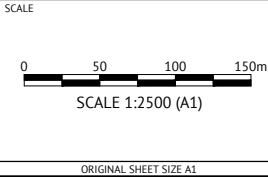TEVIOT ROAD, GREENBANK

SHEET TITLE

OVERALL PRELIMINARY EARTHWORKS LAYOUT PLAN

JOB CODE

MIR-1300

SHEET NUMBER

SKC36

REV

4



PRELIMINARY - NOT FOR CONSTRUCTION

05/11/2024	5	UPDATED EARTHWORKS AS PER CHANGES TO LOT LAYOUT	KK	NS
22/05/2024	4	ADDED PMT PAIDS	KK	NS
08/03/2024	3	UPDATED LAYOUT AND EARTHWORKS	KK	NS
13/12/2023	2	UPDATED PRECINCT BOUNDARIES AND PRECINCT NUMBERS	KK	NS
25/10/2023	1	PRELIMINARY - NOT FOR CONSTRUCTION	KK	NS
DATE	REV	DESCRIPTION	REC	APP



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	SCALE
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SCALE 1:500 (A1)

ORIGINAL SHEET SIZE A1

CLIENT

PROJECT

LOCATION

SHEET TITLE

MIRVAC QLD PTY LTD

EVERLEIGH ROL3 SUBDIVISION DEVELOPMENT

TEVIOT ROAD, GREENBANK

PRELIMINARY EARTHWORKS LAYOUT PLAN - SHEET 1

JOB CODE

MIR-1300

SHEET NUMBER
SKC37

5



NOTES
REFER SKC37 FOR NOTES AND LEGEND

PRELIMINARY - NOT FOR CONSTRUCTION

05/11/2024	5	UPDATED EARTHWORKS AS PER CHANGES TO LOT LAYOUT	KK	NS
22/05/2024	4	ADDED PMT PADS, ADDED EARTHWORKS TO PARK LOT 840	KK	NS
08/05/2024	3	UPDATED LAYOUT AND EARTHWORKS	KK	NS
13/12/2023	2	UPDATED PRECINCT BOUNDARIES AND PRECINCT NUMBERS	KK	NS
25/10/2023	1	PRELIMINARY - NOT FOR CONSTRUCTION	KK	NS
DATE	REV	DESCRIPTION	REC	APP

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SCALE

SCALE 1:500 (A1)

ORIGINAL SHEET SIZE A1

CLIENT

MIRVAC QLD PTY LTD

PROJECT

EVERLEIGH ROL13 SUBDIVISION DEVELOPMENT

LOCATION

TEVIOT ROAD, GREENBANK

SHEET TITLE

PRELIMINARY EARTHWORKS LAYOUT PLAN - SHEET 2

JOB CODE


MIR-1300

SHEET NUMBER

SKC38

REV

5

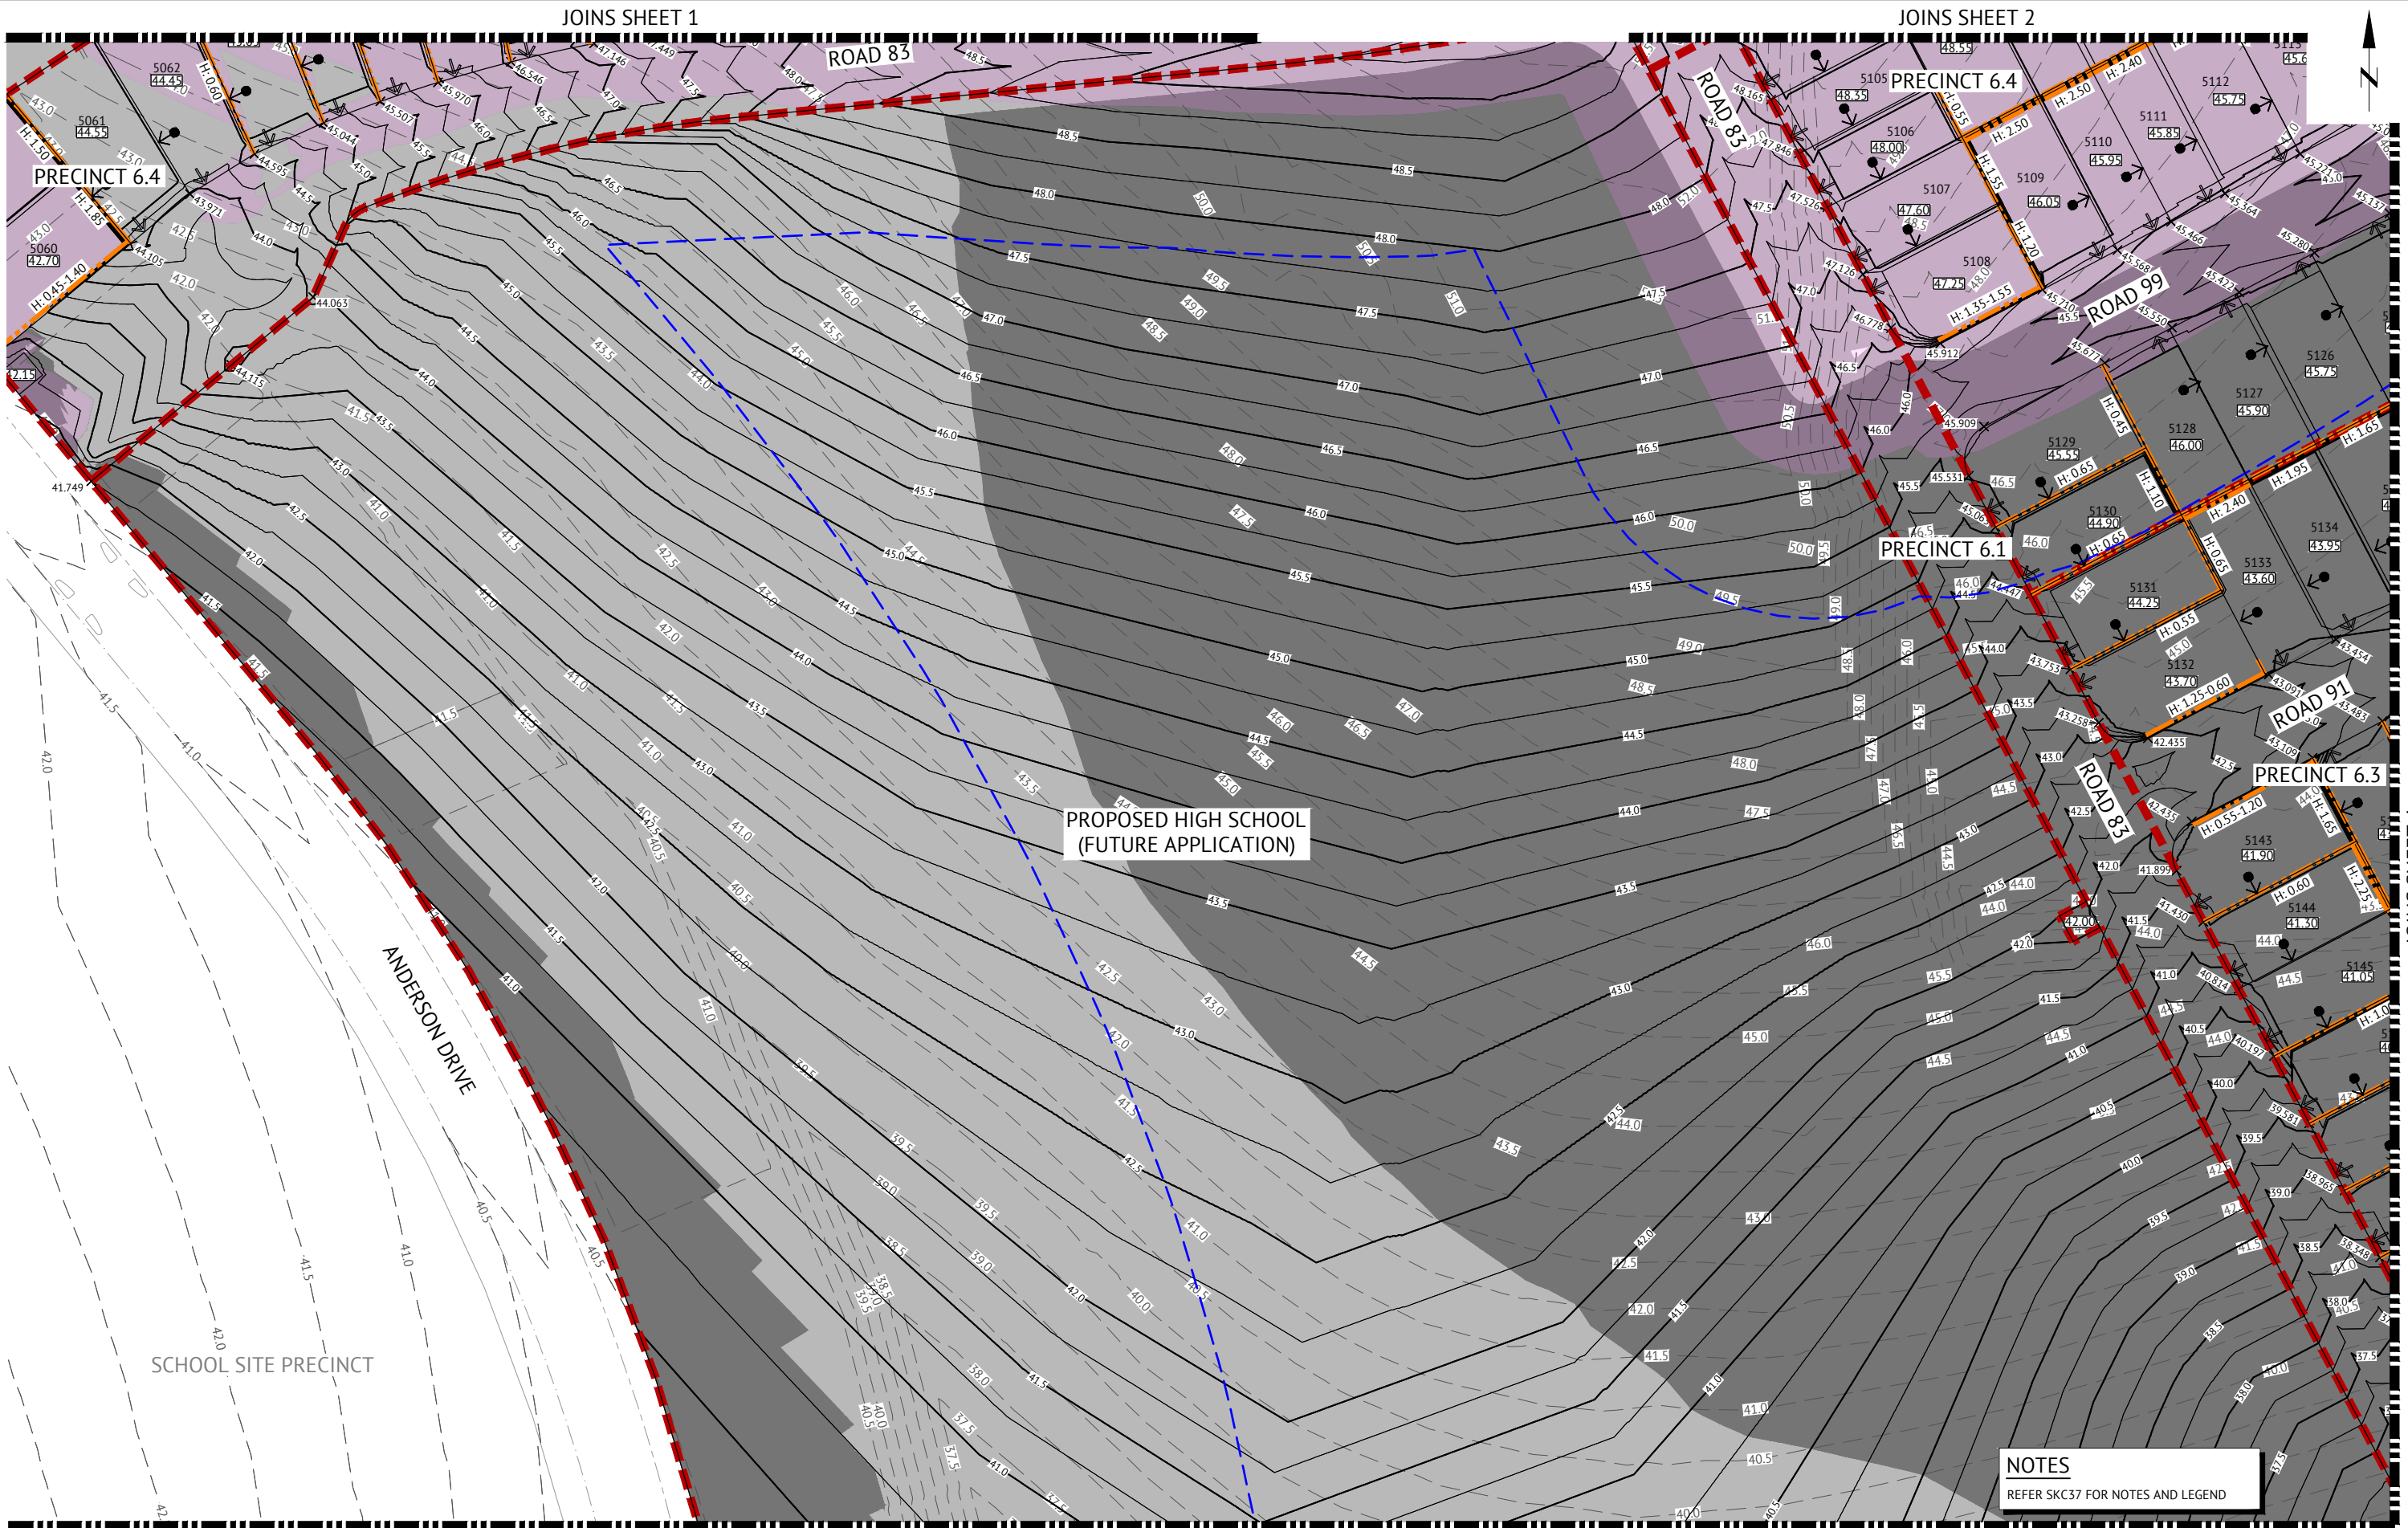

PRELIMINARY - NOT FOR CONSTRUCTION

DATE	REV	DESCRIPTION	REC	APP
05/11/2024	5	UPDATED EARTHWORKS AS PER CHANGES TO LOT LAYOUT	KK	NS
22/05/2024	4	ADDED PMT PADS	KK	NS
08/05/2024	3	UPDATED LAYOUT AND EARTHWORKS	KK	NS
13/12/2023	2	UPDATED PRECINCT BOUNDARIES AND PRECINCT NUMBERS	KK	NS
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ENGINEERING CERTIFICATION
PATRICK BRADY RPEQ 7112

SCALE
0 10 20 30m
SCALE 1:500 (A1)
ORIGINAL SHEET SIZE A1

CLIENT

MIRVAC QLD PTY LTD

PROJECT

EVERLEIGH ROL13 SUBDIVISION DEVELOPMENT

LOCATION

TEVIOT ROAD, GREENBANK

SHEET TITLE

PRELIMINARY EARTHWORKS LAYOUT PLAN - SHEET 3

JOB CODE

MIR-1300


SHEET NUMBER

SKC39

REV

5

NOTES
REFER SKC37 FOR NOTES AND LEGEND

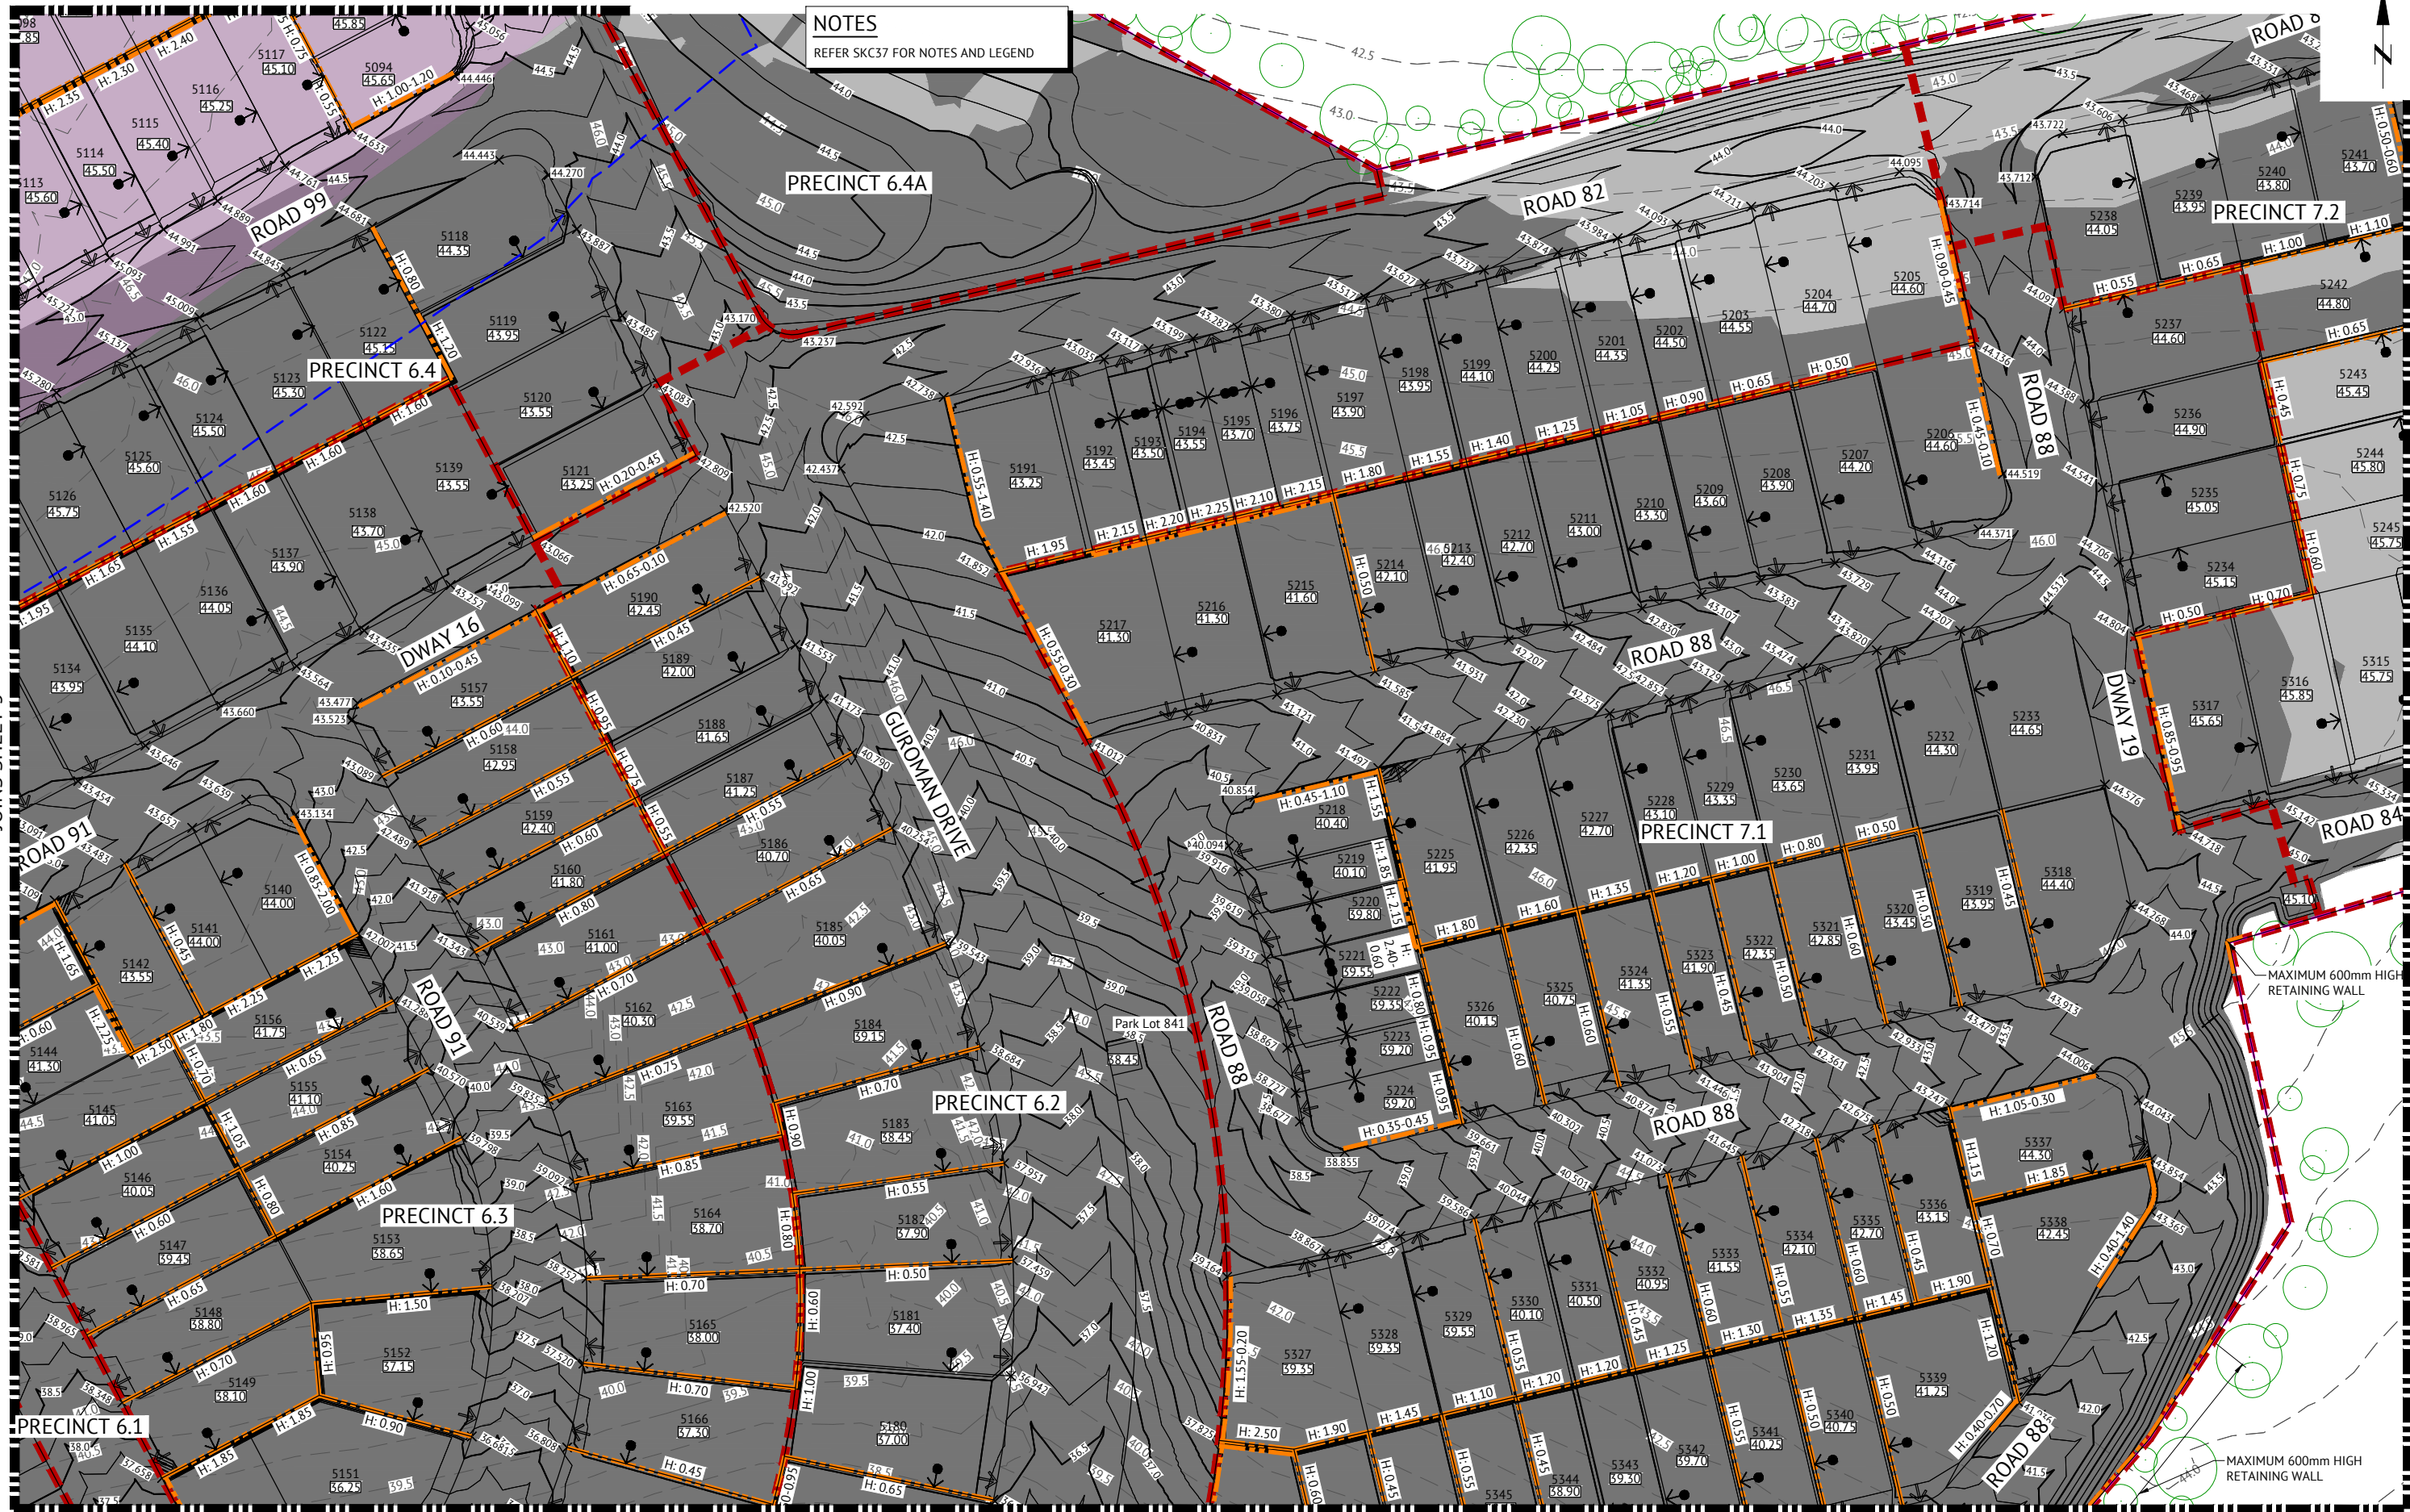

PRELIMINARY - NOT FOR CONSTRUCTION

DATE	REV	DESCRIPTION	REVISIONS
05/11/2024	5	UPDATED EARTHWORKS AS PER CHANGES TO LOT LAYOUT	KK NS
22/05/2024	4	ADDED PMT PADS, ADDED EARTHWORKS TO PARK LOT 840	KK NS
08/05/2024	3	UPDATED LAYOUT AND EARTHWORKS	KK NS
13/12/2023	2	UPDATED PRECINCT BOUNDARIES AND PRECINCT NUMBERS	KK NS
25/10/2023	1	PRELIMINARY - NOT FOR CONSTRUCTION	KK NS



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WEB: www.premise.com.au

DESIGNED
KLYNT KIWANG
CHECKED
ANDREW LANGDON
PROJECT MANAGER
NICK SOMERVILLE
ENGINEERING CERTIFICATION
PATRICK BRADY RPEQ 7112

SCALE
0 10 20 30m
SCALE 1:500 (A1)
ORIGINAL SHEET SIZE A1

CLIENT
MIRVAC QLD PTY LTD
PROJECT
EVERLEIGH ROL13 SUBDIVISION DEVELOPMENT
LOCATION
TEVIOT ROAD, GREENBANK
SHEET TITLE
PRELIMINARY EARTHWORKS LAYOUT PLAN - SHEET 4

JOB CODE
MIR-1300
SHEET NUMBER
SKC40
REV
5



NOTES
REFER SKC37 FOR NOTES AND LEGEND

PRELIMINARY - NOT FOR CONSTRUCTION				
DATE	REV	DESCRIPTION	REVISIONS	
05/11/2024	5	UPDATED EARTHWORKS AS PER CHANGES TO LOT LAYOUT	KK	NS
22/05/2024	4	ADDED PMT PADS	KK	NS
08/05/2024	3	UPDATED LAYOUT AND EARTHWORKS	KK	NS
13/12/2023	2	UPDATED PRECINCT BOUNDARIES AND PRECINCT NUMBERS	KK	NS
25/10/2023	1	PRELIMINARY - NOT FOR CONSTRUCTION	KK	NS




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BRISBANE, QLD 4000
PH: (07) 3253 2222
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DESIGNED
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ANDREW LANGDON
PROJECT MANAGER
NICK SOMERVILLE
ENGINEERING CERTIFICATION
PATRICK BRADY RPEQ 7112

SCALE
0 10 20 30m
SCALE 1:500 (A1)
ORIGINAL SHEET SIZE A1

CLIENT
MIRVAC QLD PTY LTD
PROJECT
EVERLEIGH ROL13 SUBDIVISION DEVELOPMENT
LOCATION
TEVIOT ROAD, GREENBANK
SHEET TITLE
PRELIMINARY EARTHWORKS LAYOUT PLAN - SHEET 5

JOB CODE
MIR-1300
SHEET NUMBER
SKC41
REV
5

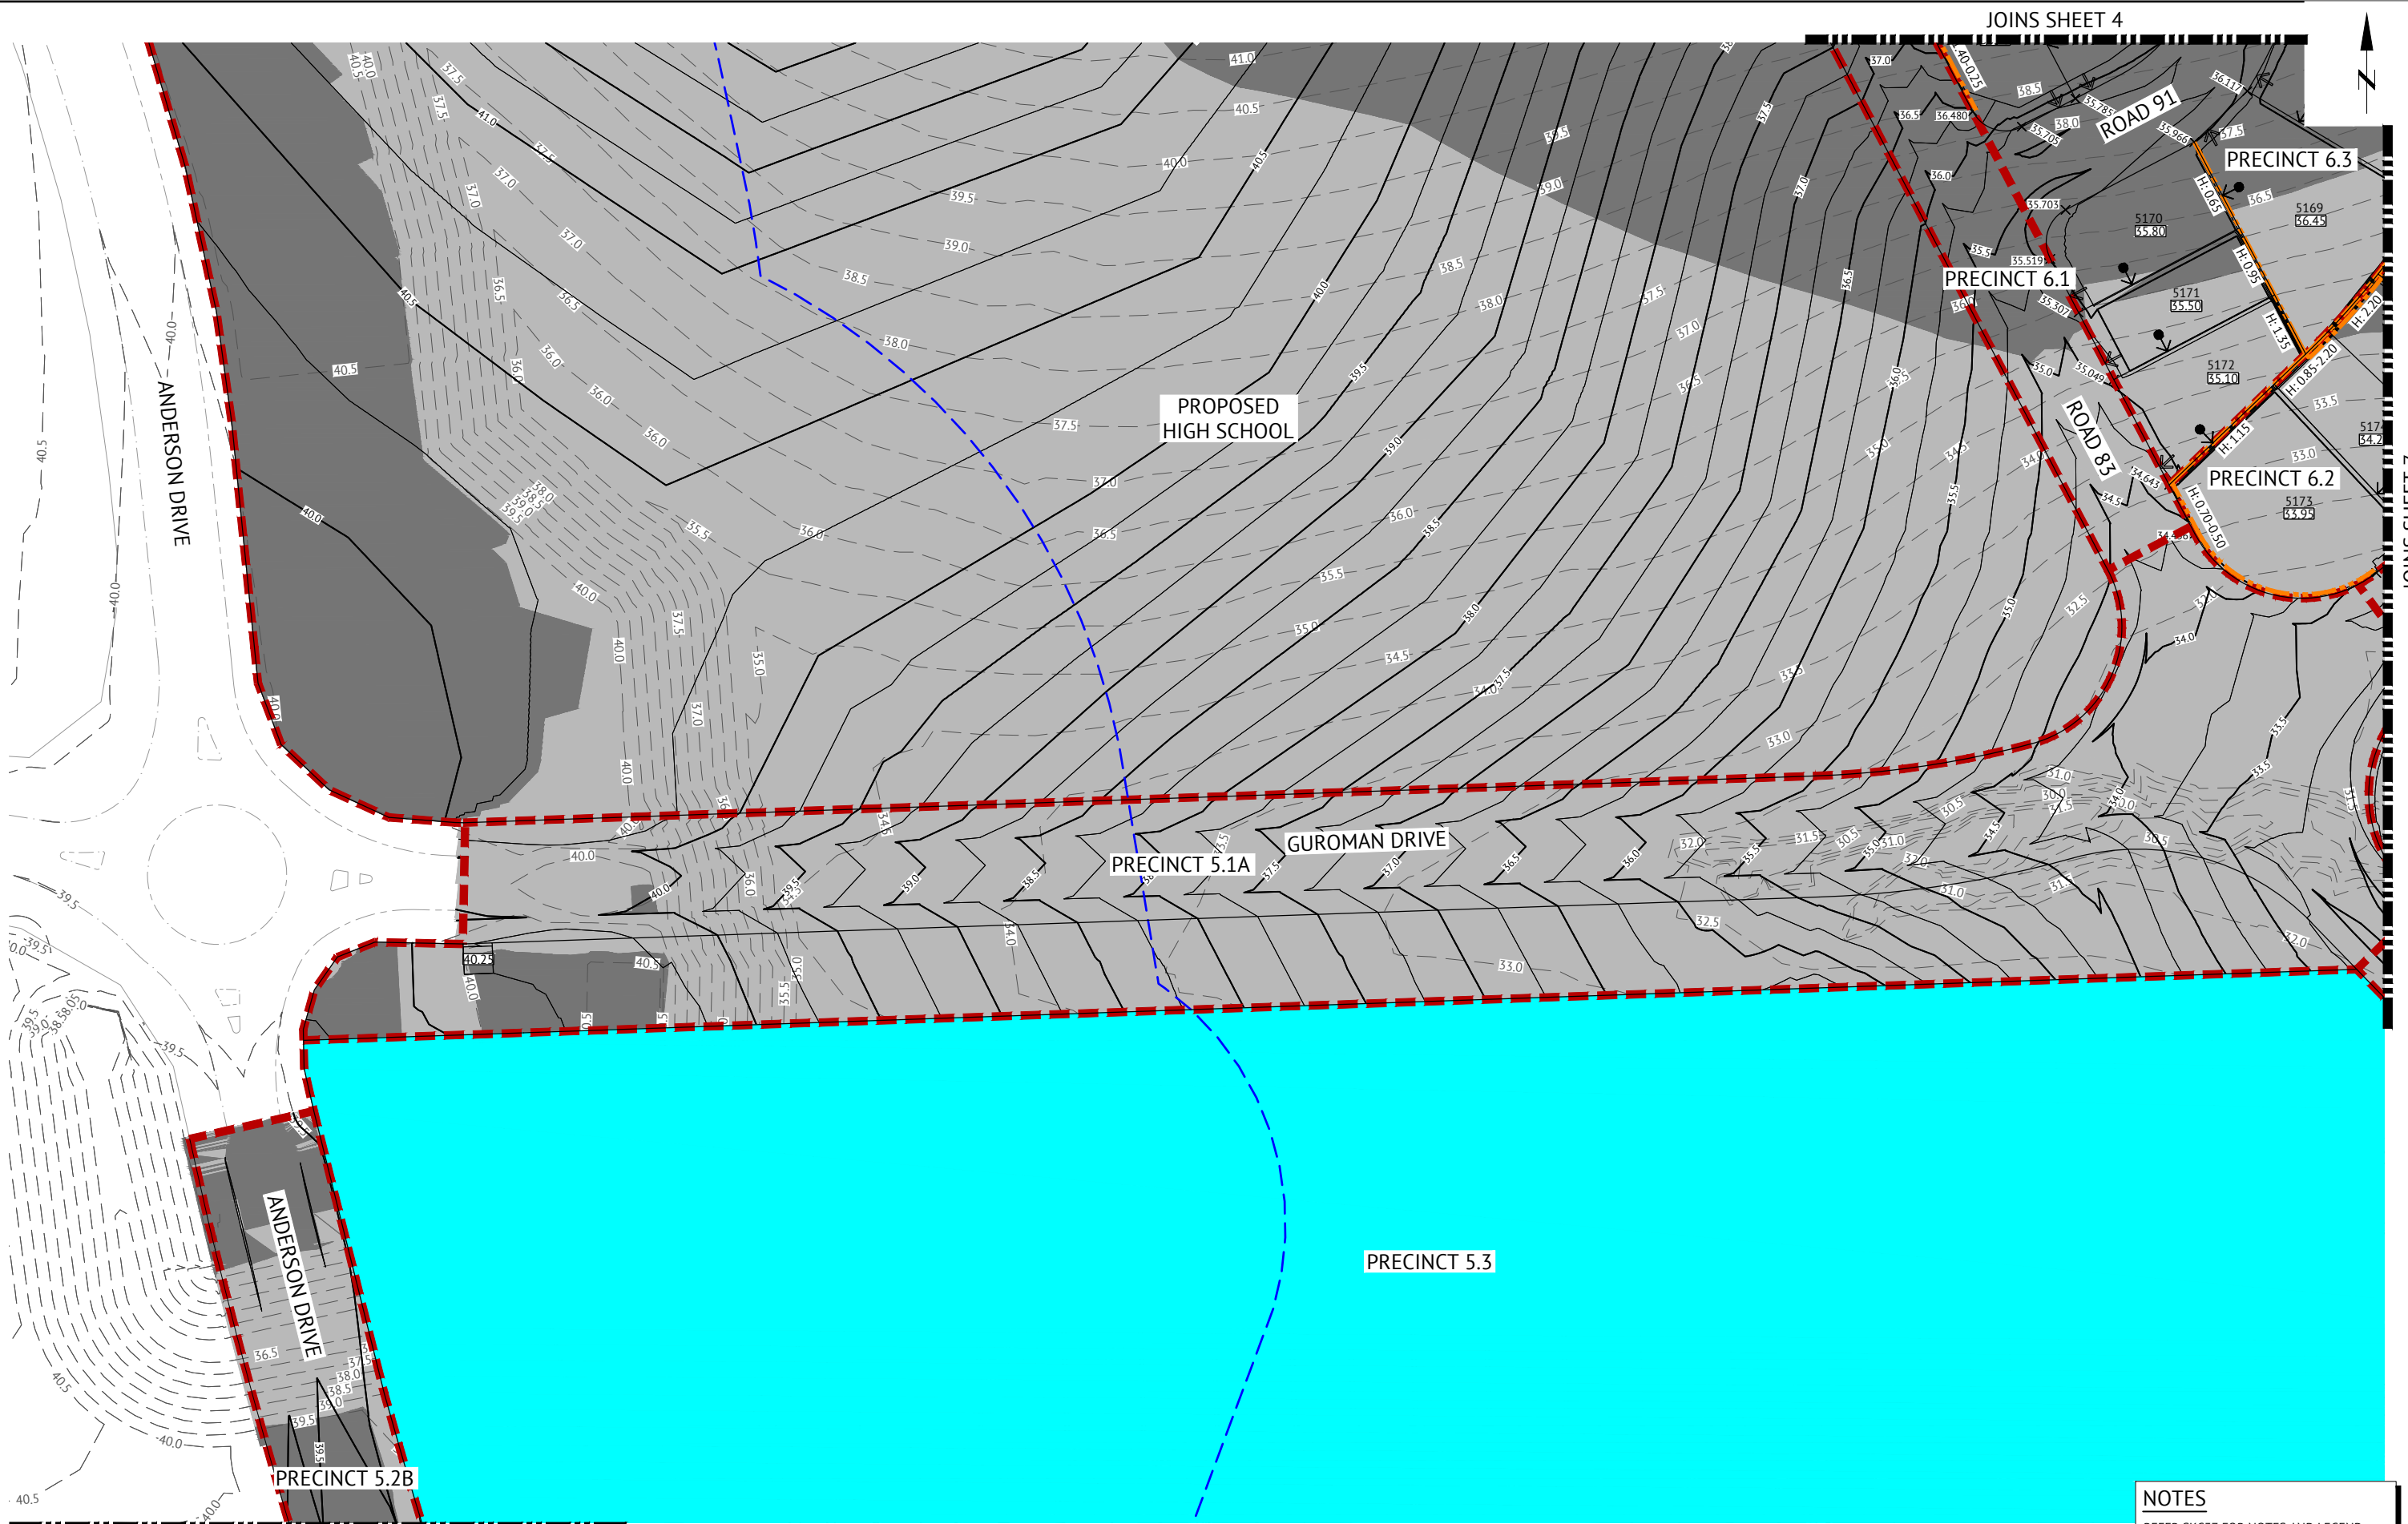

NOTES
REFER SKC37 FOR NOTES AND LEGEND

PRELIMINARY - NOT FOR CONSTRUCTION

DATE	REV	DESCRIPTION	REVISIONS	KK	NS	REC	APP
22/05/2024	4	ADDED PMT PADS		KK			
08/05/2024	3	UPDATED LAYOUT AND EARTHWORKS		KK	NS		
13/12/2023	2	UPDATED PRECINCT BOUNDARIES AND PRECINCT NUMBERS		KK	NS		
25/10/2023	1	PRELIMINARY - NOT FOR CONSTRUCTION		KK	NS		




BRISBANE OFFICE
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BRISBANE, QLD 4000
PH: (07) 3253 2222
WEB: www.premise.com.au

DESIGNED
KLYNT KIWANG
CHECKED
ANDREW LANGDON
PROJECT MANAGER
NICK SOMERVILLE
ENGINEERING CERTIFICATION
PATRICK BRADY RPEQ 7112

SCALE
0 10 20 30m
SCALE 1:500 (A1)
ORIGINAL SHEET SIZE A1

CLIENT
MIRVAC QLD PTY LTD
PROJECT
EVERLEIGH ROL13 SUBDIVISION DEVELOPMENT
LOCATION
TEVIOT ROAD, GREENBANK
SHEET TITLE
PRELIMINARY EARTHWORKS LAYOUT PLAN - SHEET 6

JOB CODE
MIR-1300
SHEET NUMBER
SKC42
REV
4

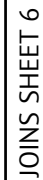

NOTES

REFER SKC37 FOR NOTES AND LEGEND

PRELIMINARY - NOT FOR CONSTRUCTION


05/11/2024	5	UPDATED EARTHWORKS AS PER CHANGES TO LOT LAYOUT	KK	NS
22/05/2024	4	AMENDED BASIN LAYOUT	KK	NS
08/03/2024	3	UPDATED LAYOUT AND EARTHWORKS	KK	NS
13/12/2023	2	UPDATED PRECINCT BOUNDARIES AND PRECINCT NUMBERS	KK	NS
25/10/2023	1	PRELIMINARY - NOT FOR CONSTRUCTION	KK	NS
DATE	REV	DESCRIPTION	REC	APP
REVISIONS				



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DESIGNED KLYNT KIWANG	
CHECKED ANDREW LANGDON	
PROJECT MANAGER NICK SOMERVILLE	
ENGINEERING CERTIFICATION	
PATRICK BRADY	RPEQ 7112

SCALE




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SCALE 1:500 (A1)

ORIGINAL SHEET SIZE A1

CLIENT		MIRVAC QLD PTY LTD		JOB CODE	
PROJECT		EVERLEIGH ROL13 SUBDIVISION DEVELOPMENT		MIR-1300	
LOCATION		TEVIOT ROAD, GREENBANK		SHEET NUMBER	
SHEET TITLE		PRELIMINARY EARTHWORKS LAYOUT PLAN - SHEET 7		REV	
				SKC43	
				5	

CODE
 MIR-1300
 SHEET NUMBER
 SKC43

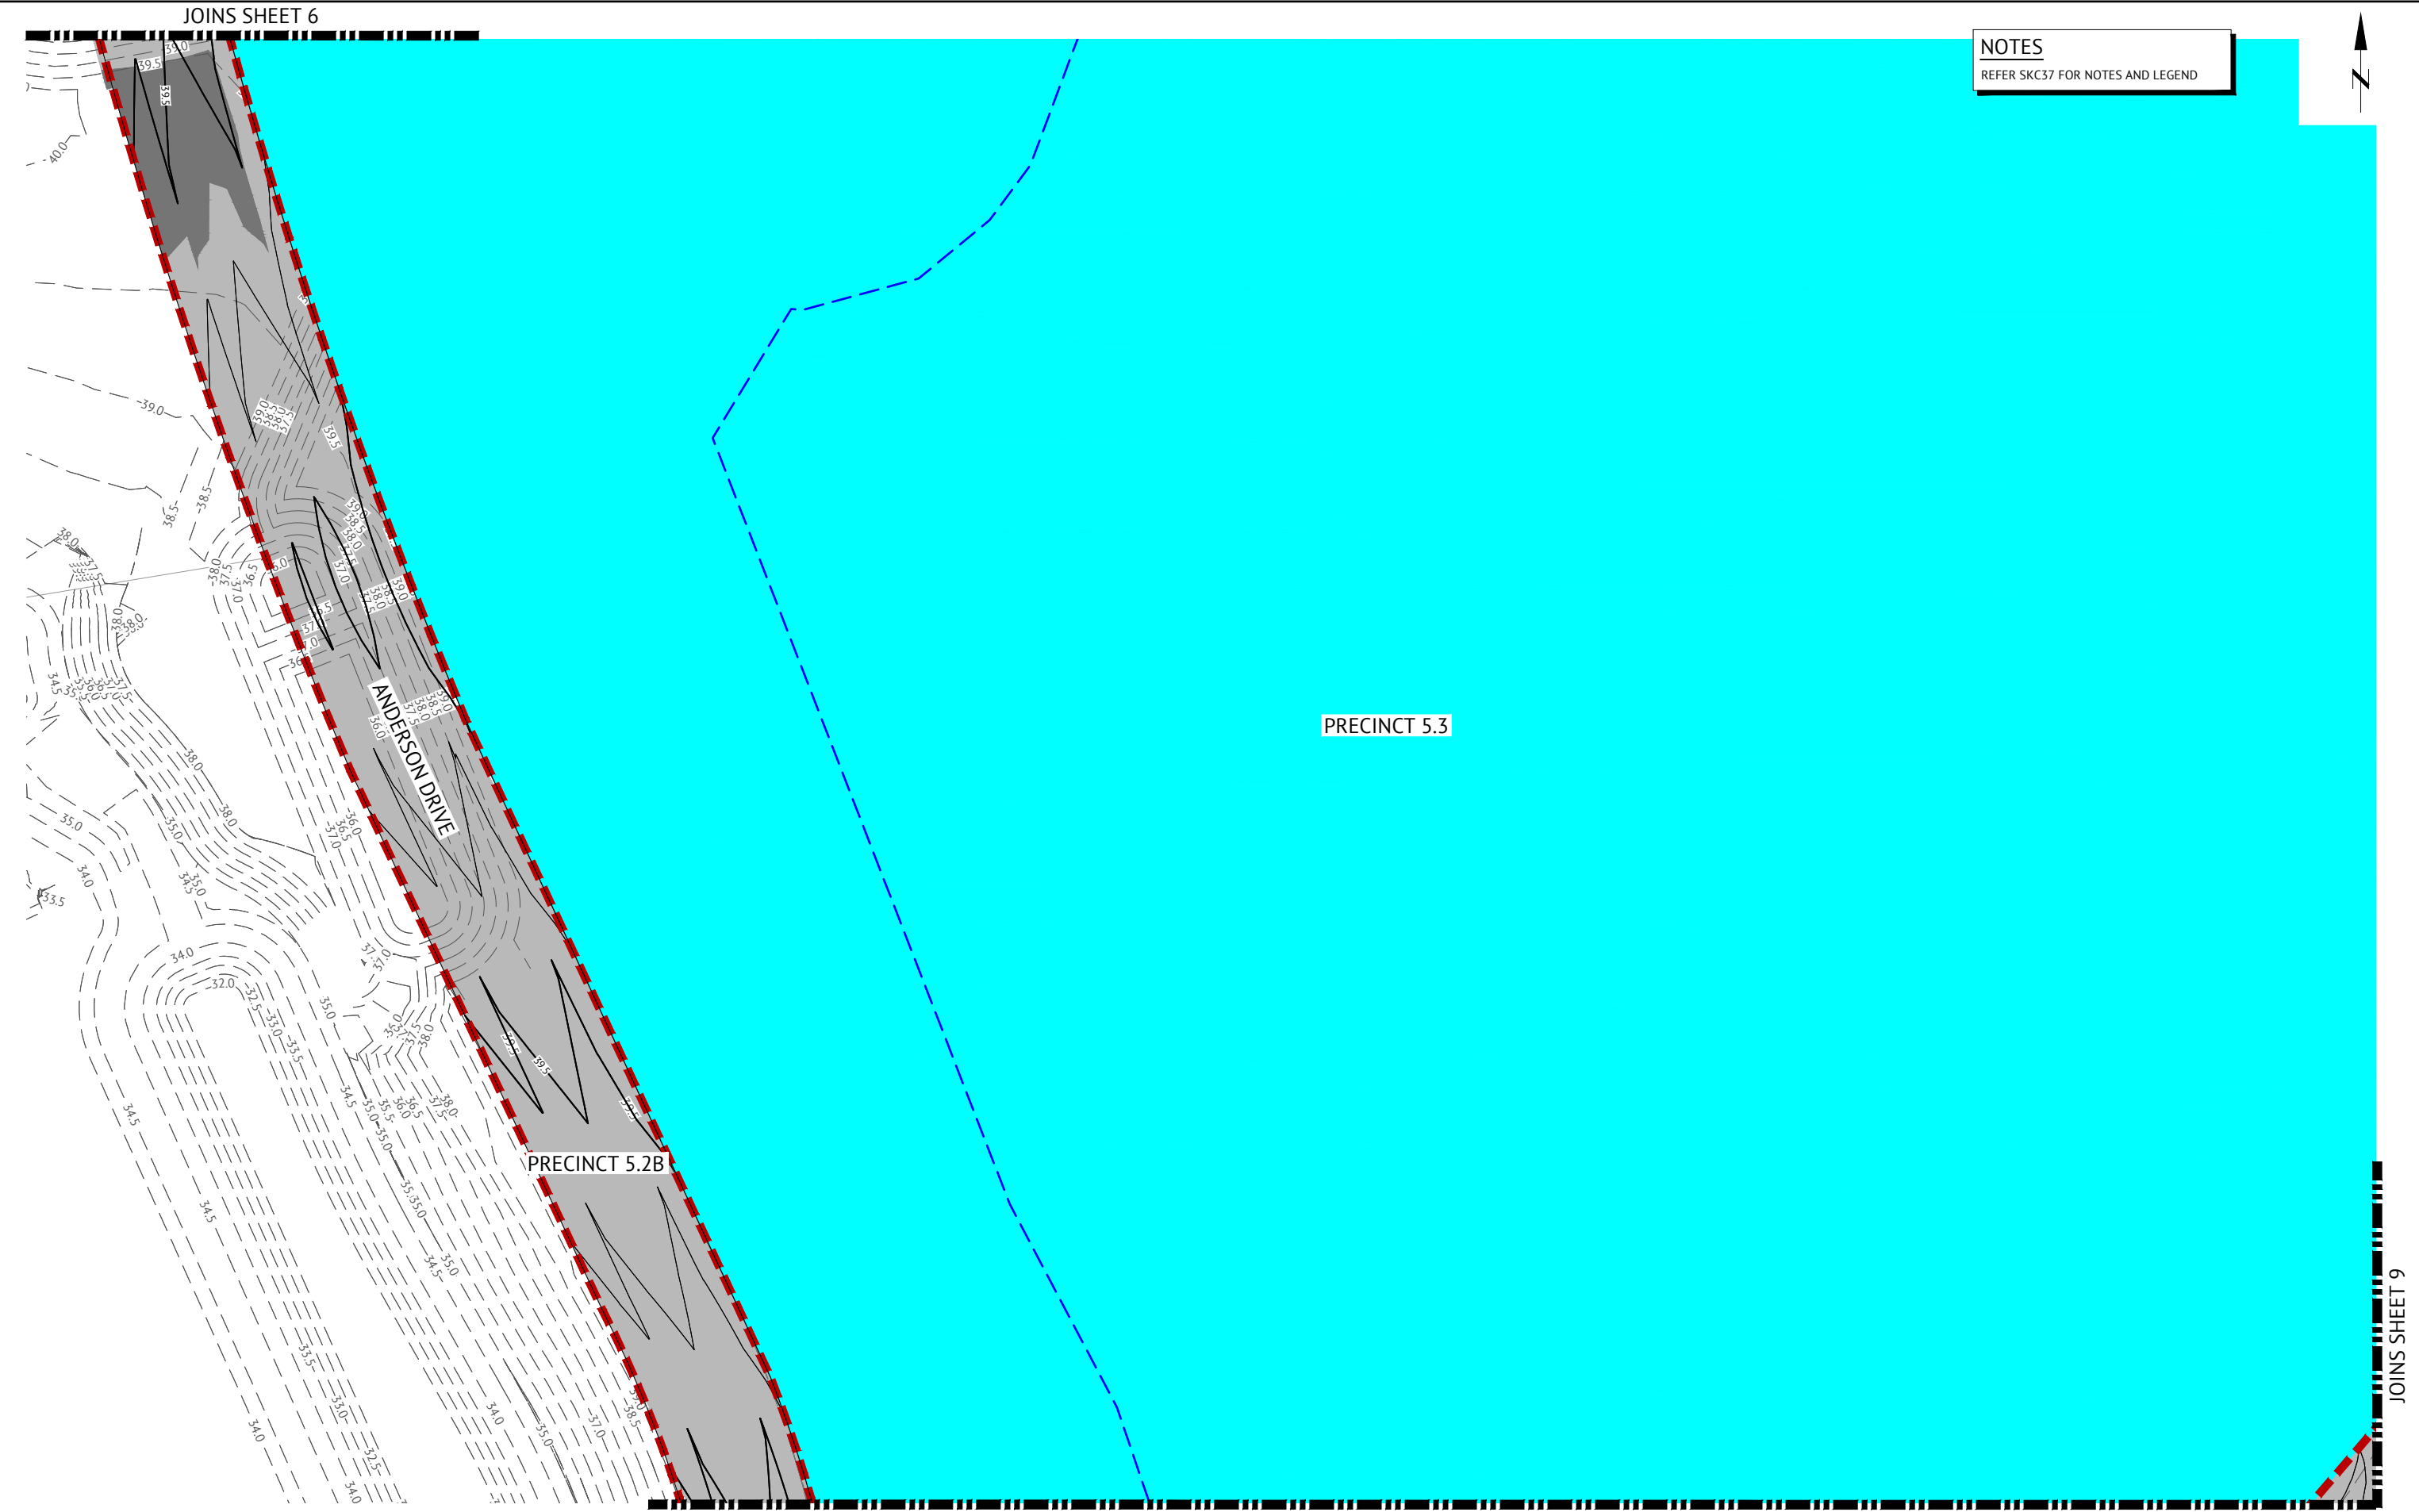

NOTES
REFER SKC37 FOR NOTES AND LEGEND

PRELIMINARY - NOT FOR CONSTRUCTION					
08/05/2024	3	UPDATED LAYOUT AND EARTHWORKS	KK	NS	
13/12/2023	2	UPDATED PRECINCT BOUNDARIES AND PRECINCT NUMBERS	KK	NS	
25/10/2023	1	PRELIMINARY - NOT FOR CONSTRUCTION	KK	NS	
DATE	REV	DESCRIPTION	REC	APP	
REVISIONS					




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DESIGNED KLYNT KIWANG
CHECKED ANDREW LANGDON
PROJECT MANAGER NICK SOMERVILLE
ENGINEERING CERTIFICATION
PATRICK BRADY

RPEQ 7112

SCALE




SCALE 1:500 (A1)

ORIGINAL SHEET SIZE A1

CLIENT	MIRVAC QLD PTY LTD
PROJECT	EVERLEIGH ROL13 SUBDIVISION DEVELOPMENT
LOCATION	TEVIOT ROAD, GREENBANK
SHEET TITLE	PRELIMINARY EARTHWORKS LAYOUT PLAN - SHEET 8

JOB CODE	MIR-1300
SHEET NUMBER	SKC44
REV	3

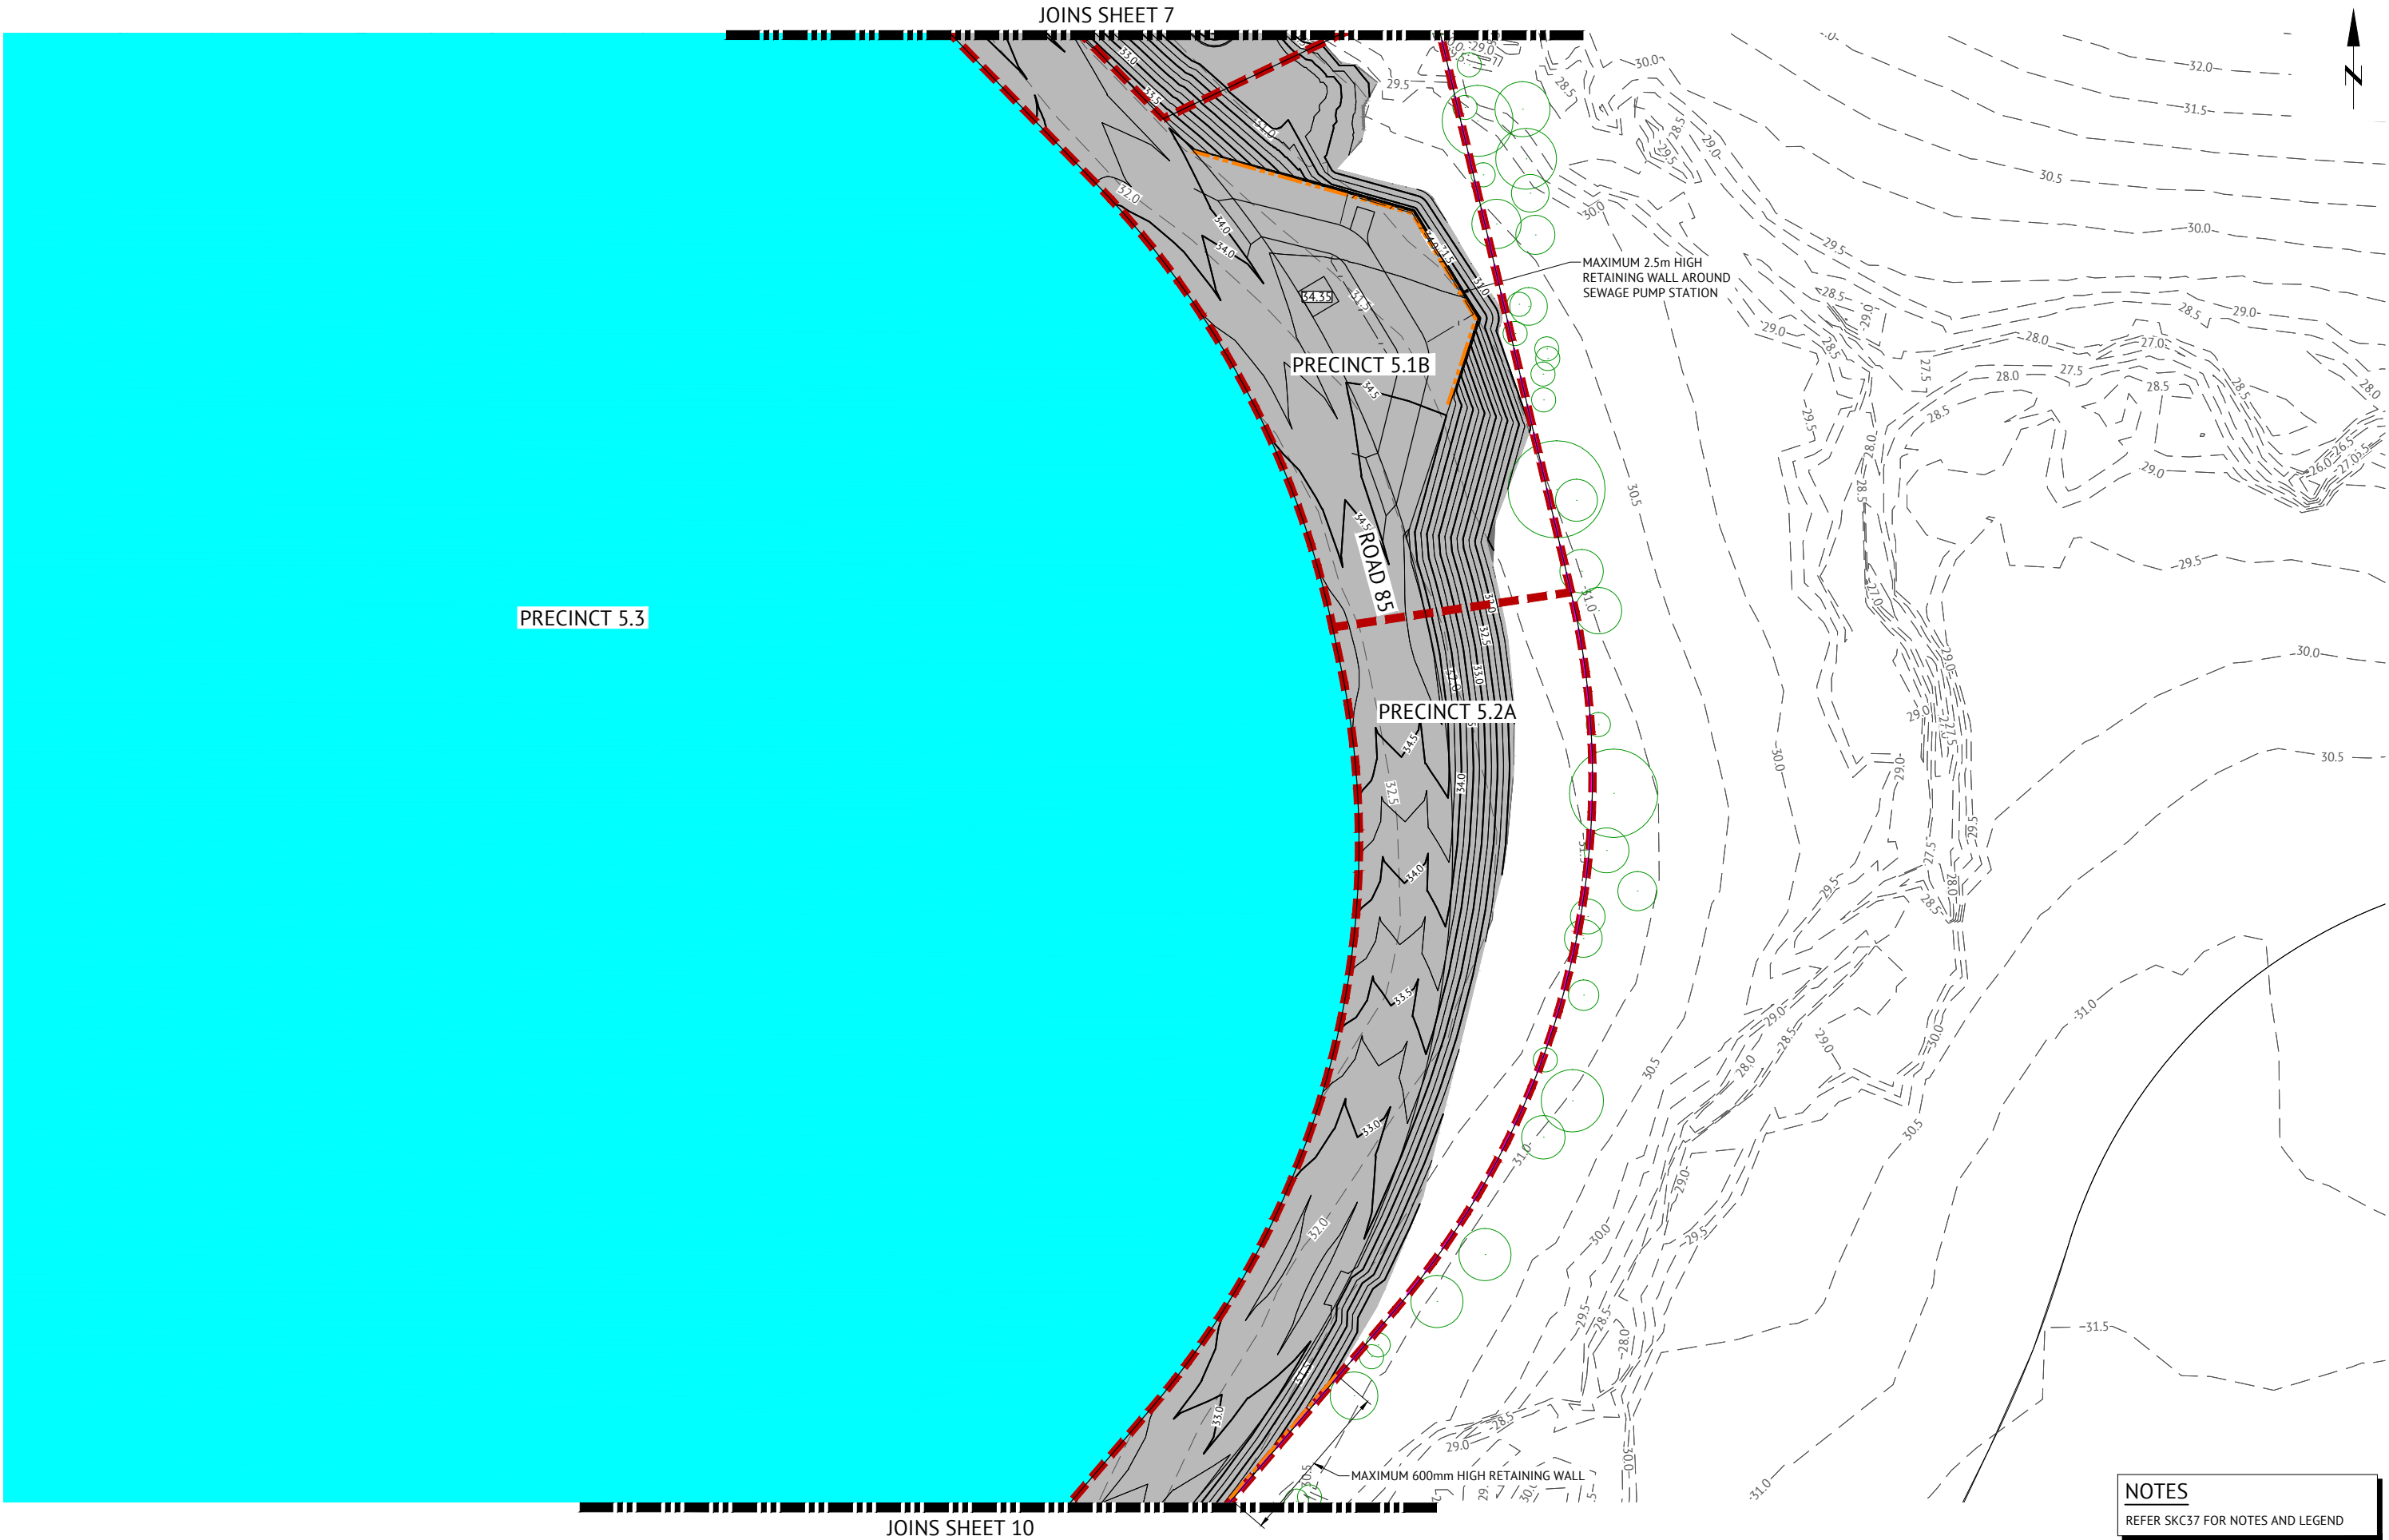

NOTES
REFER SKC37 FOR NOTES AND LEGEND

PRELIMINARY - NOT FOR CONSTRUCTION

DATE	REV	DESCRIPTION	REC	APP
05/11/2024	4	UPDATED EARTHWORKS AS PER CHANGES TO PRECINCT BOUNDARIES	KK	NS
08/05/2024	3	UPDATED LAYOUT AND EARTHWORKS	KK	NS
13/12/2023	2	UPDATED PRECINCT BOUNDARIES AND PRECINCT NUMBERS	KK	NS
25/10/2023	1	PRELIMINARY - NOT FOR CONSTRUCTION	KK	NS




BRISBANE OFFICE
LEVEL 11, 300 ADELAIDE STREET
BRISBANE, QLD 4000
PH: (07) 3253 2222
WEB: www.premise.com.au


DESIGNED
KLYNT KIWANG
CHECKED
ANDREW LANGDON
PROJECT MANAGER
NICK SOMERVILLE
ENGINEERING CERTIFICATION
PATRICK BRADY RPEQ 7112

SCALE
0 10 20 30m
SCALE 1:500 (A1)
ORIGINAL SHEET SIZE A1

CLIENT
MIRVAC QLD PTY LTD
PROJECT
EVERLEIGH ROL13 SUBDIVISION DEVELOPMENT
LOCATION
TEVIOT ROAD, GREENBANK
SHEET TITLE
PRELIMINARY EARTHWORKS LAYOUT PLAN - SHEET 9

JOB CODE
MIR-1300
SHEET NUMBER
SKC45
REV
4

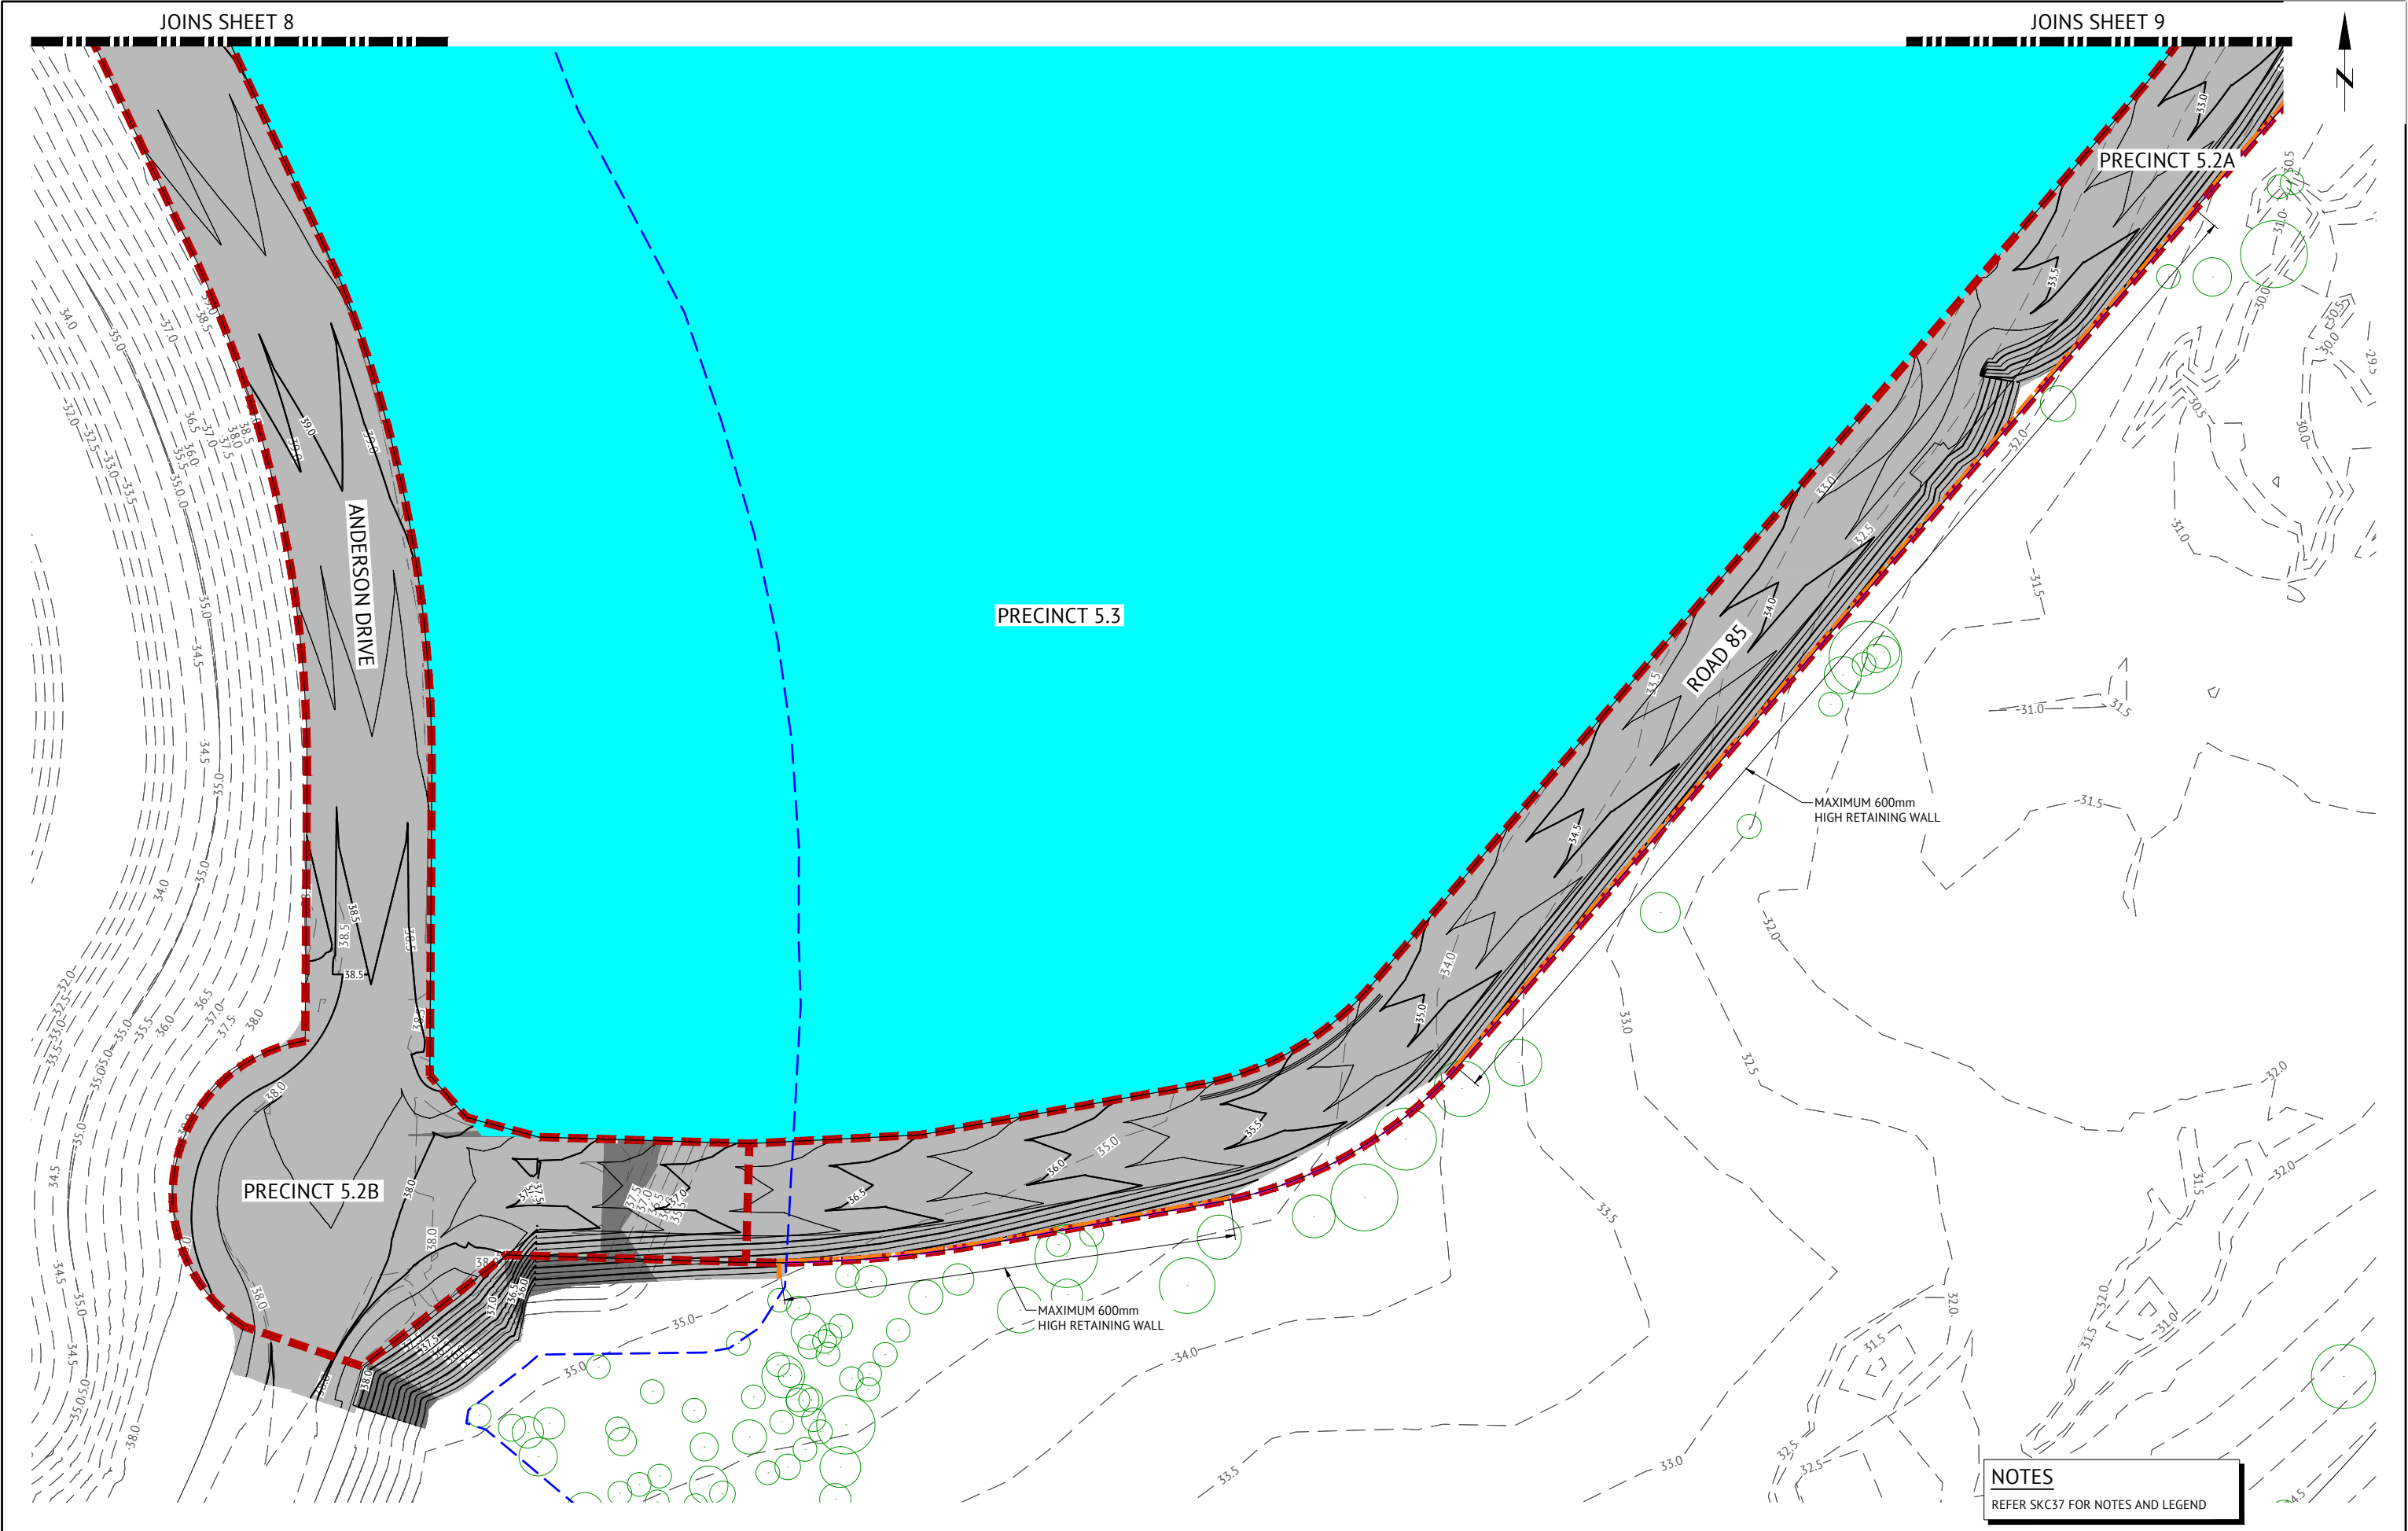


PRELIMINARY - NOT FOR CONSTRUCTION								BRISBANE OFFICE		DESIGNED KLYNT KIWANG		SCALE		CLIENT MIRVAC QLD PTY LTD		JOB CODE	
								LEVEL 11, 300 ADELAIDE STREET		CHECKED ANDREW LANGDON				PROJECT EVERLEIGH ROL13 SUBDIVISION DEVELOPMENT		MIR-1300	
05/11/2024 4 UPDATED EARTHWORKS AS PER CHANGES TO PRECINCT BOUNDARIES KK NS								BRISBANE, QLD 4000		PROJECT MANAGER NICK SOMERVILLE		SCALE 1:500 (A1)		LOCATION TEVIOT ROAD, GREENBANK		SHEET NUMBER	
08/03/2024 3 UPDATED LAYOUT AND EARTHWORKS KK NS								PH: (07) 3253 2222		ENGINEERING CERTIFICATION		ORIGINAL SHEET SIZE A1		PRELIMINARY EARTHWORKS LAYOUT PLAN - SHEET 10		REV	
13/12/2023 2 UPDATED PRECINCT BOUNDARIES AND PRECINCT NUMBERS KK NS								WEB: www.premise.com.au		PATRICK BRADY RPEQ 7112						SKC46	
25/10/2023 1 PRELIMINARY - NOT FOR CONSTRUCTION KK NS																4	
DATE REV DESCRIPTION REVISIONS REC APP																	

APPENDIX C

ROAD HEIRARCHY PLAN



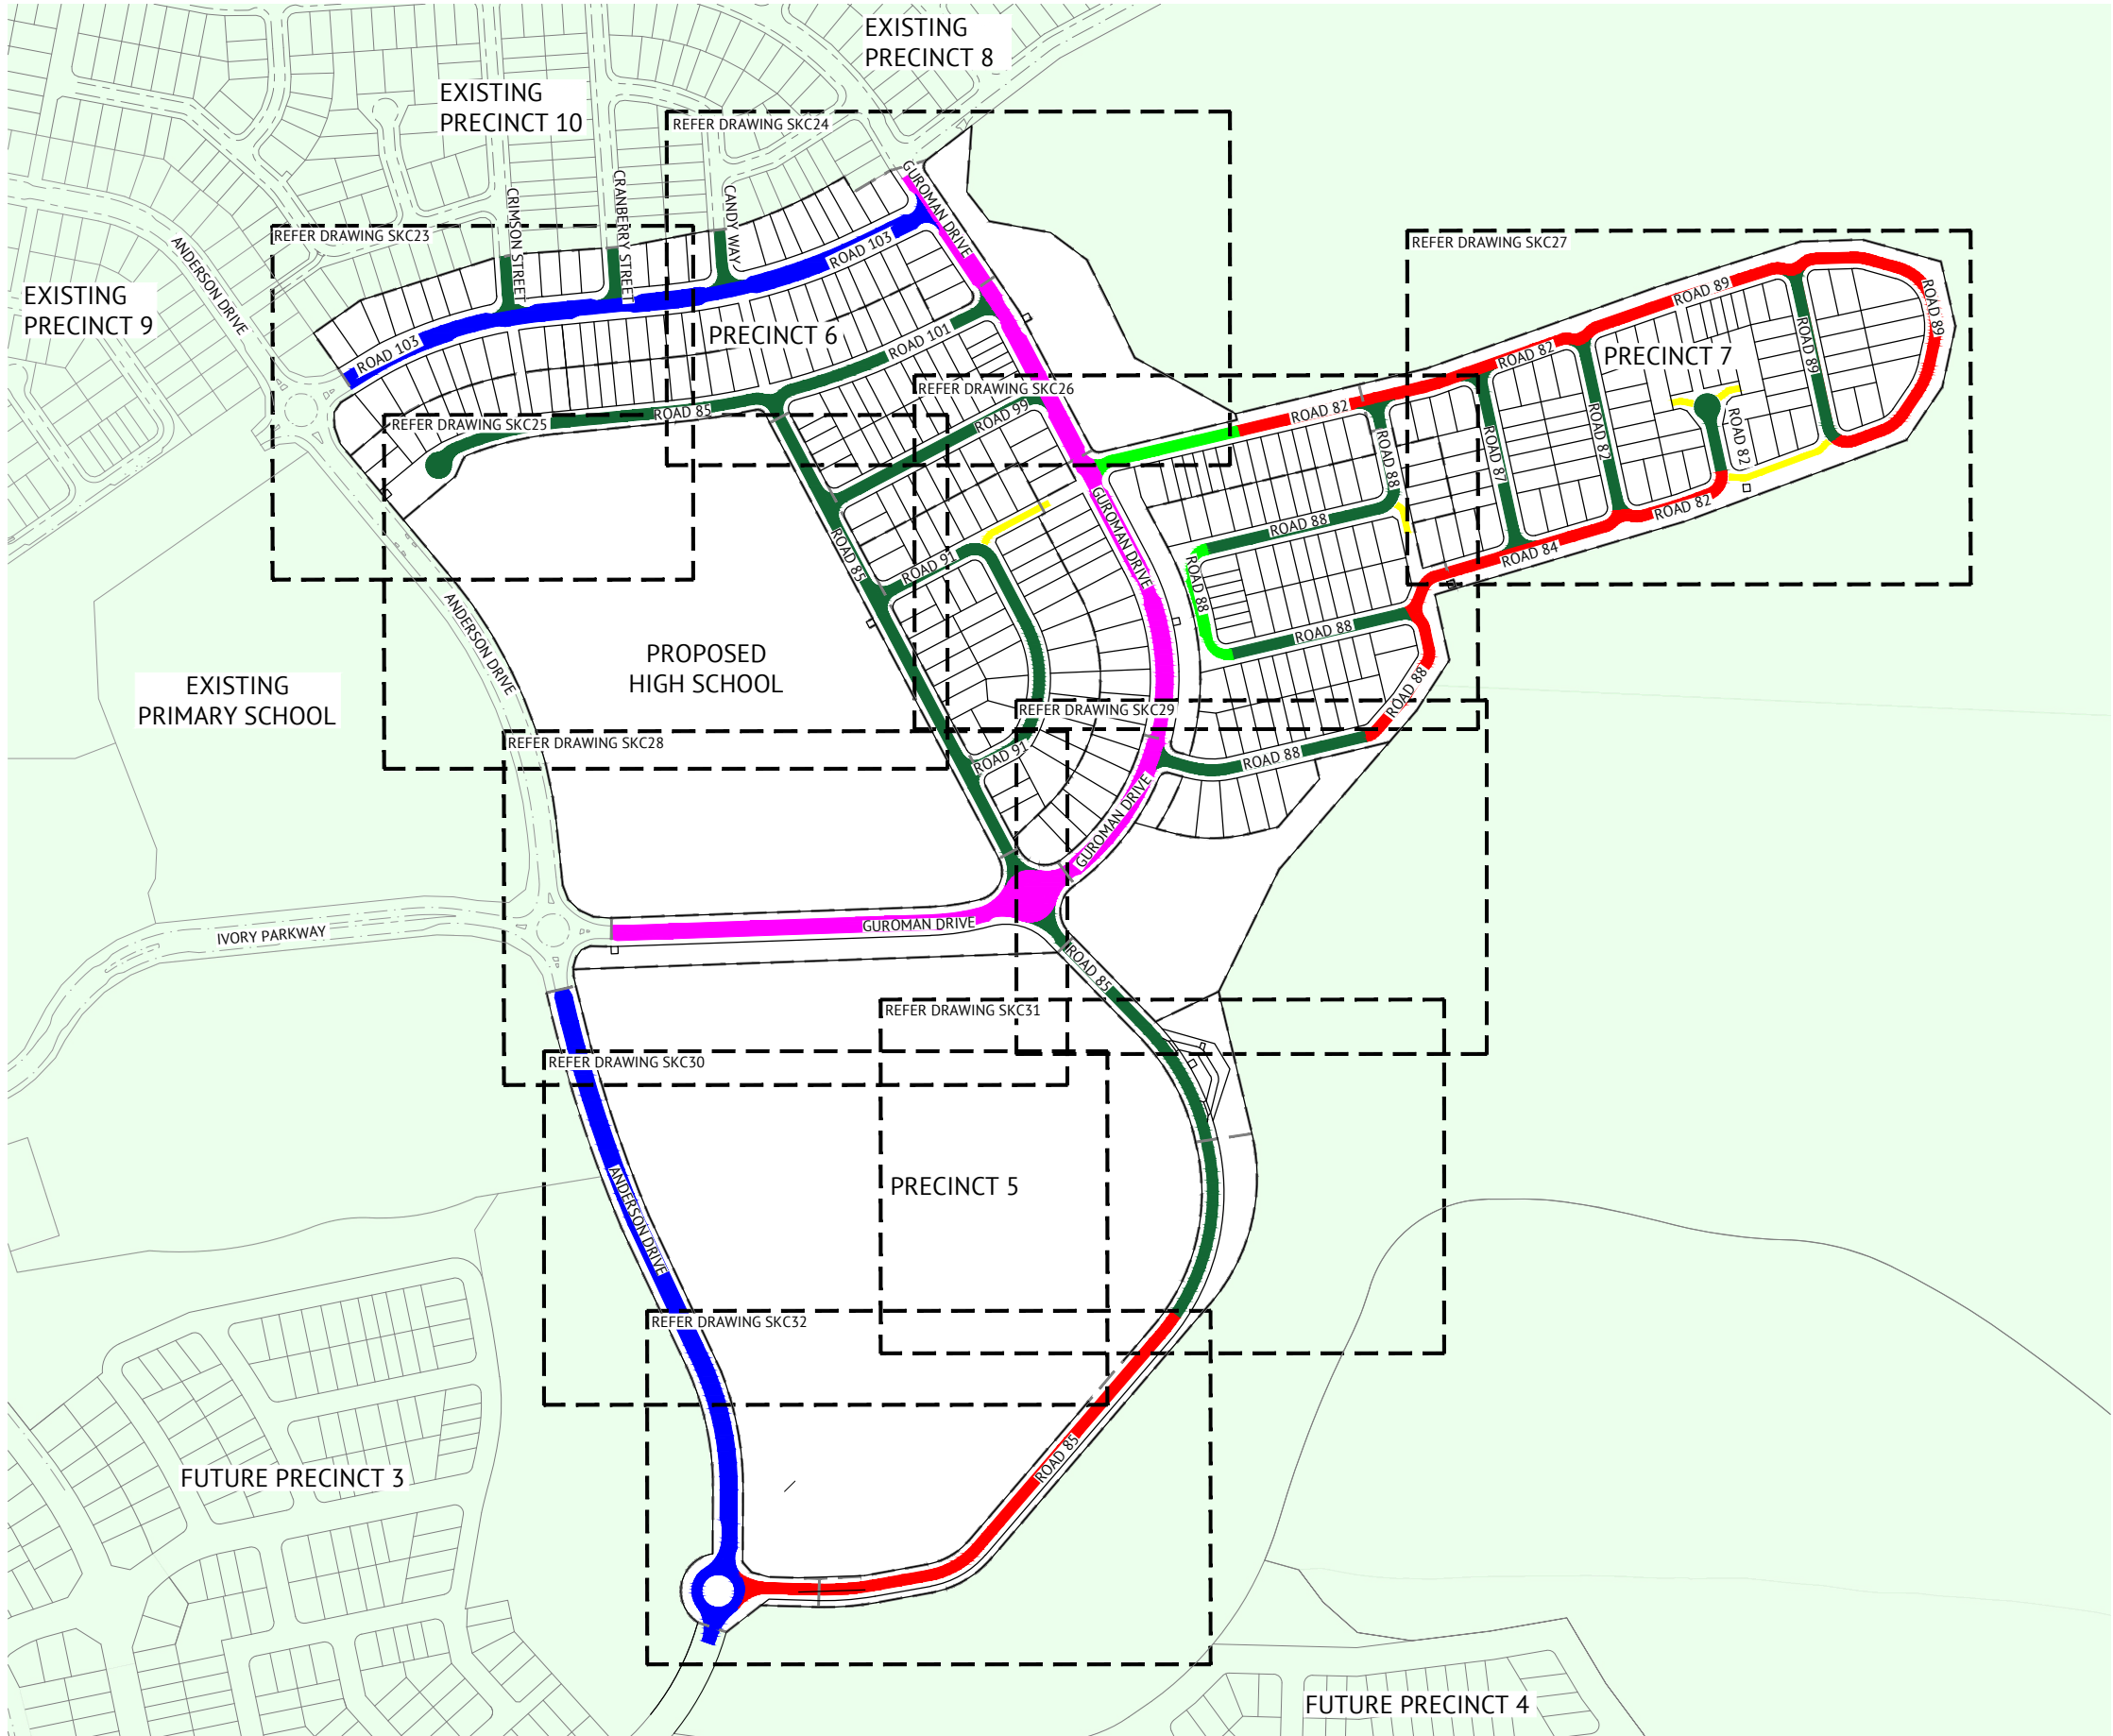

LEGEND - ROAD HEIRARCHY

- NEIGHBOURHOOD CONNECTOR 1
- NEIGHBOURHOOD CONNECTOR 2
- ACCESS STREET (TYPICAL)
- ACCESS STREET (PARK)
- ACCESS STREET (CONSERVATION)
- DRIVEWAY



PRELIMINARY - NOT FOR CONSTRUCTION					
05/11/2024	3	AMENDED ROAD AS PER CHANGES TO LOT LAYOUT	KK	NS	
21/05/2024	2	UPDATED LOT LAYOUT	KK	NS	
28/09/2023	1	PRELIMINARY - NOT FOR CONSTRUCTION	KK	NS	
DATE	REV	DESCRIPTION	REC	APP	
REVISIONS					



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DESIGNED
KLYNT KIWANG


CHECKED
ANDREW LANGDON

PROJECT MANAGER
NICK SOMERVILLE

ENGINEERING CERTIFICATION

PATRICK BRADY RPEQ 7112

SCALE



SCALE 1:2500 (A1)

ORIGINAL SHEET SIZE A1

CLIENT	MIRVAC QLD PTY LTD
PROJECT	EVERLEIGH ROL13 SUBDIVISION DEVELOPMENT
LOCATION	TEVIOT ROAD, GREENBANK
SHEET TITLE	ROAD HEIRARCHY PLAN

JOB CODE	MIR-1300
SHEET NUMBER	SKC22
REV	3

APPENDIX D

INTERNAL ROAD FUNCTIONAL PLANS





NOTE:
REFER SKC23 FOR LEGEND.




PRELIMINARY - NOT FOR CONSTRUCTION					
DATE	REV	DESCRIPTION	REC	APP	REVISIONS
05/11/2024	4	AMENDED ROAD AS PER CHANGES TO LOT LAYOUT	KK	NS	
22/05/2024	3	ADDED LANDSCAPE FOOTPATH AND PMT LOCATIONS	KK	NS	
21/05/2024	2	UPDATED LOT LAYOUT	KK	NS	
28/09/2023	1	PRELIMINARY - NOT FOR CONSTRUCTION	KK	NS	




BRISBANE OFFICE
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BRISBANE, QLD 4000
PH: (07) 3253 2222
WEB: www.premise.com.au

DESIGNED
KLYNT KIWANG
CHECKED
ANDREW LANGDON
PROJECT MANAGER
NICK SOMERVILLE
ENGINEERING CERTIFICATION
PATRICK BRADY RPEQ 7112

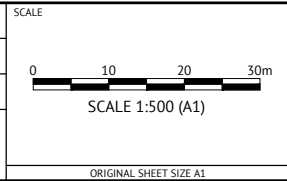

CLIENT		MIRVAC QLD PTY LTD
PROJECT		EVERLEIGH ROL13 SUBDIVISION DEVELOPMENT
LOCATION		TEVIOT ROAD, GREENBANK
SHEET TITLE		ROAD FUNCTIONAL LAYOUT - SHEET 2

JOB CODE		MIR-1300
SHEET NUMBER	REV	SKC24 4

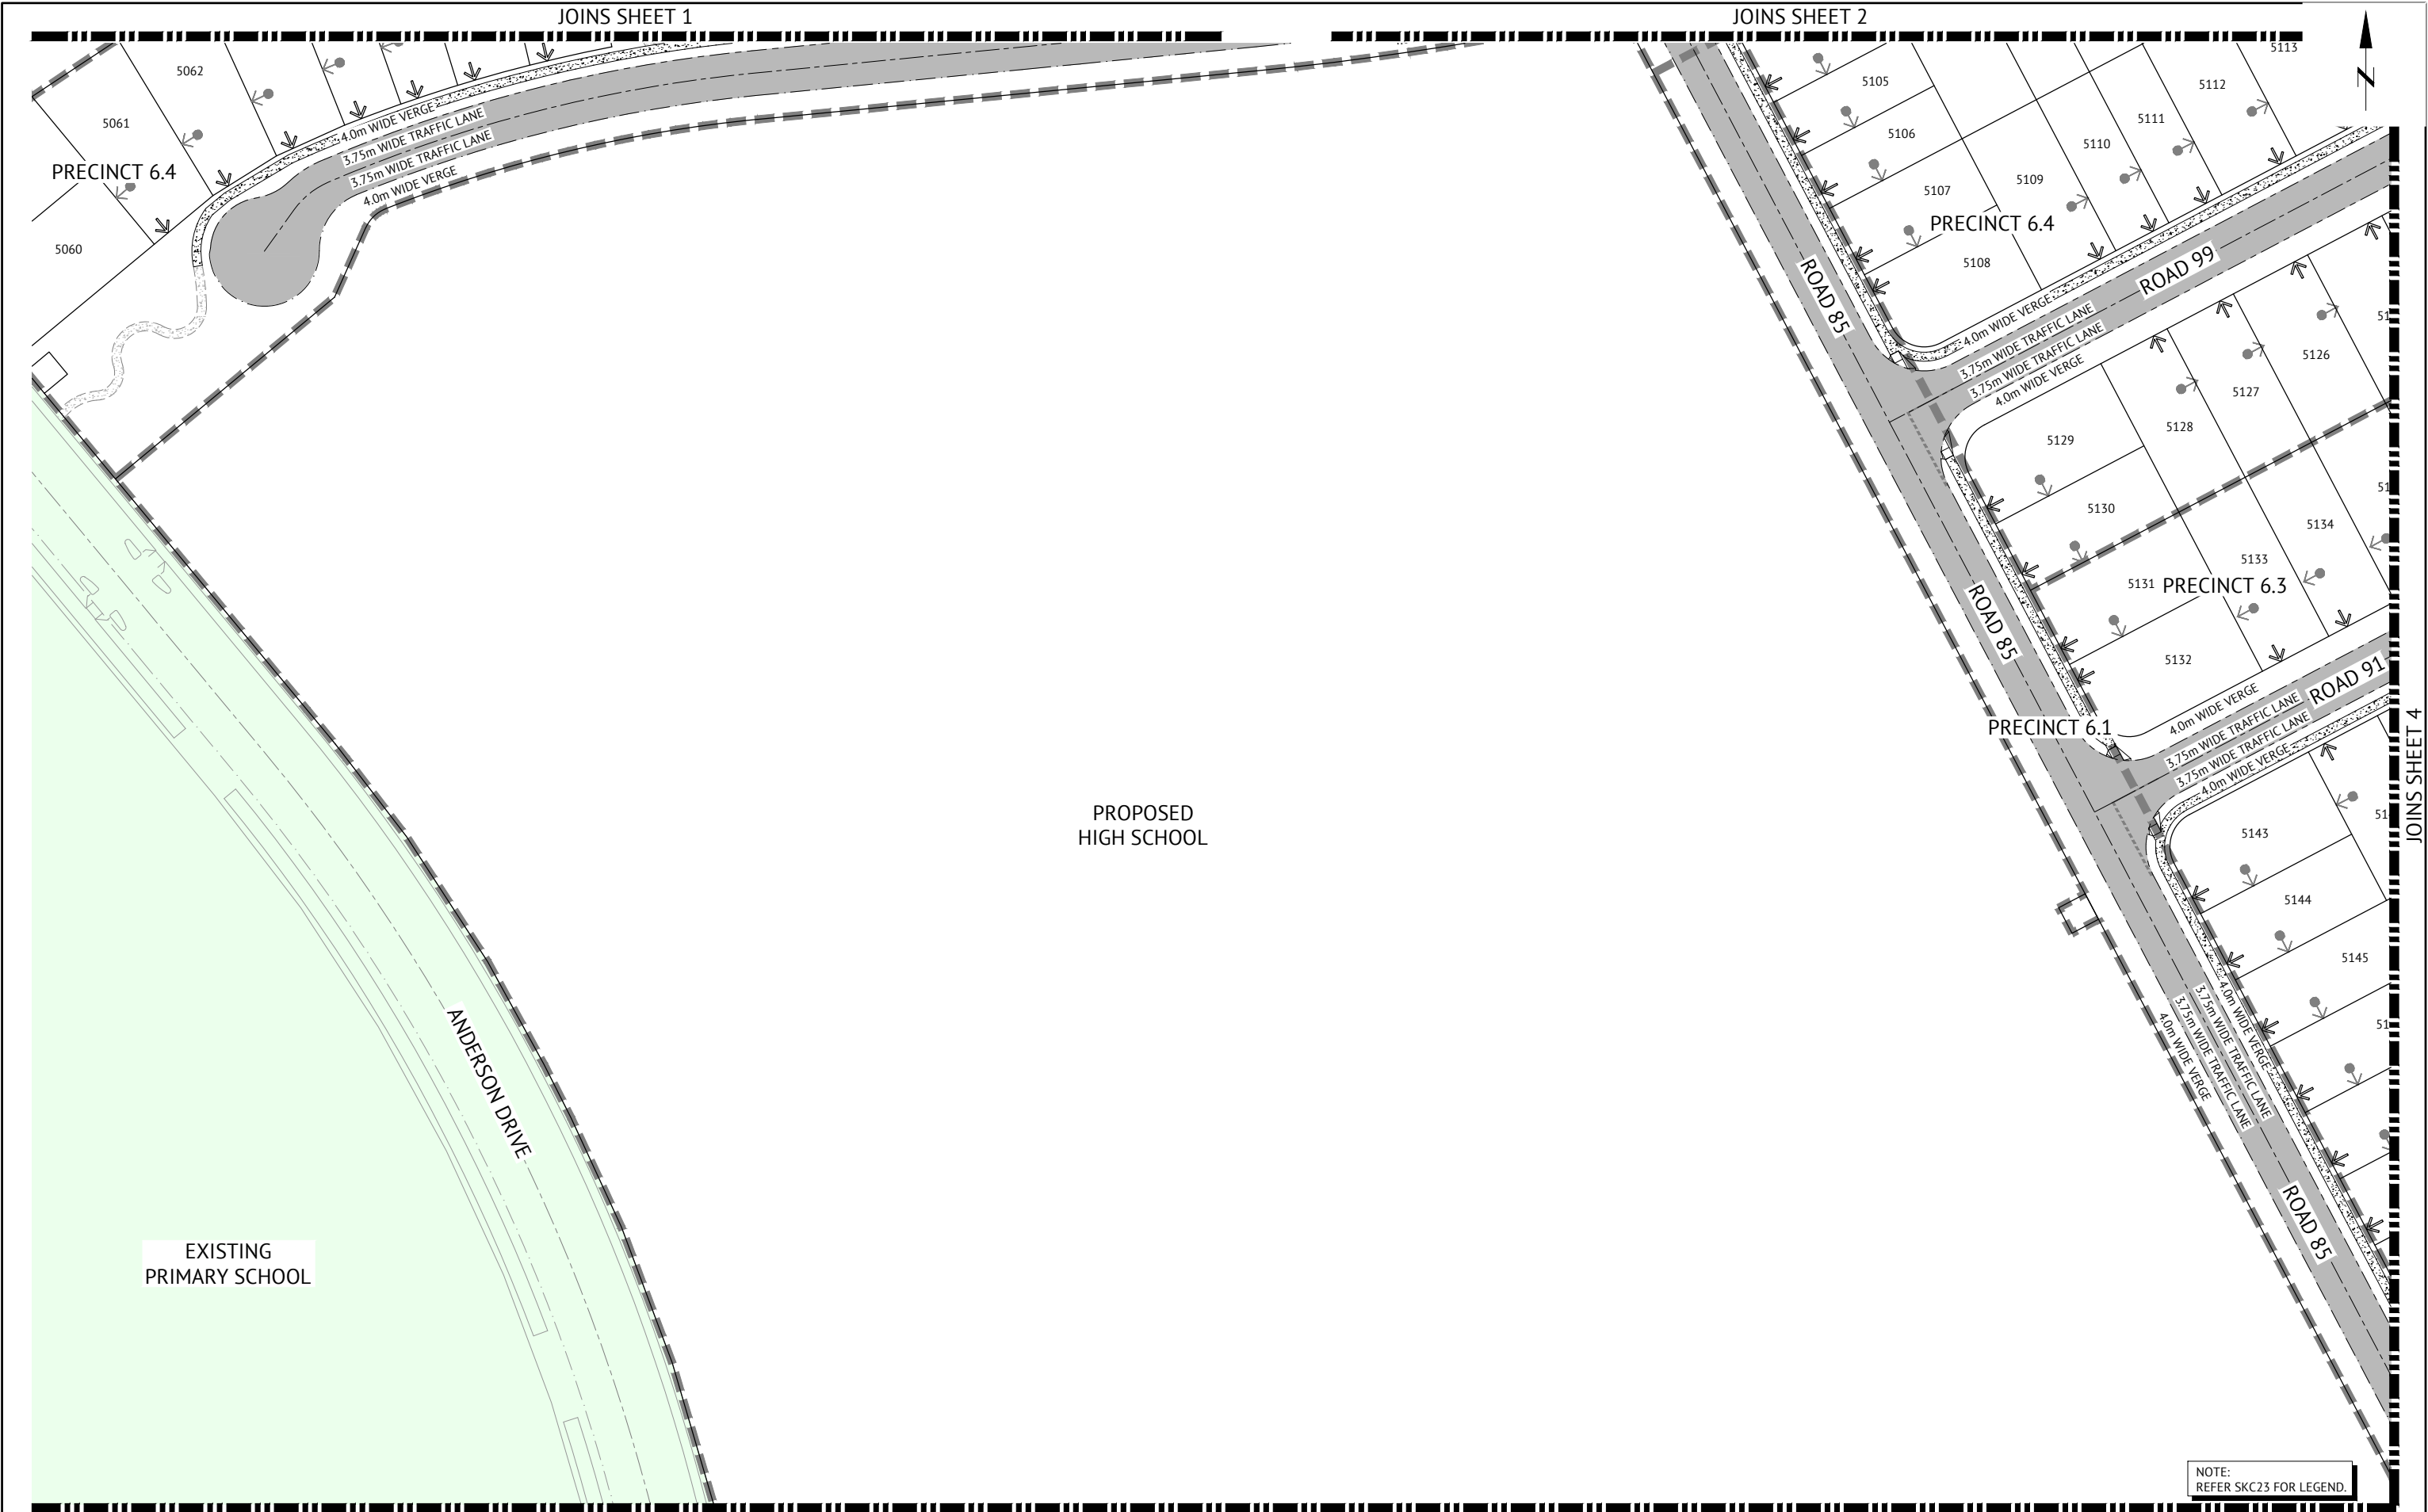

PRELIMINARY - NOT FOR CONSTRUCTION					
DATE	REV	DESCRIPTION	REC	APP	REVISIONS
22/05/2024	3	ADDED LANDSCAPE FOOTPATH AND PMT LOCATIONS	KK	NS	
21/05/2024	2	UPDATED LOT LAYOUT	KK	NS	
28/09/2023	1	PRELIMINARY - NOT FOR CONSTRUCTION	KK	NS	



BRISBANE OFFICE
LEVEL 11, 300 ADELAIDE STREET
BRISBANE, QLD 4000
PH: (07) 3253 2222
WEB: www.premise.com.au

DESIGNED
KLYNT KIWANG

CHECKED
ANDREW LANGDON


PROJECT MANAGER
NICK SOMERVILLE

ENGINEERING CERTIFICATION

PATRICK BRADY

RPEQ 7112

SCALE



SCALE 1:500 (A1)

ORIGINAL SHEET SIZE A1

CLIENT
MIRVAC QLD PTY LTD

PROJECT
EVERLEIGH ROL13 SUBDIVISION DEVELOPMENT


LOCATION
TEVIOT ROAD, GREENBANK

SHEET TITLE
ROAD FUNCTIONAL LAYOUT - SHEET 3


JOB CODE
MIR-1300

SHEET NUMBER
SKC25

REV
3

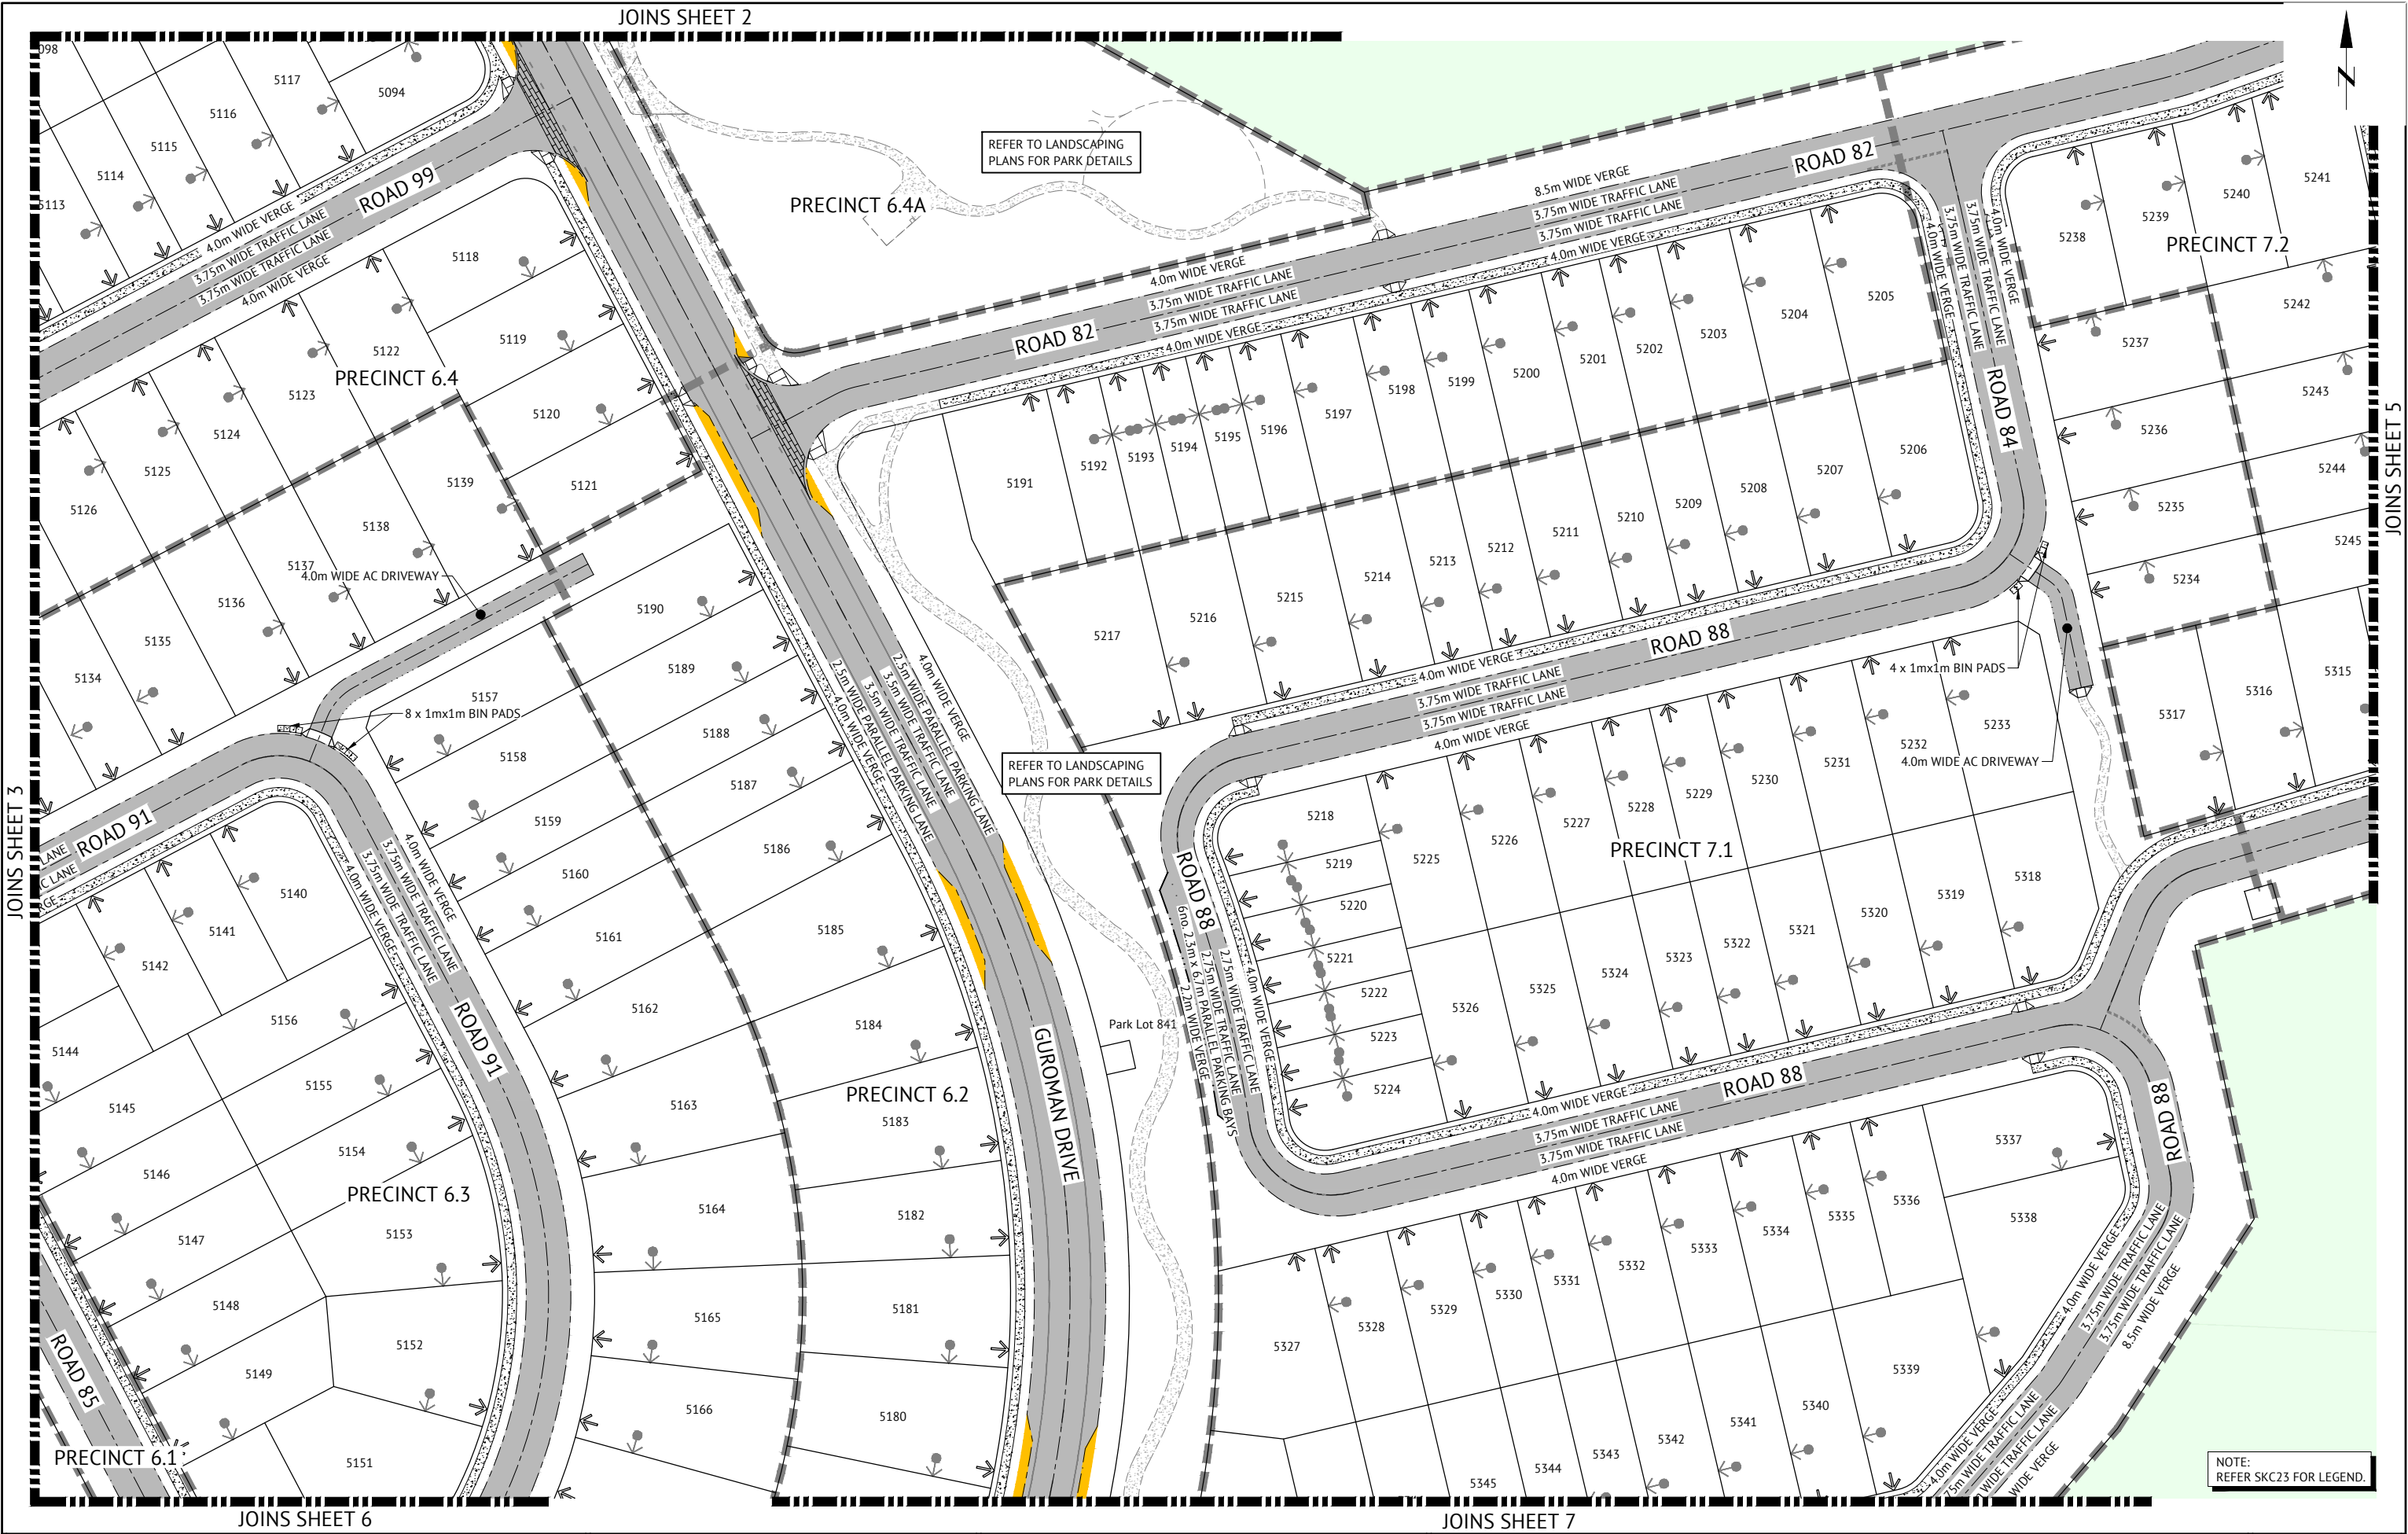

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21/05/2024	2	UPDATED LOT LAYOUT	KK	NS	
28/09/2023	1	PRELIMINARY - NOT FOR CONSTRUCTION	KK	NS	
DATE	REV	DESCRIPTION	REC	APP	
REVISIONS					



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CHECKED
ANDREW LANGDON

PROJECT MANAGER
NICK SOMERVILLE

ENGINEERING CERTIFICATION

PATRICK BRADY RPEQ 7112

SCALE

0 10 20 30m

SCALE 1:500 (A1)

ORIGINAL SHEET SIZE A1

CLIENT
MIRVAC QLD PTY LTD


PROJECT
EVERLEIGH ROL13 SUBDIVISION DEVELOPMENT

LOCATION
TEVIOT ROAD, GREENBANK

SHEET TITLE
ROAD FUNCTIONAL LAYOUT - SHEET 4

JOB CODE
MIR-1300

SHEET NUMBER	REV
SKC26	3

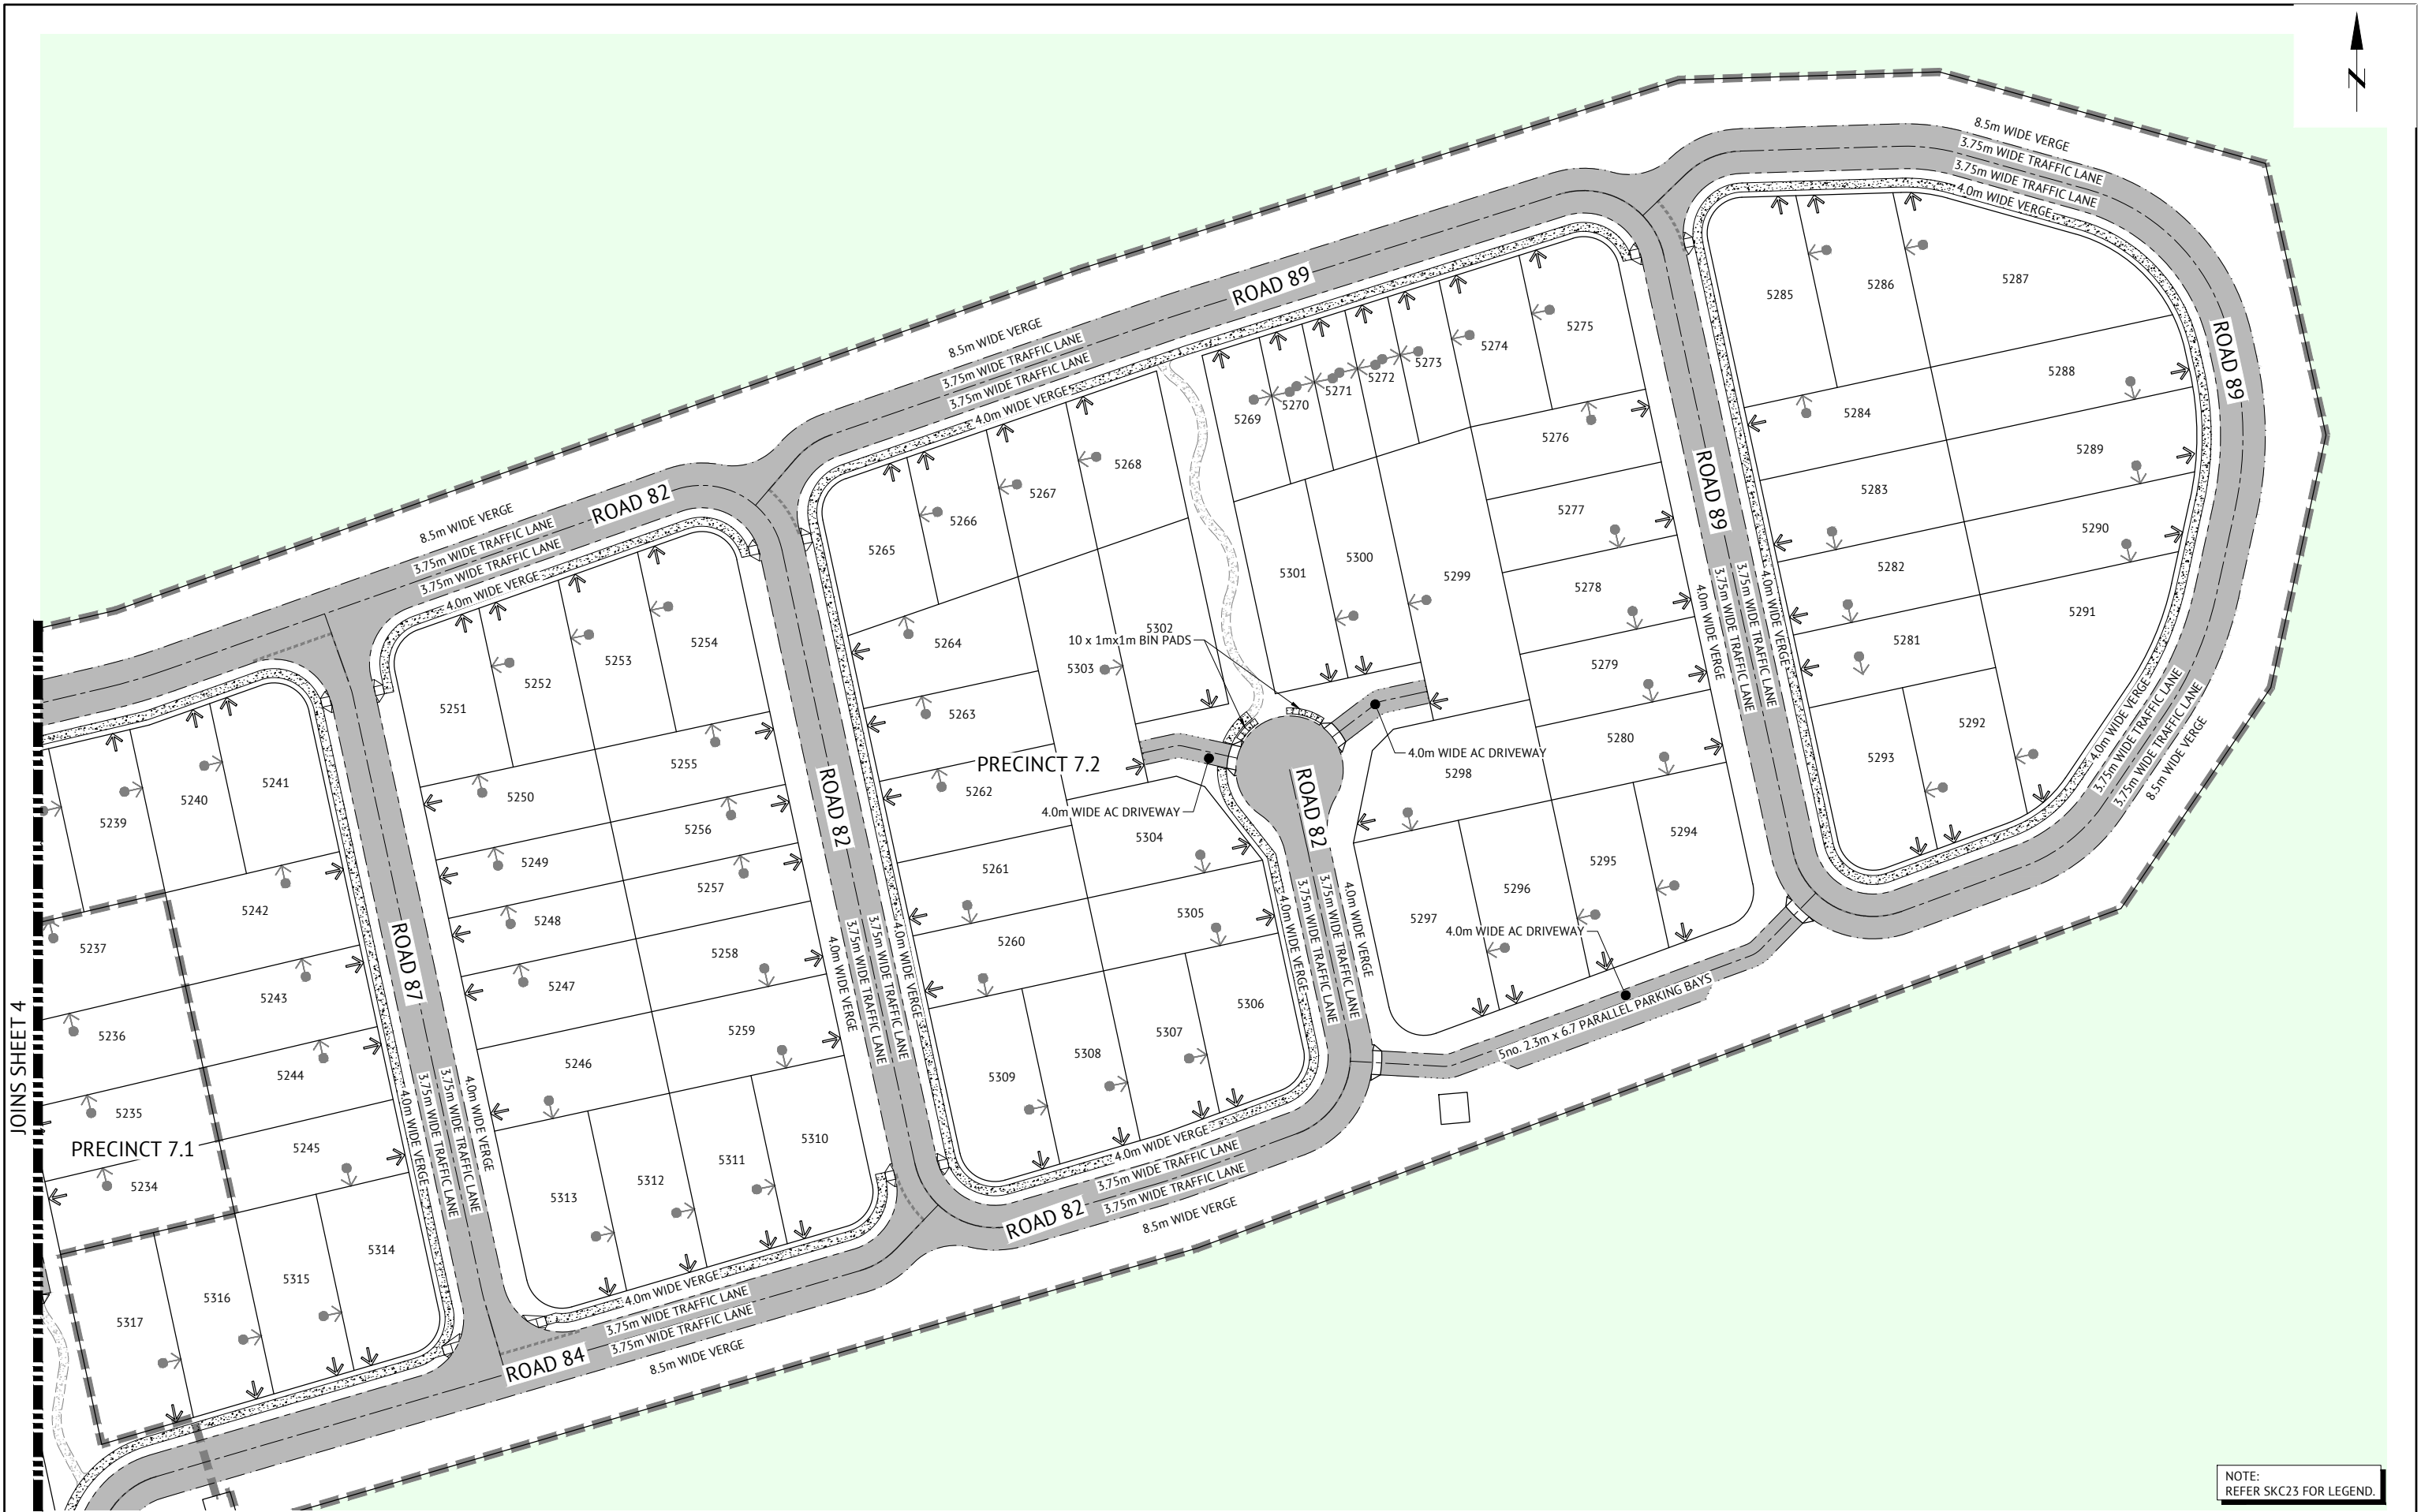


NOTE:
REFER SKC23 FOR LEGEND.

PRELIMINARY - NOT FOR CONSTRUCTION				
DATE	REV	DESCRIPTION	REC	APP
05/11/2024	4	AMENDED ROAD AS PER CHANGES TO LOT LAYOUT	KK	NS
22/05/2024	3	ADDED LANDSCAPE FOOTPATH AND PMT LOCATIONS	KK	NS
21/05/2024	2	UPDATED LOT LAYOUT	KK	NS
28/09/2023	1	PRELIMINARY - NOT FOR CONSTRUCTION	KK	NS
REVISIONS				




BRISBANE OFFICE
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BRISBANE, QLD 4000
PH: (07) 3253 2222
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DESIGNED
KLYNT KIWANG
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ANDREW LANGDON
PROJECT MANAGER
NICK SOMERVILLE
ENGINEERING CERTIFICATION
PATRICK BRADY RPEQ 7112

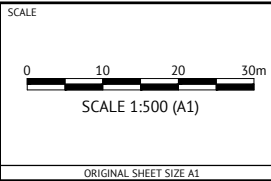

CLIENT		MIRVAC QLD PTY LTD
PROJECT		EVERLEIGH ROL13 SUBDIVISION DEVELOPMENT
LOCATION		TEVIOT ROAD, GREENBANK
SHEET TITLE		ROAD FUNCTIONAL LAYOUT - SHEET 5

JOB CODE		MIR-1300
SHEET NUMBER	REV	SKC27 4

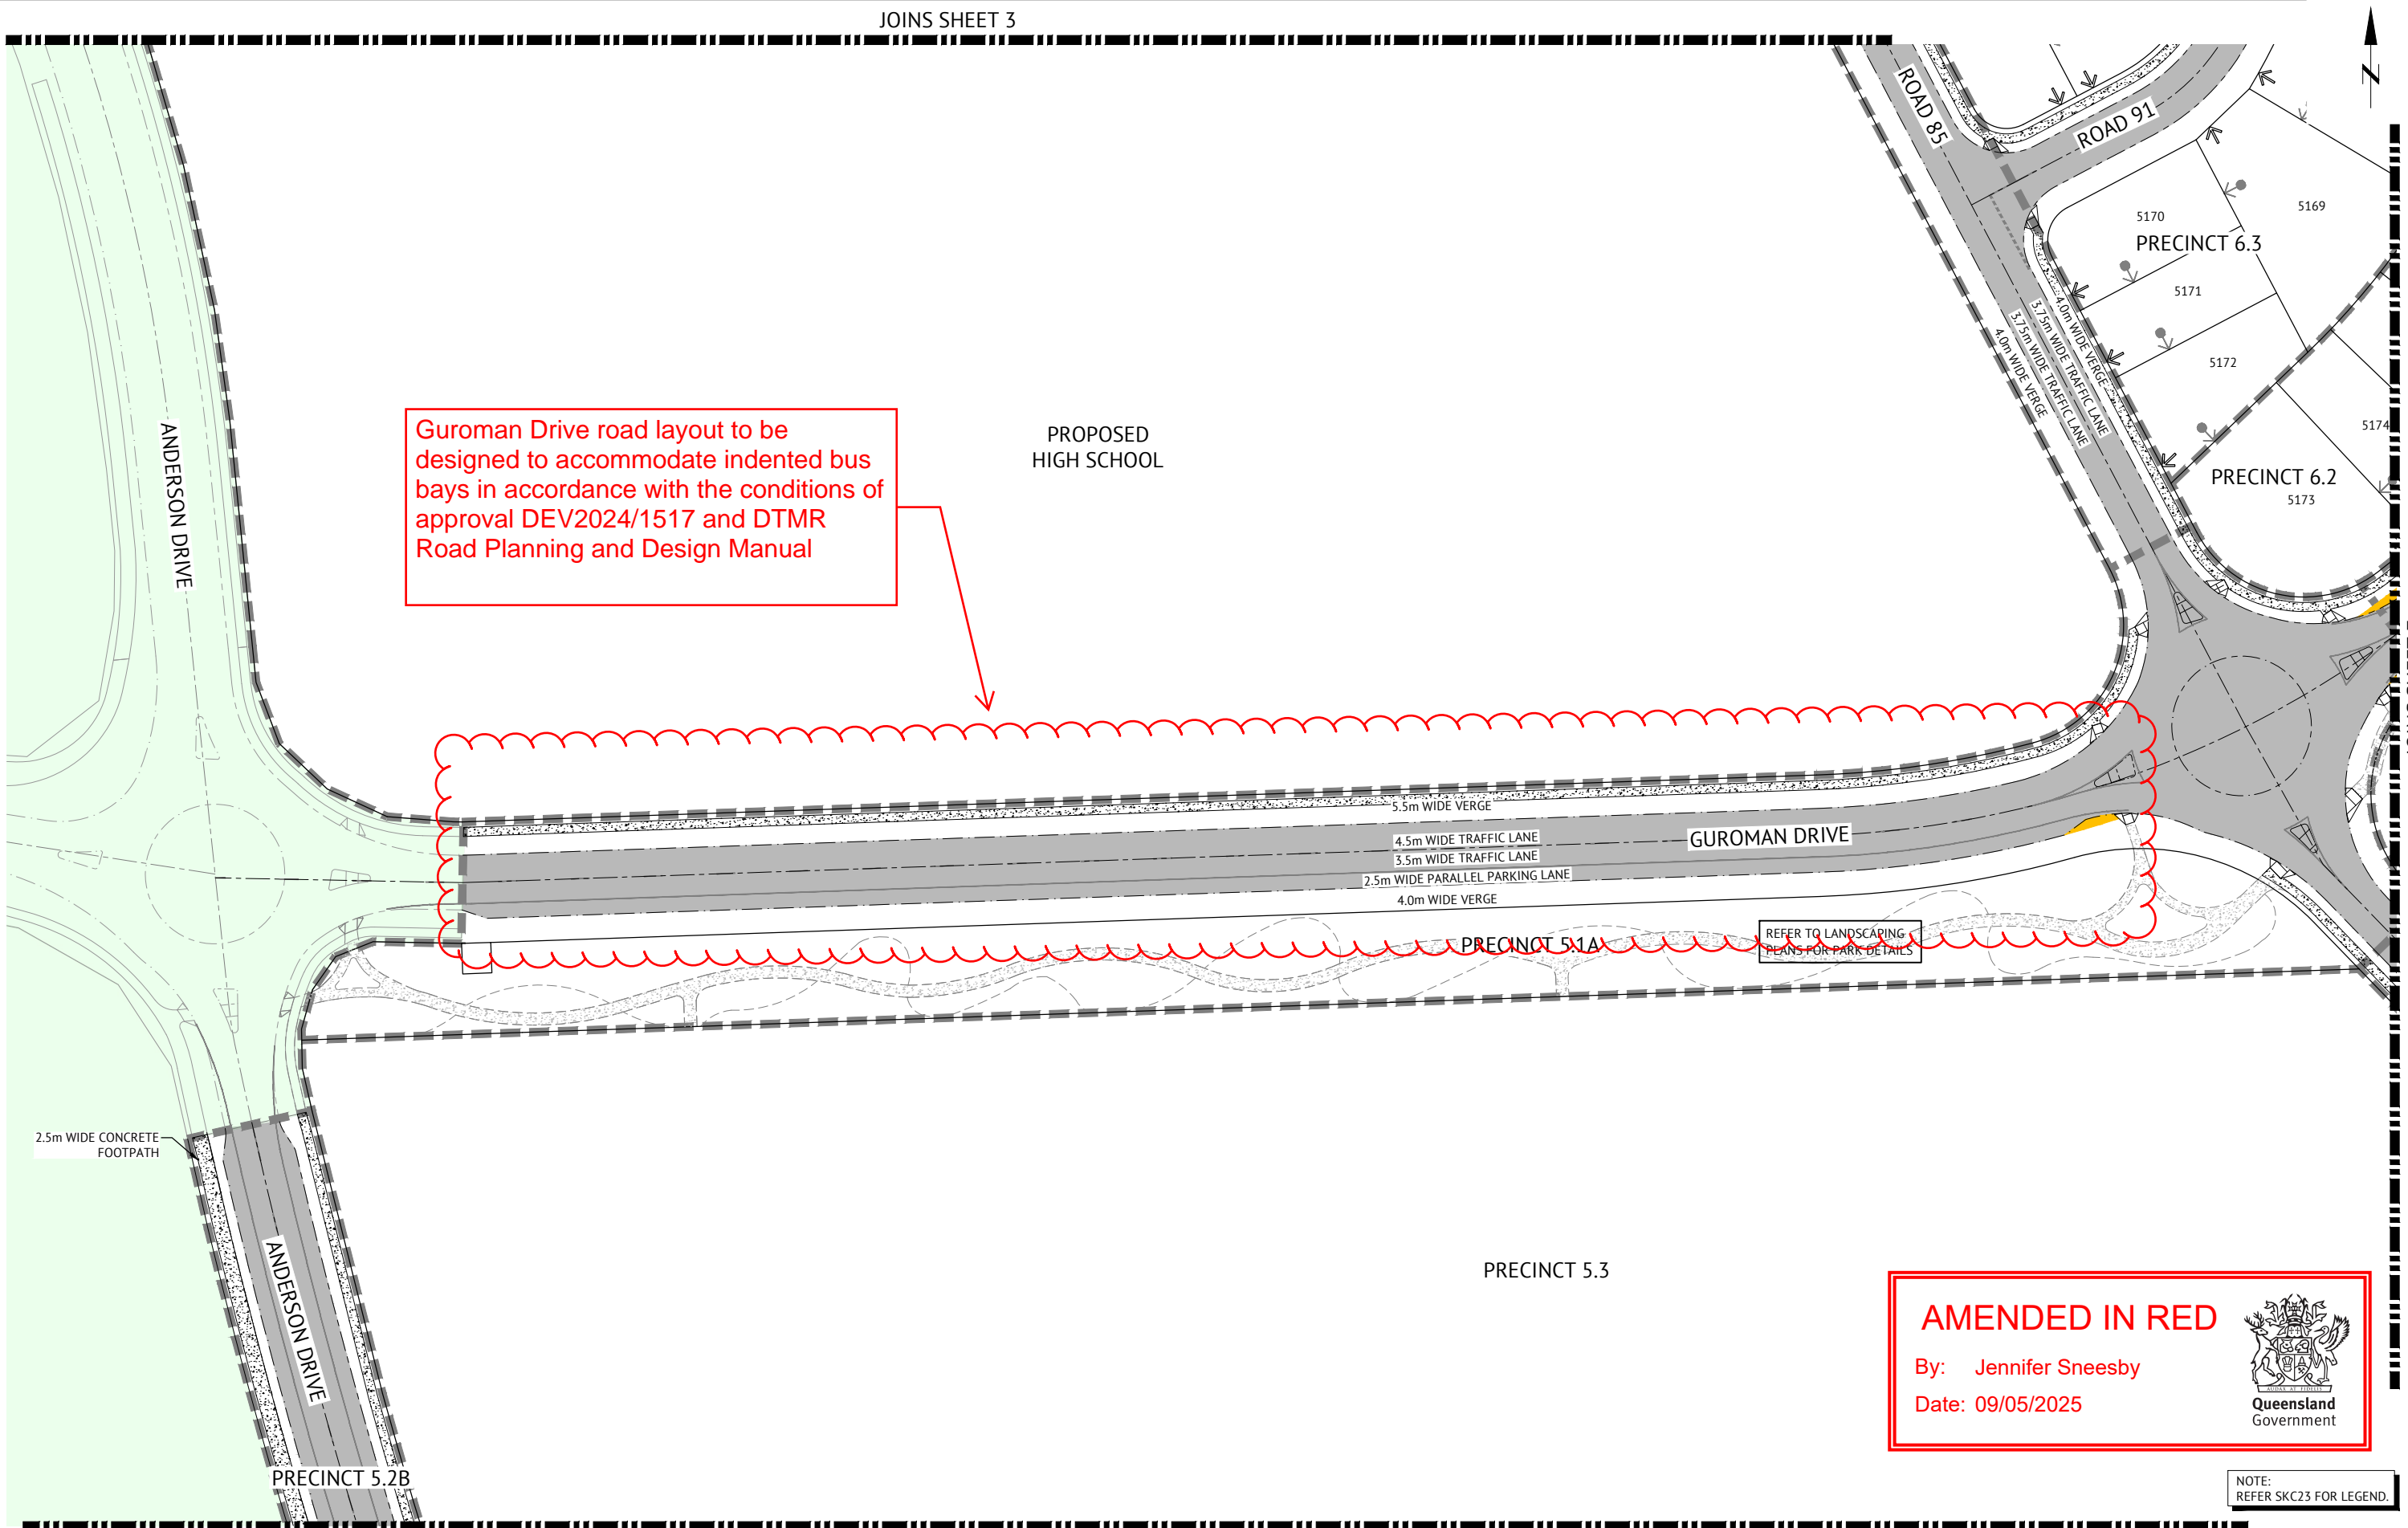


PRELIMINARY - NOT FOR CONSTRUCTION

DATE	REV	DESCRIPTION	REC	APP
22/05/2024	3	ADDED LANDSCAPE FOOTPATH AND PMT LOCATIONS	KK	NS
21/05/2024	2	UPDATED LOT LAYOUT	KK	NS
28/09/2023	1	PRELIMINARY - NOT FOR CONSTRUCTION	KK	NS




BRISBANE OFFICE
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BRISBANE, QLD 4000
PH: (07) 3253 2222
WEB: www.premise.com.au

DESIGNED KLYNT KIWANG	
CHECKED ANDREW LANGDON	
PROJECT MANAGER NICK SOMERVILLE	
ENGINEERING CERTIFICATION	
PATRICK BRADY	RPEQ 7112

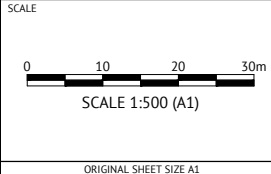


CLIENT	MIRVAC QLD PTY LTD
PROJECT	EVERLEIGH ROL13 SUBDIVISION DEVELOPMENT
LOCATION	TEVIOT ROAD, GREENBANK
SHEET TITLE	ROAD FUNCTIONAL LAYOUT - SHEET 6

JOB CODE	MIR-1300
SHEET NUMBER	SKC28
REV	3

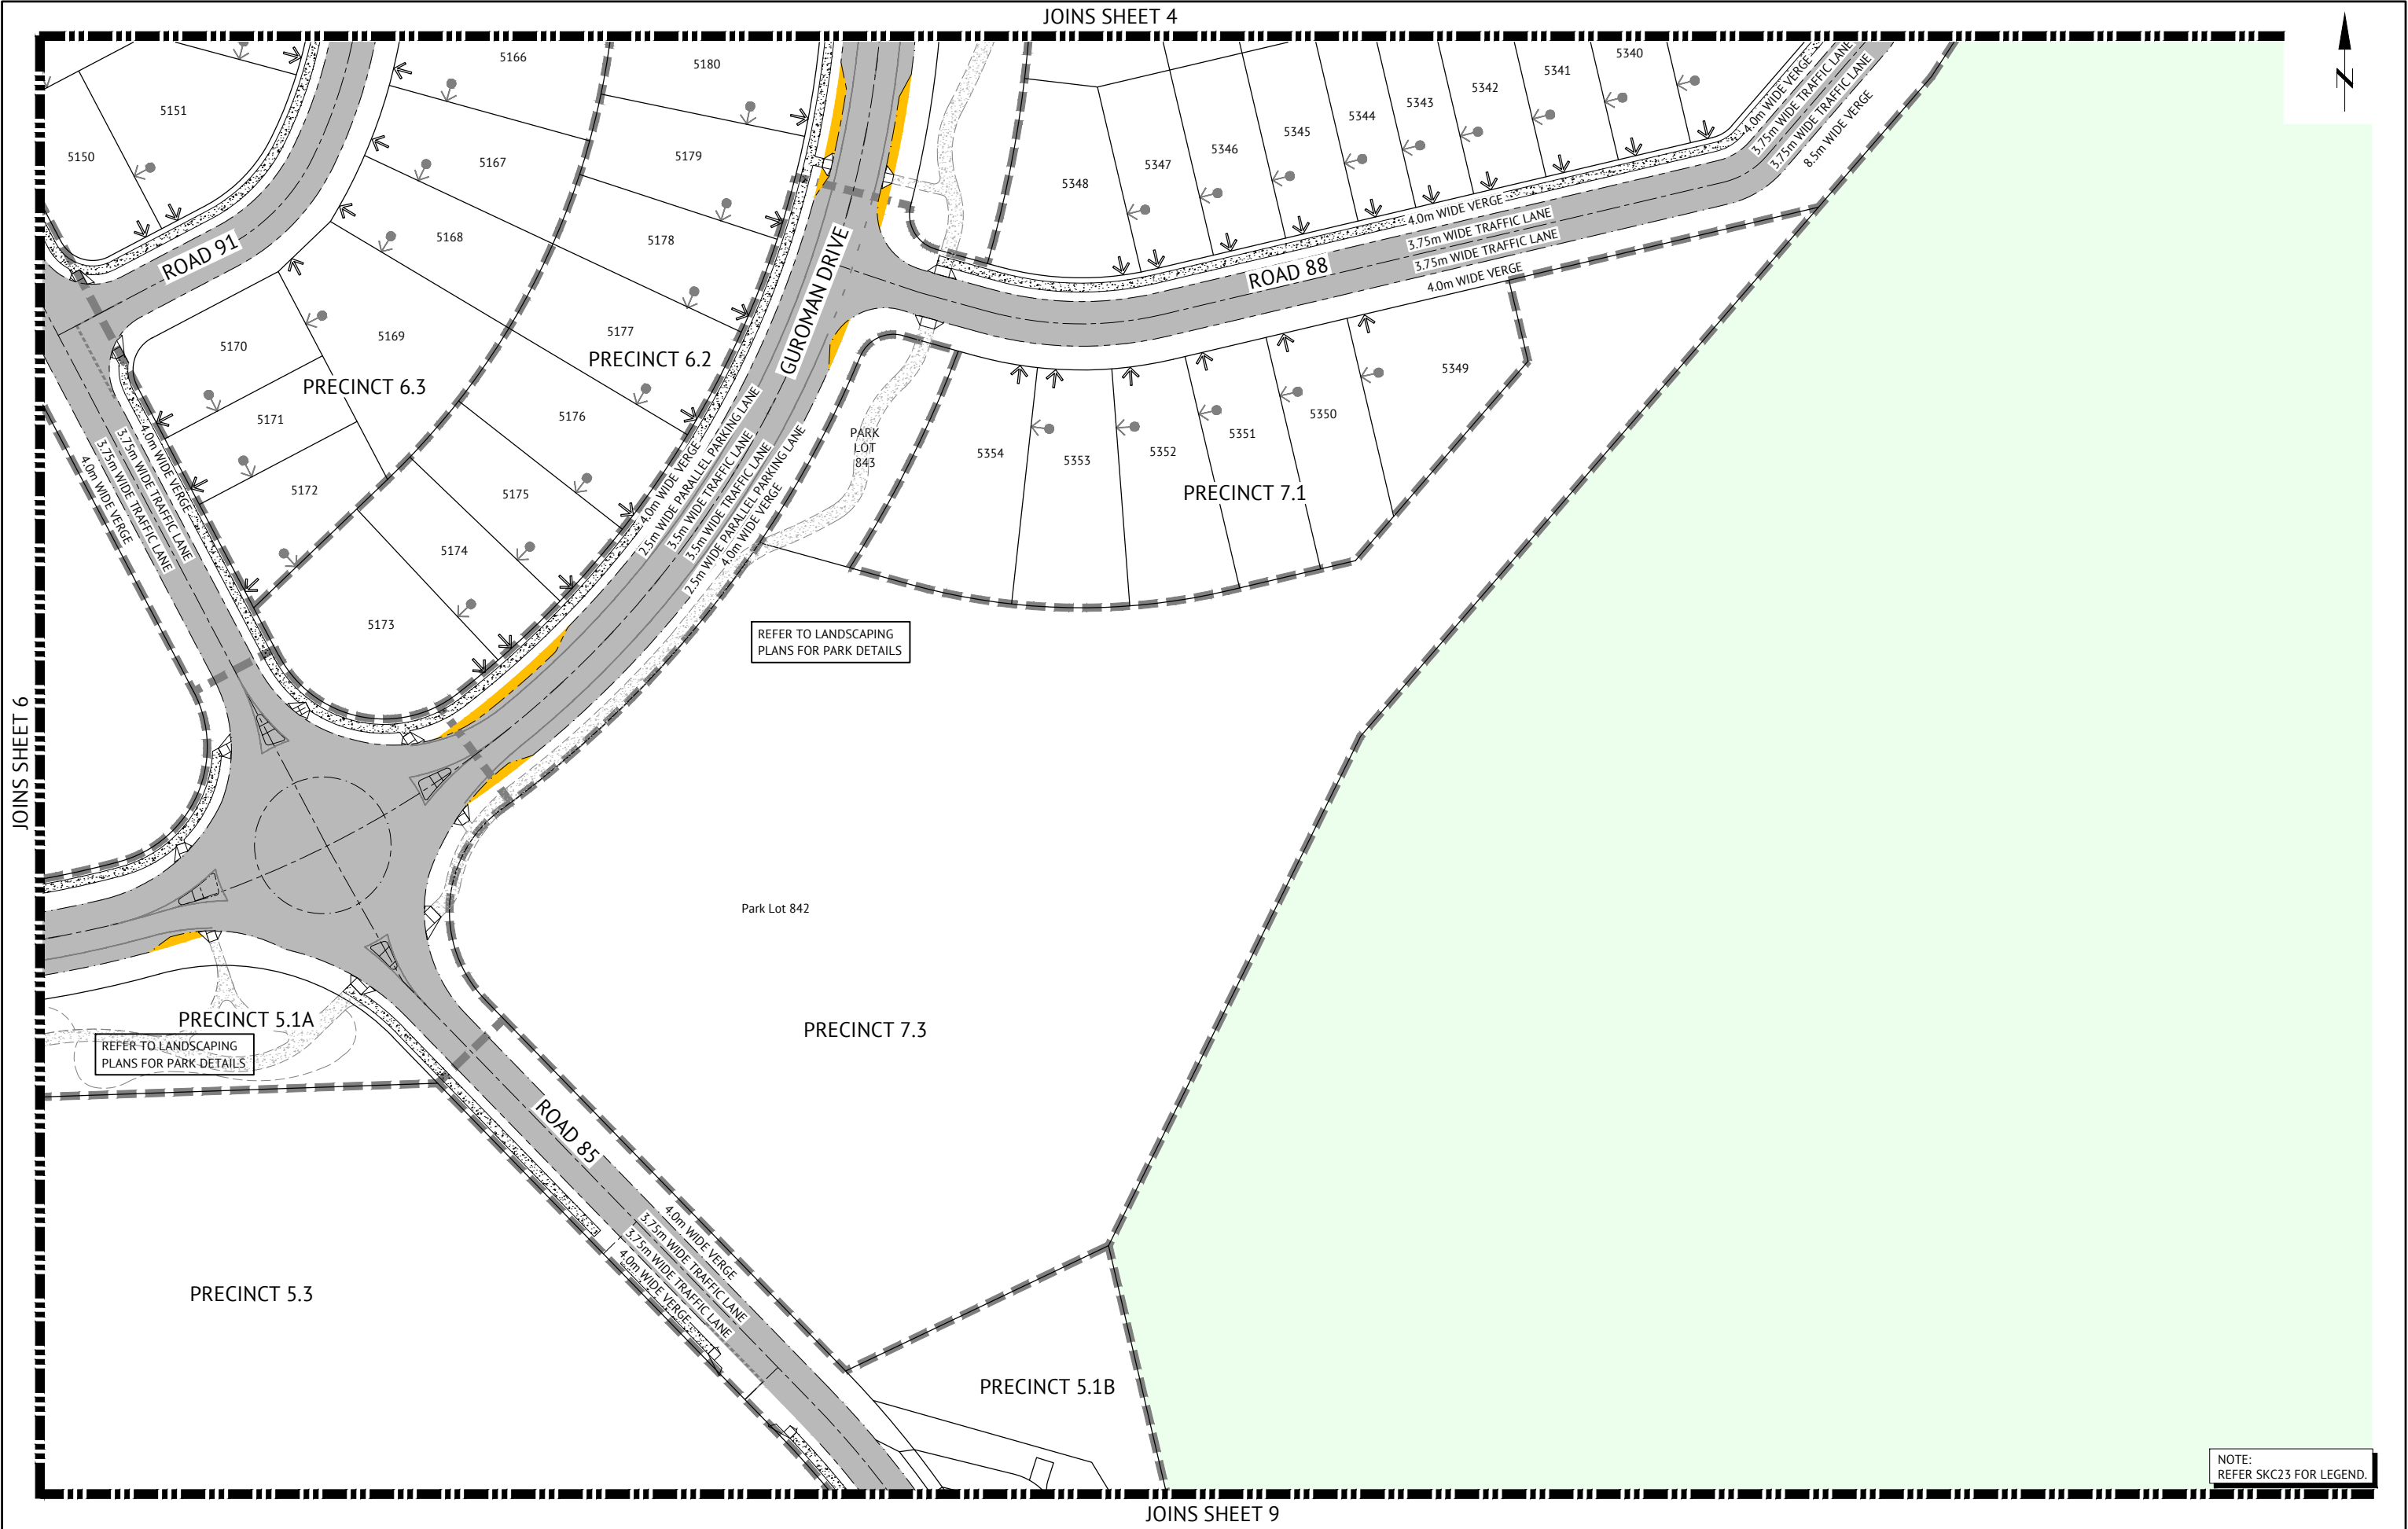

PRELIMINARY - NOT FOR CONSTRUCTION

DATE	REV	DESCRIPTION	REC	APP
22/05/2024	3	ADDED LANDSCAPE FOOTPATH	KK	NS
21/05/2024	2	UPDATED LOT LAYOUT	KK	NS
28/09/2023	1	PRELIMINARY - NOT FOR CONSTRUCTION	KK	NS



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BRISBANE, QLD 4000

PH: (07) 3253 2222

WEB: www.premise.com.au

DESIGNED
KLYNT KIWANG

CHECKED
ANDREW LANGDON


PROJECT MANAGER
NICK SOMERVILLE

ENGINEERING CERTIFICATION

PATRICK BRADY

RPEQ 7112

SCALE



SCALE 1:500 (A1)

ORIGINAL SHEET SIZE A1

CLIENT

MIRVAC QLD PTY LTD

PROJECT

EVERLEIGH ROL13 SUBDIVISION DEVELOPMENT

LOCATION

TEVIOT ROAD, GREENBANK

SHEET TITLE

ROAD FUNCTIONAL LAYOUT - SHEET 7

JOB CODE

MIR-1300

SHEET NUMBER

SKC29

REV

3

2.5m WIDE CONCRETE-
FOOTPATH

ANDERSON DRIVE

Diagram illustrating the cross-section of a 4-lane highway with the following dimensions:

- 4.0m WIDE VERGE
- 3.40m WIDE PARALLEL PARKING LANE
- 2.5m WIDE PARALLEL PARKING LANE
- 3.75m WIDE TRAFFIC LANE
- 3.75m WIDE TRAFFIC LANE
- PARALLEL PARKING LANE
- VERGE

PRECINCT 5.3

NOTE:
REFER SKC23 FOR LEGEND.

PRELIMINARY - NOT FOR CONSTRUCTION

21/03/2024	2	UPDATED LOT LAYOUT	KK	NS
28/09/2023	1	PRELIMINARY - NOT FOR CONSTRUCTION	KK	NS
DATE	REV	DESCRIPTION	REC	APP
REVISIONS				



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DESIGNED
KLYNT KIWANG

CHECKED
ANDREW LANGDON

PROJECT MANAGER
NICK SOMERVILLE

ENGINEERING CERTIFICATION

PATRICK BRADY RPEQ 7112

SCALE



ORIGINAL SHEET SIZE A1

CLIENT

MIRVAC QLD PTY LTD

PROJECT EVERLEIGH ROL13 SUBDIVISION DEVELOPMENT

LOCATION **TEVIOT ROAD, GREENBANK**

SHEET TITLE **ROAD FUNCTIONAL LAYOUT - SHEET 8**

JOB CODE

MIR-1300

HEET NUMBER
SKC30

JOINS SHEET 9



PRECINCT 5.3

PRECINCT 5.1B

PRECINCT 5.2A

ROAD 85

REFER TO LANDSCAPING
PLANS FOR PARK DETAILS

PROPOSED SEWAGE
PUMP STATION

TRAFFIC LANE
VERGE

4.0m WIDE VERGE
3.75m WIDE TRAFFIC LANE
3.75m WIDE TRAFFIC LANE
4.0m WIDE VERGE

NOTE:
REFER SKC23 FOR LEGEND.

PRELIMINARY - NOT FOR CONSTRUCTION

DATE	REV	DESCRIPTION	REC	APP
21/05/2024	2	UPDATED LOT LAYOUT	KK	NS
28/09/2023	1	PRELIMINARY - NOT FOR CONSTRUCTION	KK	NS




BRISBANE OFFICE
LEVEL 11, 300 ADELAIDE STREET
BRISBANE, QLD 4000
PH: (07) 3253 2222
WEB: www.premise.com.au

DESIGNED
KLYNT KIWANG
CHECKED
ANDREW LANGDON
PROJECT MANAGER
NICK SOMERVILLE
ENGINEERING CERTIFICATION
PATRICK BRADY RPEQ 7112

SCALE
0 10 20 30m
SCALE 1:500 (A1)
ORIGINAL SHEET SIZE A1

CLIENT
MIRVAC QLD PTY LTD
PROJECT
EVERLEIGH ROL13 SUBDIVISION DEVELOPMENT
LOCATION
TEVIOT ROAD, GREENBANK
SHEET TITLE
ROAD FUNCTIONAL LAYOUT - SHEET 9

JOB CODE
MIR-1300
SHEET NUMBER
SKC31
REV
2

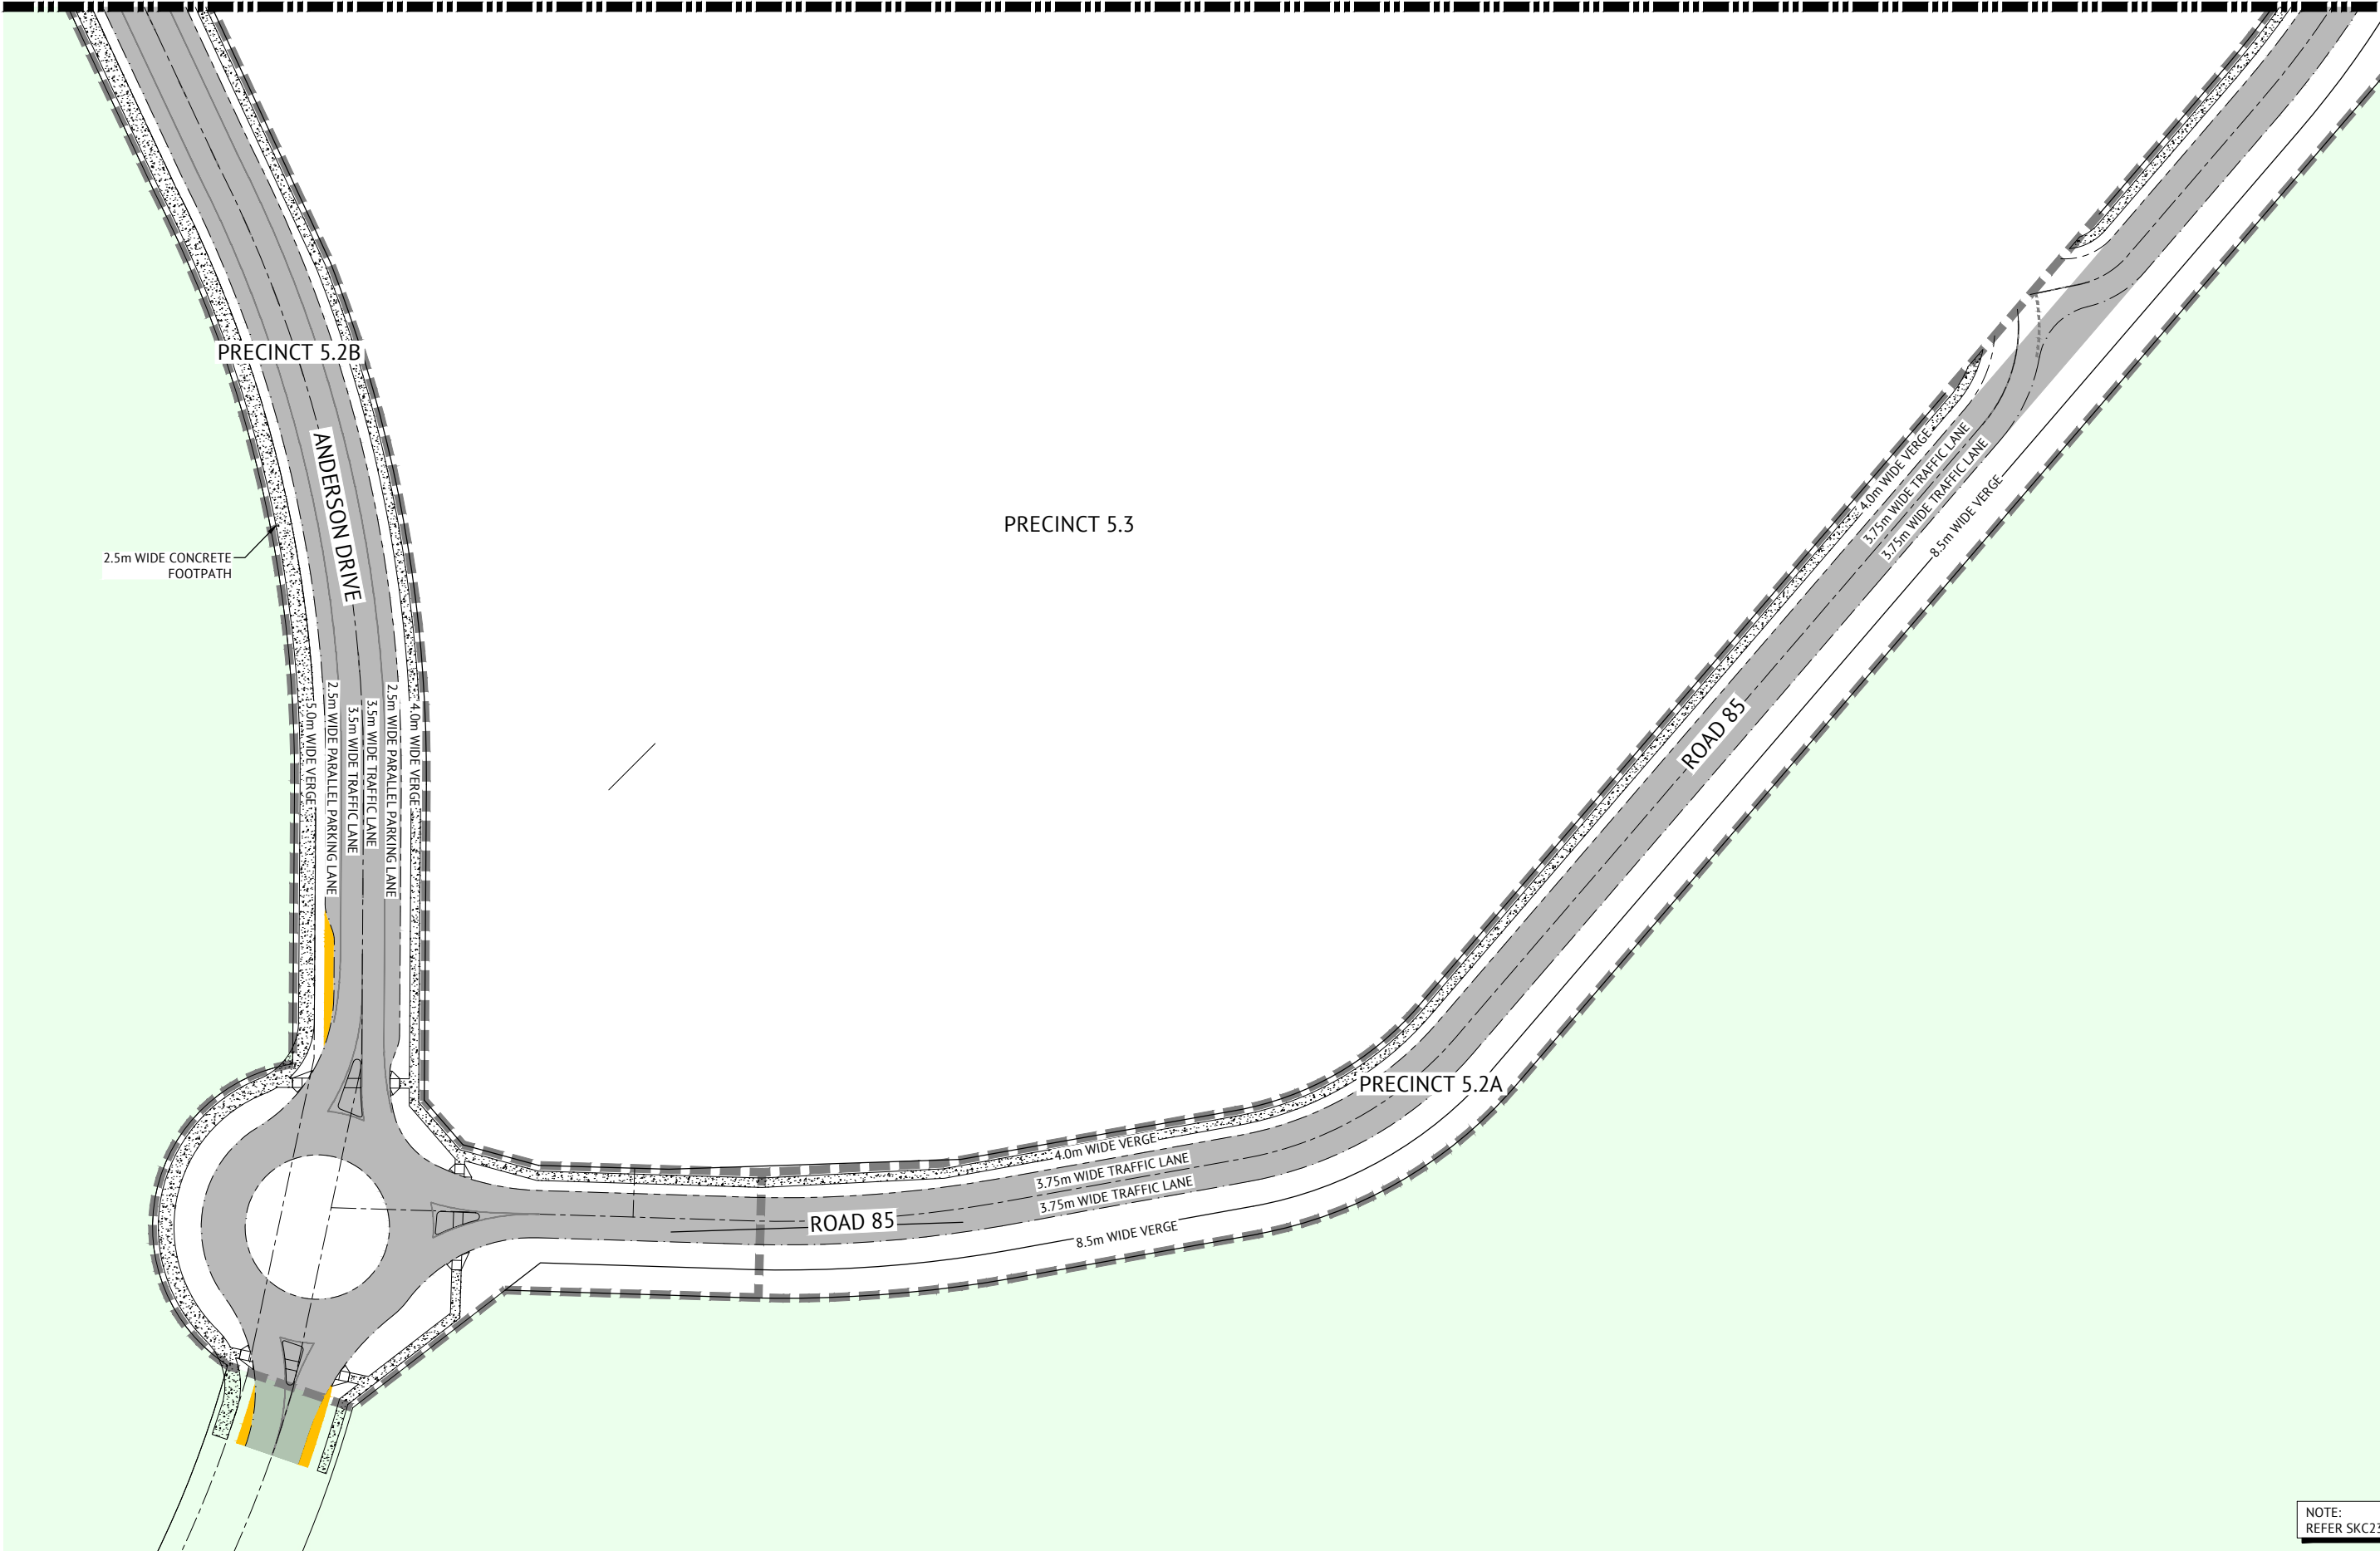

NOTE:
REFER SKC23 FOR LEGEND.


PRELIMINARY - NOT FOR CONSTRUCTION

DATE	REV	DESCRIPTION	REC	APP
21/05/2024	2	UPDATED LOT LAYOUT	KK	NS
28/09/2023	1	PRELIMINARY - NOT FOR CONSTRUCTION	KK	NS



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NICK SOMERVILLE
ENGINEERING CERTIFICATION
PATRICK BRADY RPEQ 7112






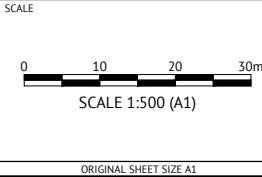


CLIENT	MIRVAC QLD PTY LTD
PROJECT	EVERLEIGH ROL13 SUBDIVISION DEVELOPMENT
LOCATION	TEVIOT ROAD, GREENBANK
SHEET TITLE	ROAD FUNCTIONAL LAYOUT - SHEET 10

JOB CODE	MIR-1300
SHEET NUMBER	SKC32
REV	2

AMENDED IN RED

By: Jennifer Sneesby
Date: 09/05/2025

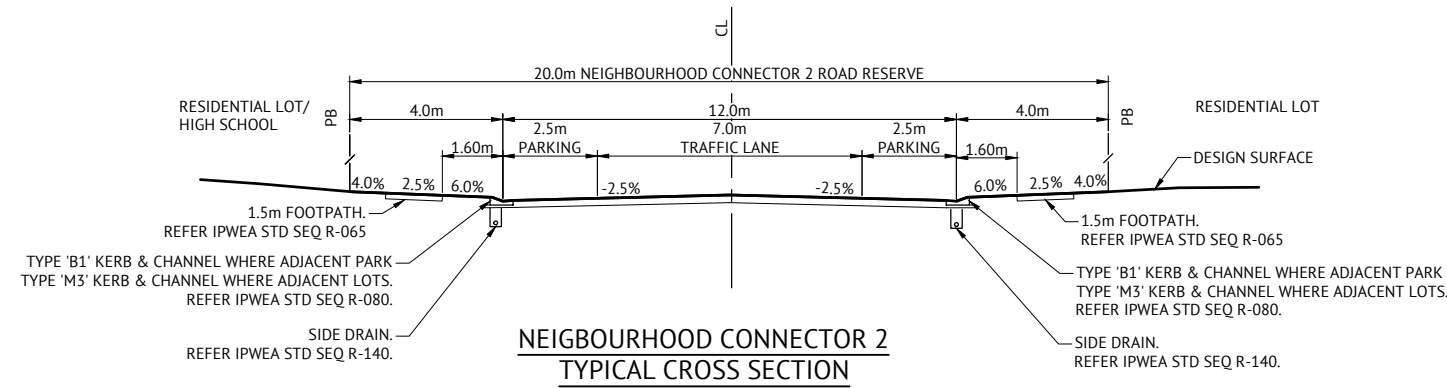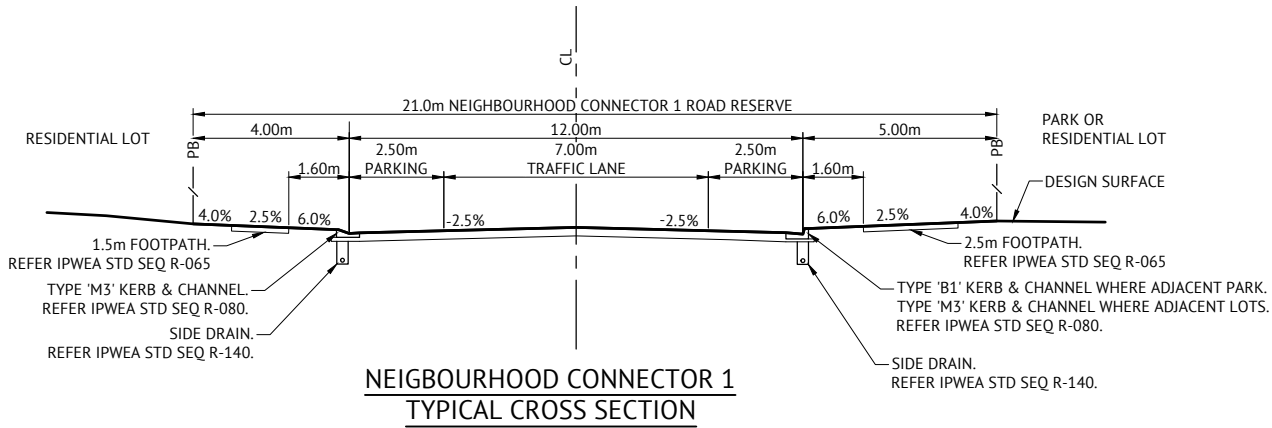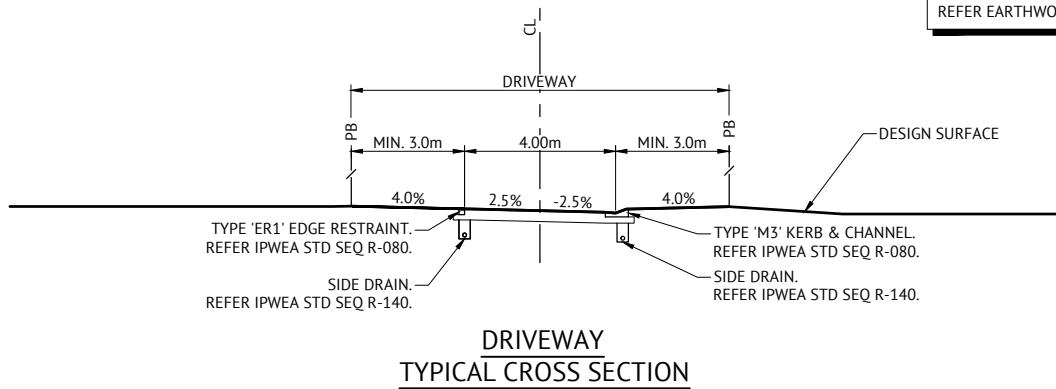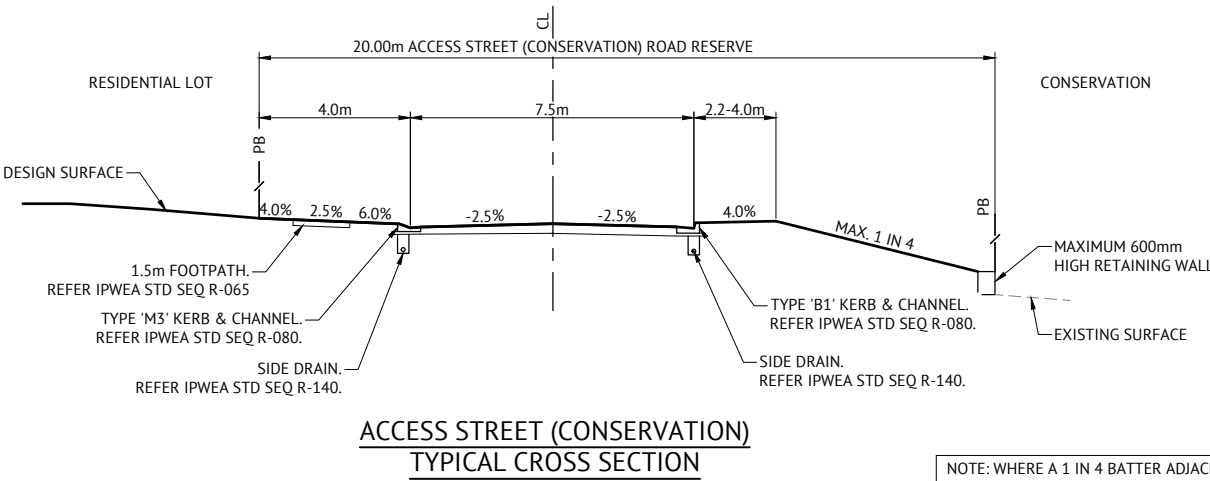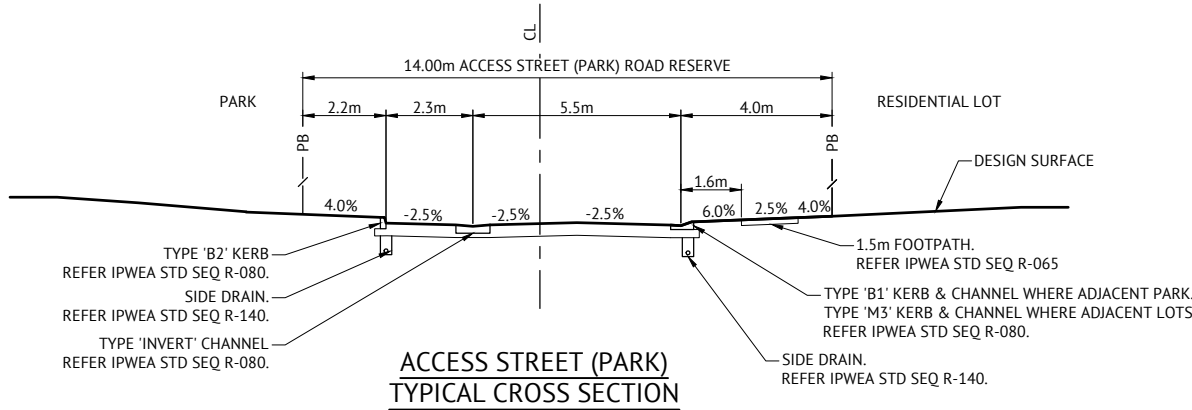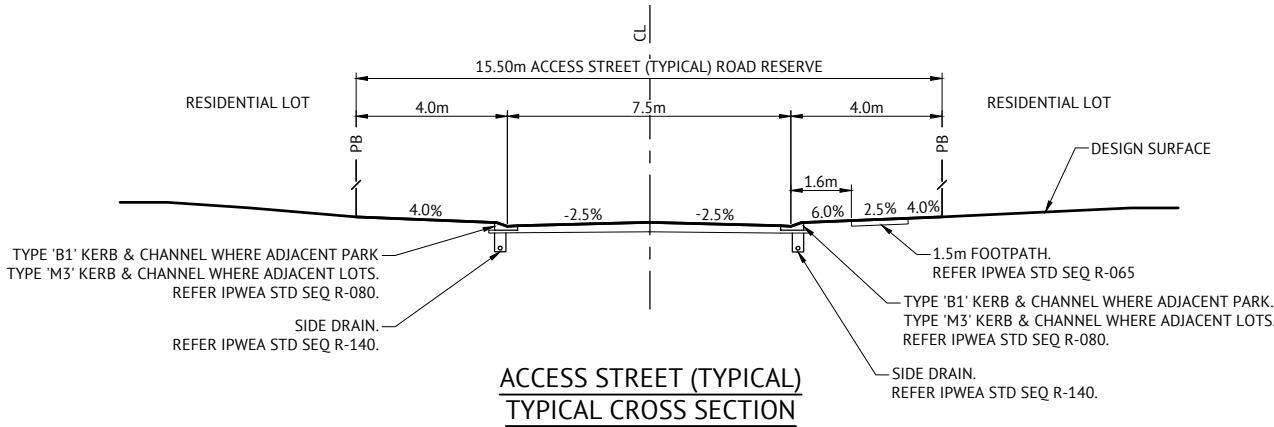

Guroman Drive cross section to be designed to accommodate indented bus bays in accordance with the conditions of approval DEV2024/1517 and DTMR Road Planning and Design Manual

PRELIMINARY - NOT FOR CONSTRUCTION


DATE	REV	DESCRIPTION	REC	APP
04/12/2023	2	AMENDED CROSS SECTIONS TO MATCH MWH MINIP	KK	NS
28/09/2023	1	PRELIMINARY - NOT FOR CONSTRUCTION	KK	NS



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ANDREW LANGDON
PROJECT MANAGER
NICK SOMERVILLE
ENGINEERING CERTIFICATION

PATRICK BRADY RPEQ 7112

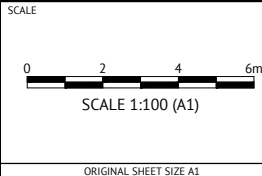

CLIENT
MIRVAC QLD PTY LTD
PROJECT
EVERLEIGH ROL13 SUBDIVISION DEVELOPMENT
LOCATION
TEVIOT ROAD, GREENBANK
SHEET TITLE
TYPICAL ROAD CROSS SECTIONS

JOB CODE
MIR-1300
SHEET NUMBER
SKC33
REV
2

APPENDIX E


TRAFFIC IMPACT ASSESSMENT – supplied in separate document



APPENDIX F

PRELIMINARY STORMWATER DRAINAGE PLANS



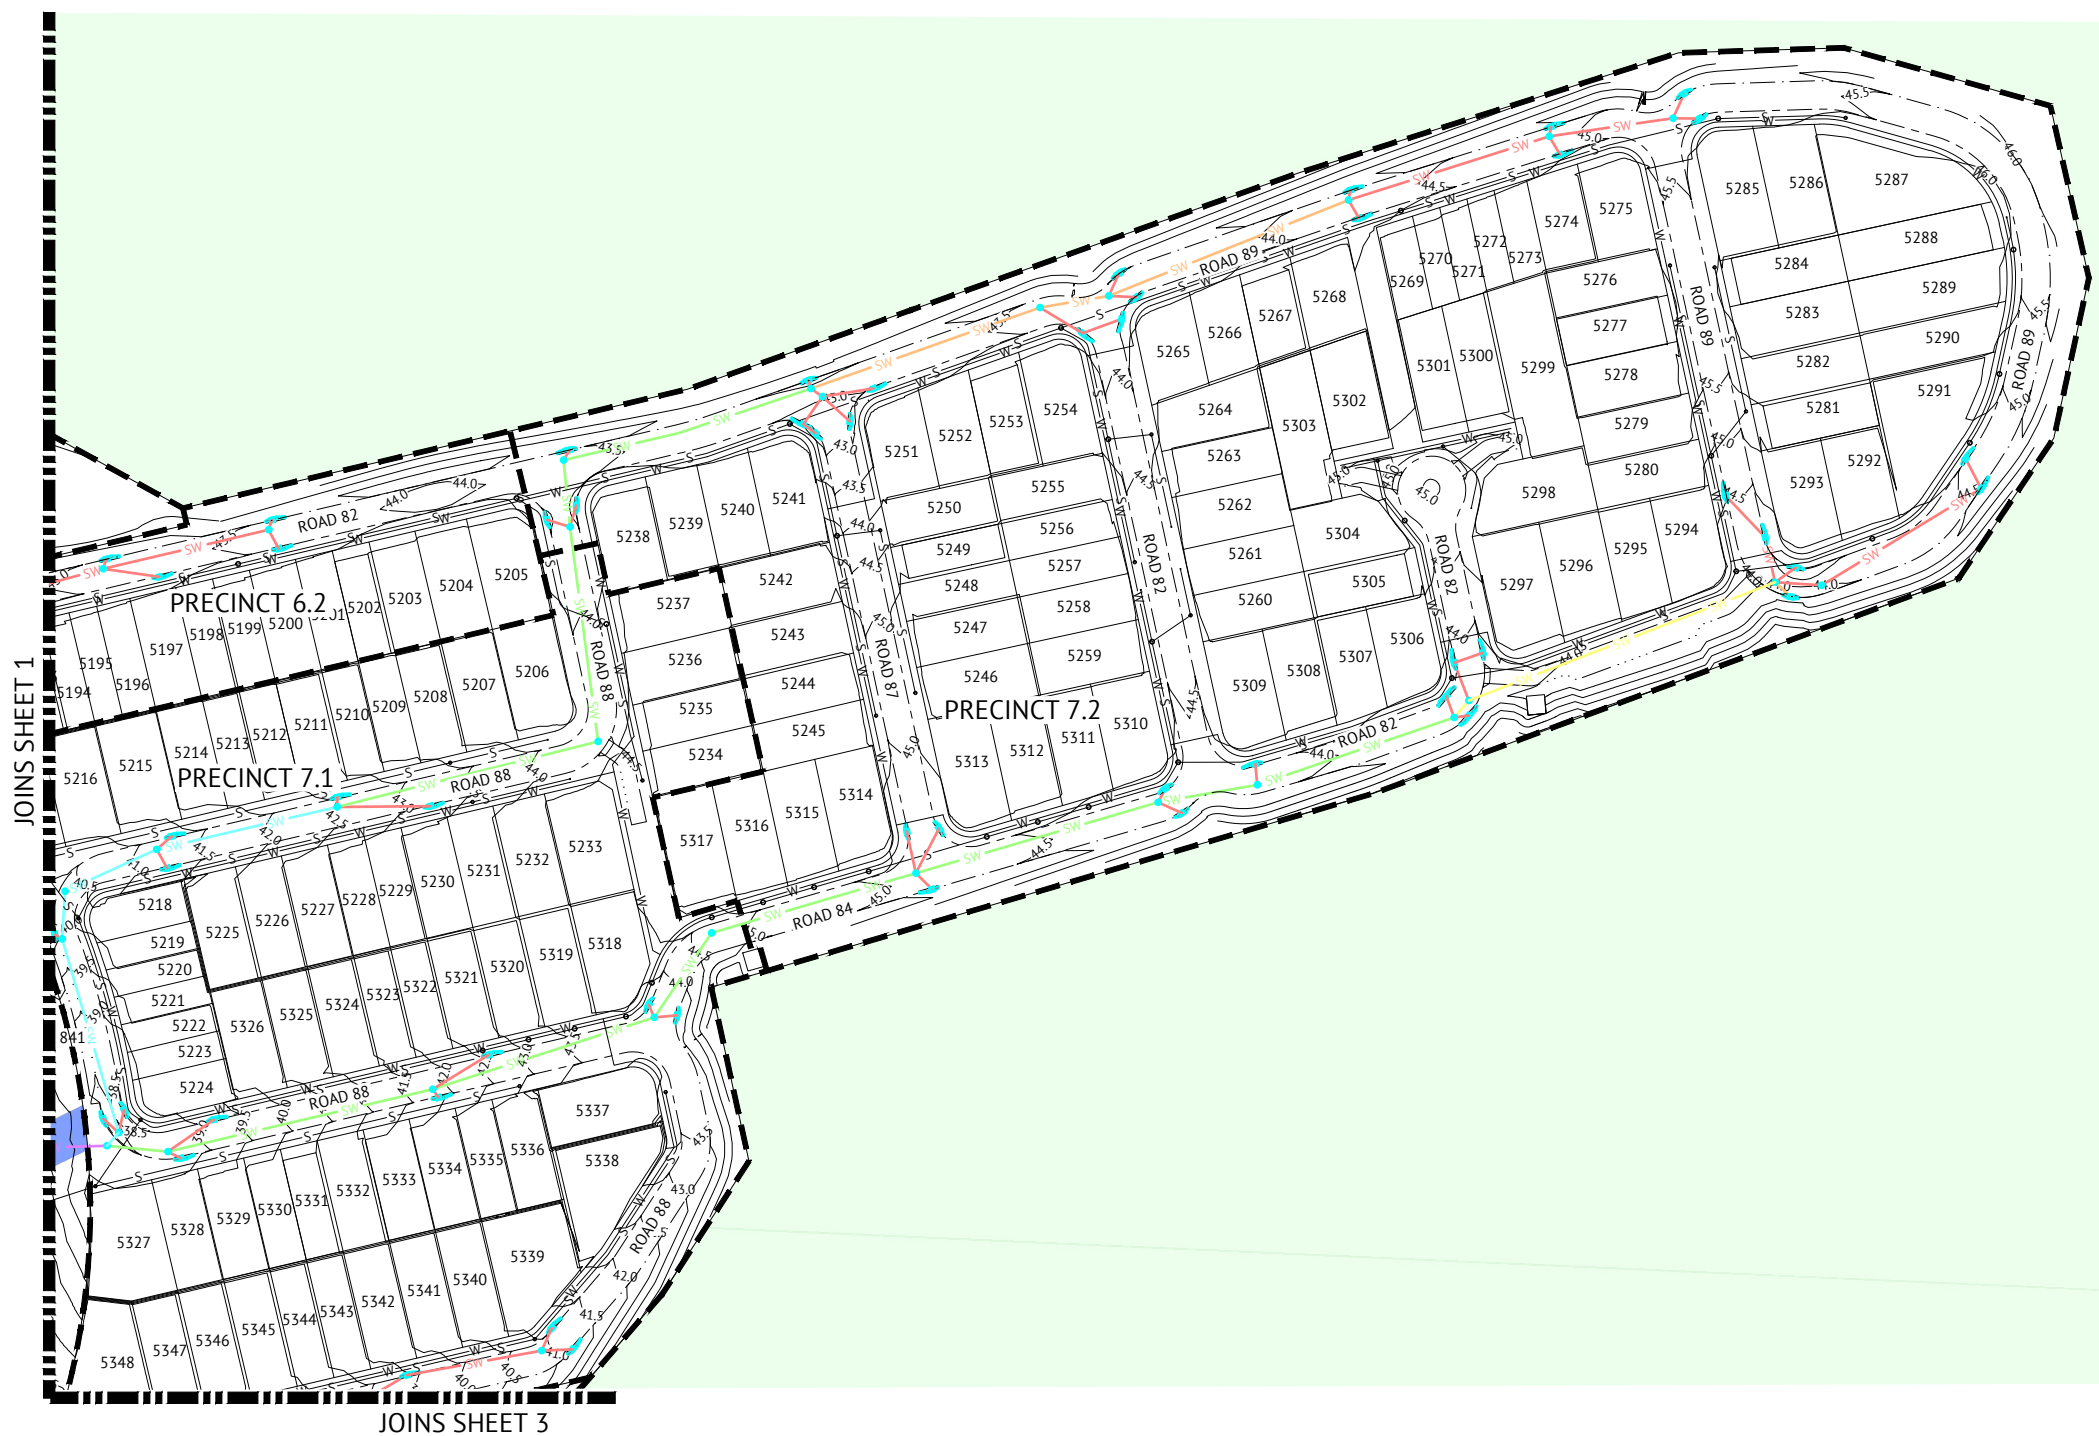

LEGEND - PROPOSED

- DN375 STORMWATER
- DN450 STORMWATER
- DN525 STORMWATER
- DN600 STORMWATER
- DN675 STORMWATER
- DN750 STORMWATER
- DN825 STORMWATER
- DN900 STORMWATER
- DN1050 STORMWATER
- DN1200 STORMWATER
- 900x450 BOX CULVERT
- OVERLAND FLOW PATH
- FINISHED CONTOURS (0.50m)
- PROPOSED IPWEA STD TYPE 'B1' KERB & CHANNEL. REFER IPWEA STD DWG RS-080.
- PROPOSED IPWEA STD TYPE 'B2' KERB ONLY. REFER IPWEA STD DWG RS-080.
- PROPOSED IPWEA TYPE 'M3' KERB & CHANNEL. REFER IPWEA STD DWG RS-080.
- PROPOSED IPWEA STD TYPE 'ER1' EDGE RESTRAINT. REFER IPWEA STD DWG RS-080.
- PROPOSED IPWEA INVERT. REFER IPWEA STD DWG RS-080.
- IPWEA STD TYPE 'SM5' KERB ONLY. REFER IPWEA STD DWG RS-080.
- GRAVITY SEWER
- SEWER RISING MAIN
- WATER
- PRECINCT BOUNDARY

LEGEND - EXISTING

- STORMWATER
- GRAVITY SEWER
- SEWER RISING MAIN
- WATER
- ELECTRICAL
- TELSTRA
- GAS

PRELIMINARY - NOT FOR CONSTRUCTION

DATE	REV	DESCRIPTION	REC	APP
05/11/2024	4	UPDATED STORMWATER AS PER CHANGES TO LOT LAYOUT	KK	NS
22/05/2024	3	ADDED BOX CULVERT TO LEGEND	KK	NS
14/05/2024	2	UPDATED TO PRECINCT NUMBERS AND LAYOUT	KK	NS
10/02/2022	1	PRELIMINARY - NOT FOR CONSTRUCTION	KK	NS




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BRISBANE, QLD 4000
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WEB: www.premise.com.au

DESIGNED
KLYNT KIWANG
CHECKED
ANDREW LANGDON
PROJECT MANAGER
NICK SOMERVILLE
ENGINEERING CERTIFICATION
PATRICK BRADY RPEQ 7112

SCALE
0 20 40 60m
SCALE 1:1000 (A1)
ORIGINAL SHEET SIZE A1

CLIENT
MIRVAC QLD PTY LTD
PROJECT
EVERLEIGH ROL13 SUBDIVISION DEVELOPMENT
LOCATION
TEVIOT ROAD, GREENBANK
SHEET TITLE
PRELIMINARY STORMWATER LAYOUT PLAN - SHEET 2

JOB CODE
MIR-1300
SHEET NUMBER
SKC48
REV
4

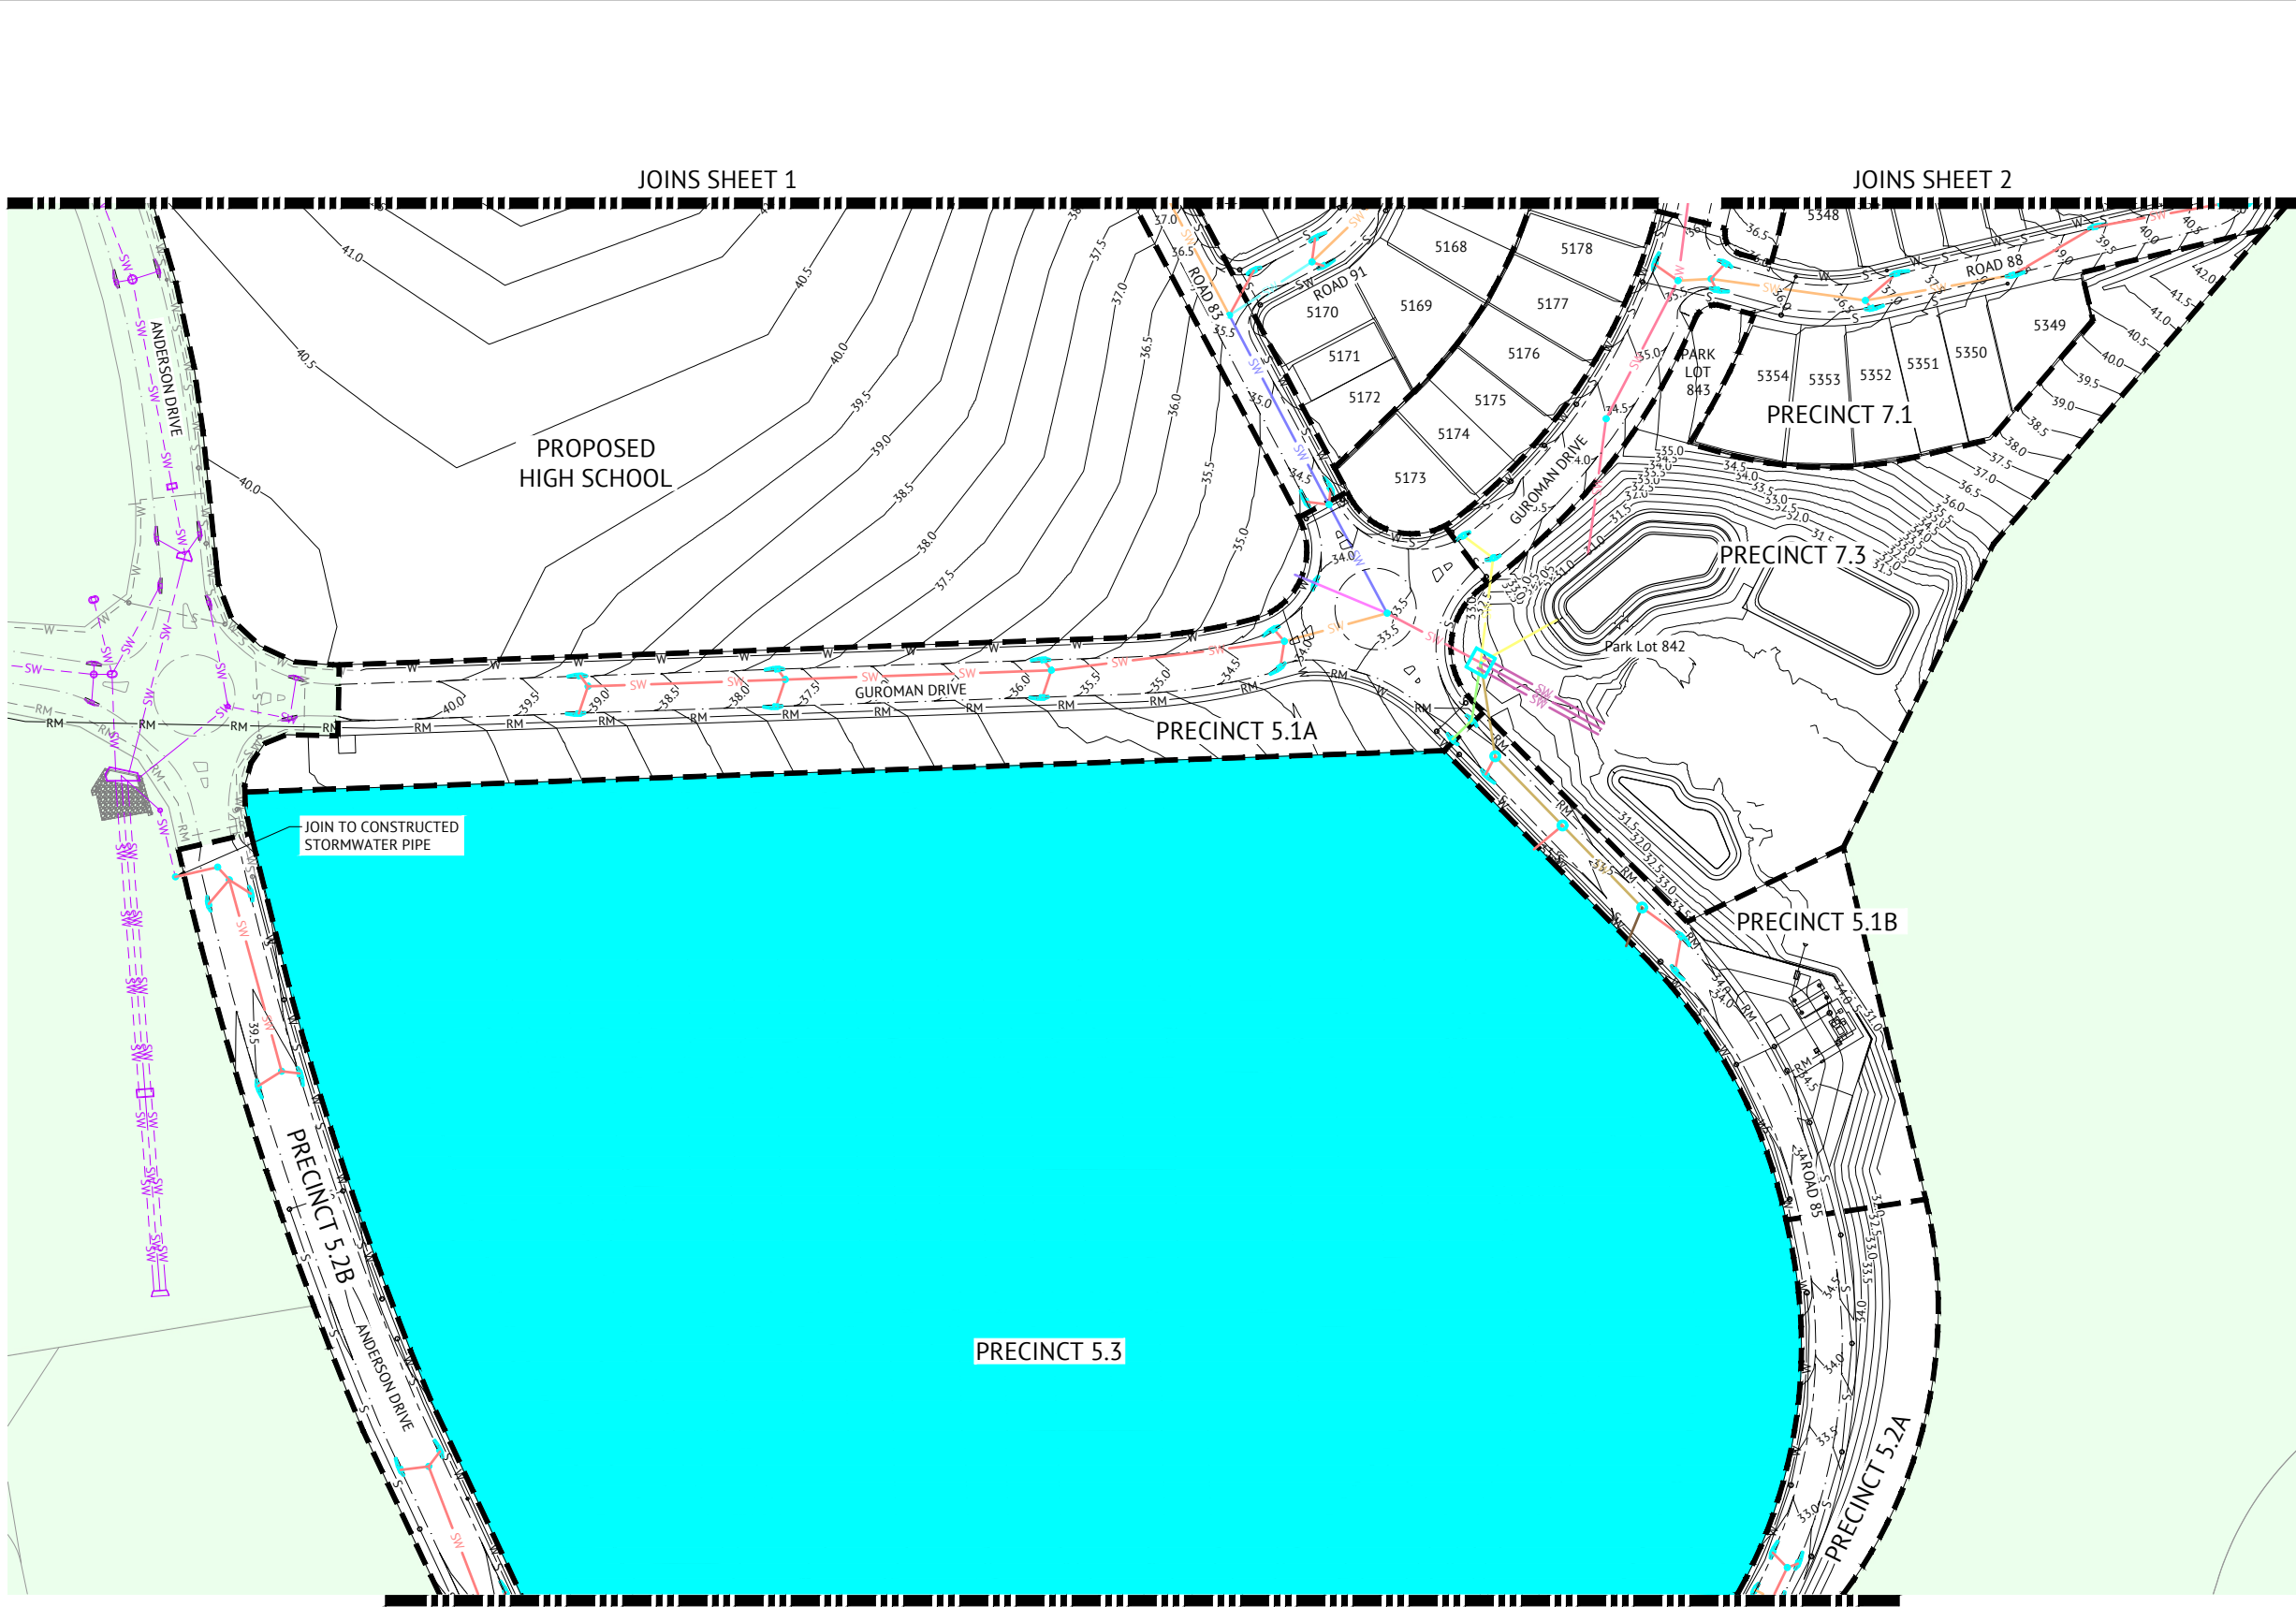

LEGEND - PROPOSED

- DN375 STORMWATER
- DN450 STORMWATER
- DN525 STORMWATER
- DN600 STORMWATER
- DN675 STORMWATER
- DN750 STORMWATER
- DN825 STORMWATER
- DN900 STORMWATER
- DN1050 STORMWATER
- DN1200 STORMWATER
- 900x450 BOX CULVERT
- OVERLAND FLOW PATH
- FINISHED CONTOURS (0.50m)
- PROPOSED IPWEA STD TYPE 'B1' KERB & CHANNEL. REFER IPWEA STD DWG RS-080.
- PROPOSED IPWEA STD TYPE 'B2' KERB ONLY. REFER IPWEA STD DWG RS-080.
- PROPOSED IPWEA TYPE 'M3' KERB & CHANNEL. REFER IPWEA STD DWG RS-080.
- PROPOSED IPWEA STD TYPE 'ER1' EDGE RESTRAINT. REFER IPWEA STD DWG RS-080.
- PROPOSED IPWEA INVERT. REFER IPWEA STD DWG RS-080.
- IPWEA STD TYPE 'SMS' KERB ONLY. REFER IPWEA STD DWG RS-080.
- GRAVITY SEWER
- SEWER RISING MAIN
- WATER
- PRECINCT BOUNDARY

LEGEND - EXISTING

- STORMWATER
- GRAVITY SEWER
- SEWER RISING MAIN
- WATER
- ELECTRICAL
- TELSTRA
- GAS

PRELIMINARY - NOT FOR CONSTRUCTION

DATE	REV	DESCRIPTION	REC	APP
05/11/2024	4	UPDATED STORMWATER AS PER CHANGES TO LOT LAYOUT	KK	NS
22/05/2024	3	ADDED BOX CULVERT TO LEGEND, AMENDED STORMWATER LAYOUT	KK	NS
14/05/2024	2	UPDATED TO PRECINCT NUMBERS AND LAYOUT	KK	NS
10/02/2022	1	PRELIMINARY - NOT FOR CONSTRUCTION	KK	NS




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CHECKED
ANDREW LANGDON
PROJECT MANAGER
NICK SOMERVILLE
ENGINEERING CERTIFICATION
PATRICK BRADY RPEQ 7112

SCALE
0 20 40 60m
SCALE 1:1000 (A1)
ORIGINAL SHEET SIZE A1

CLIENT
MIRVAC QLD PTY LTD
PROJECT
EVERLEIGH ROL13 SUBDIVISION DEVELOPMENT
LOCATION
TEVIOT ROAD, GREENBANK
SHEET TITLE
PRELIMINARY STORMWATER LAYOUT PLAN - SHEET 3

JOB CODE
MIR-1300
SHEET NUMBER
SKC49
REV
4

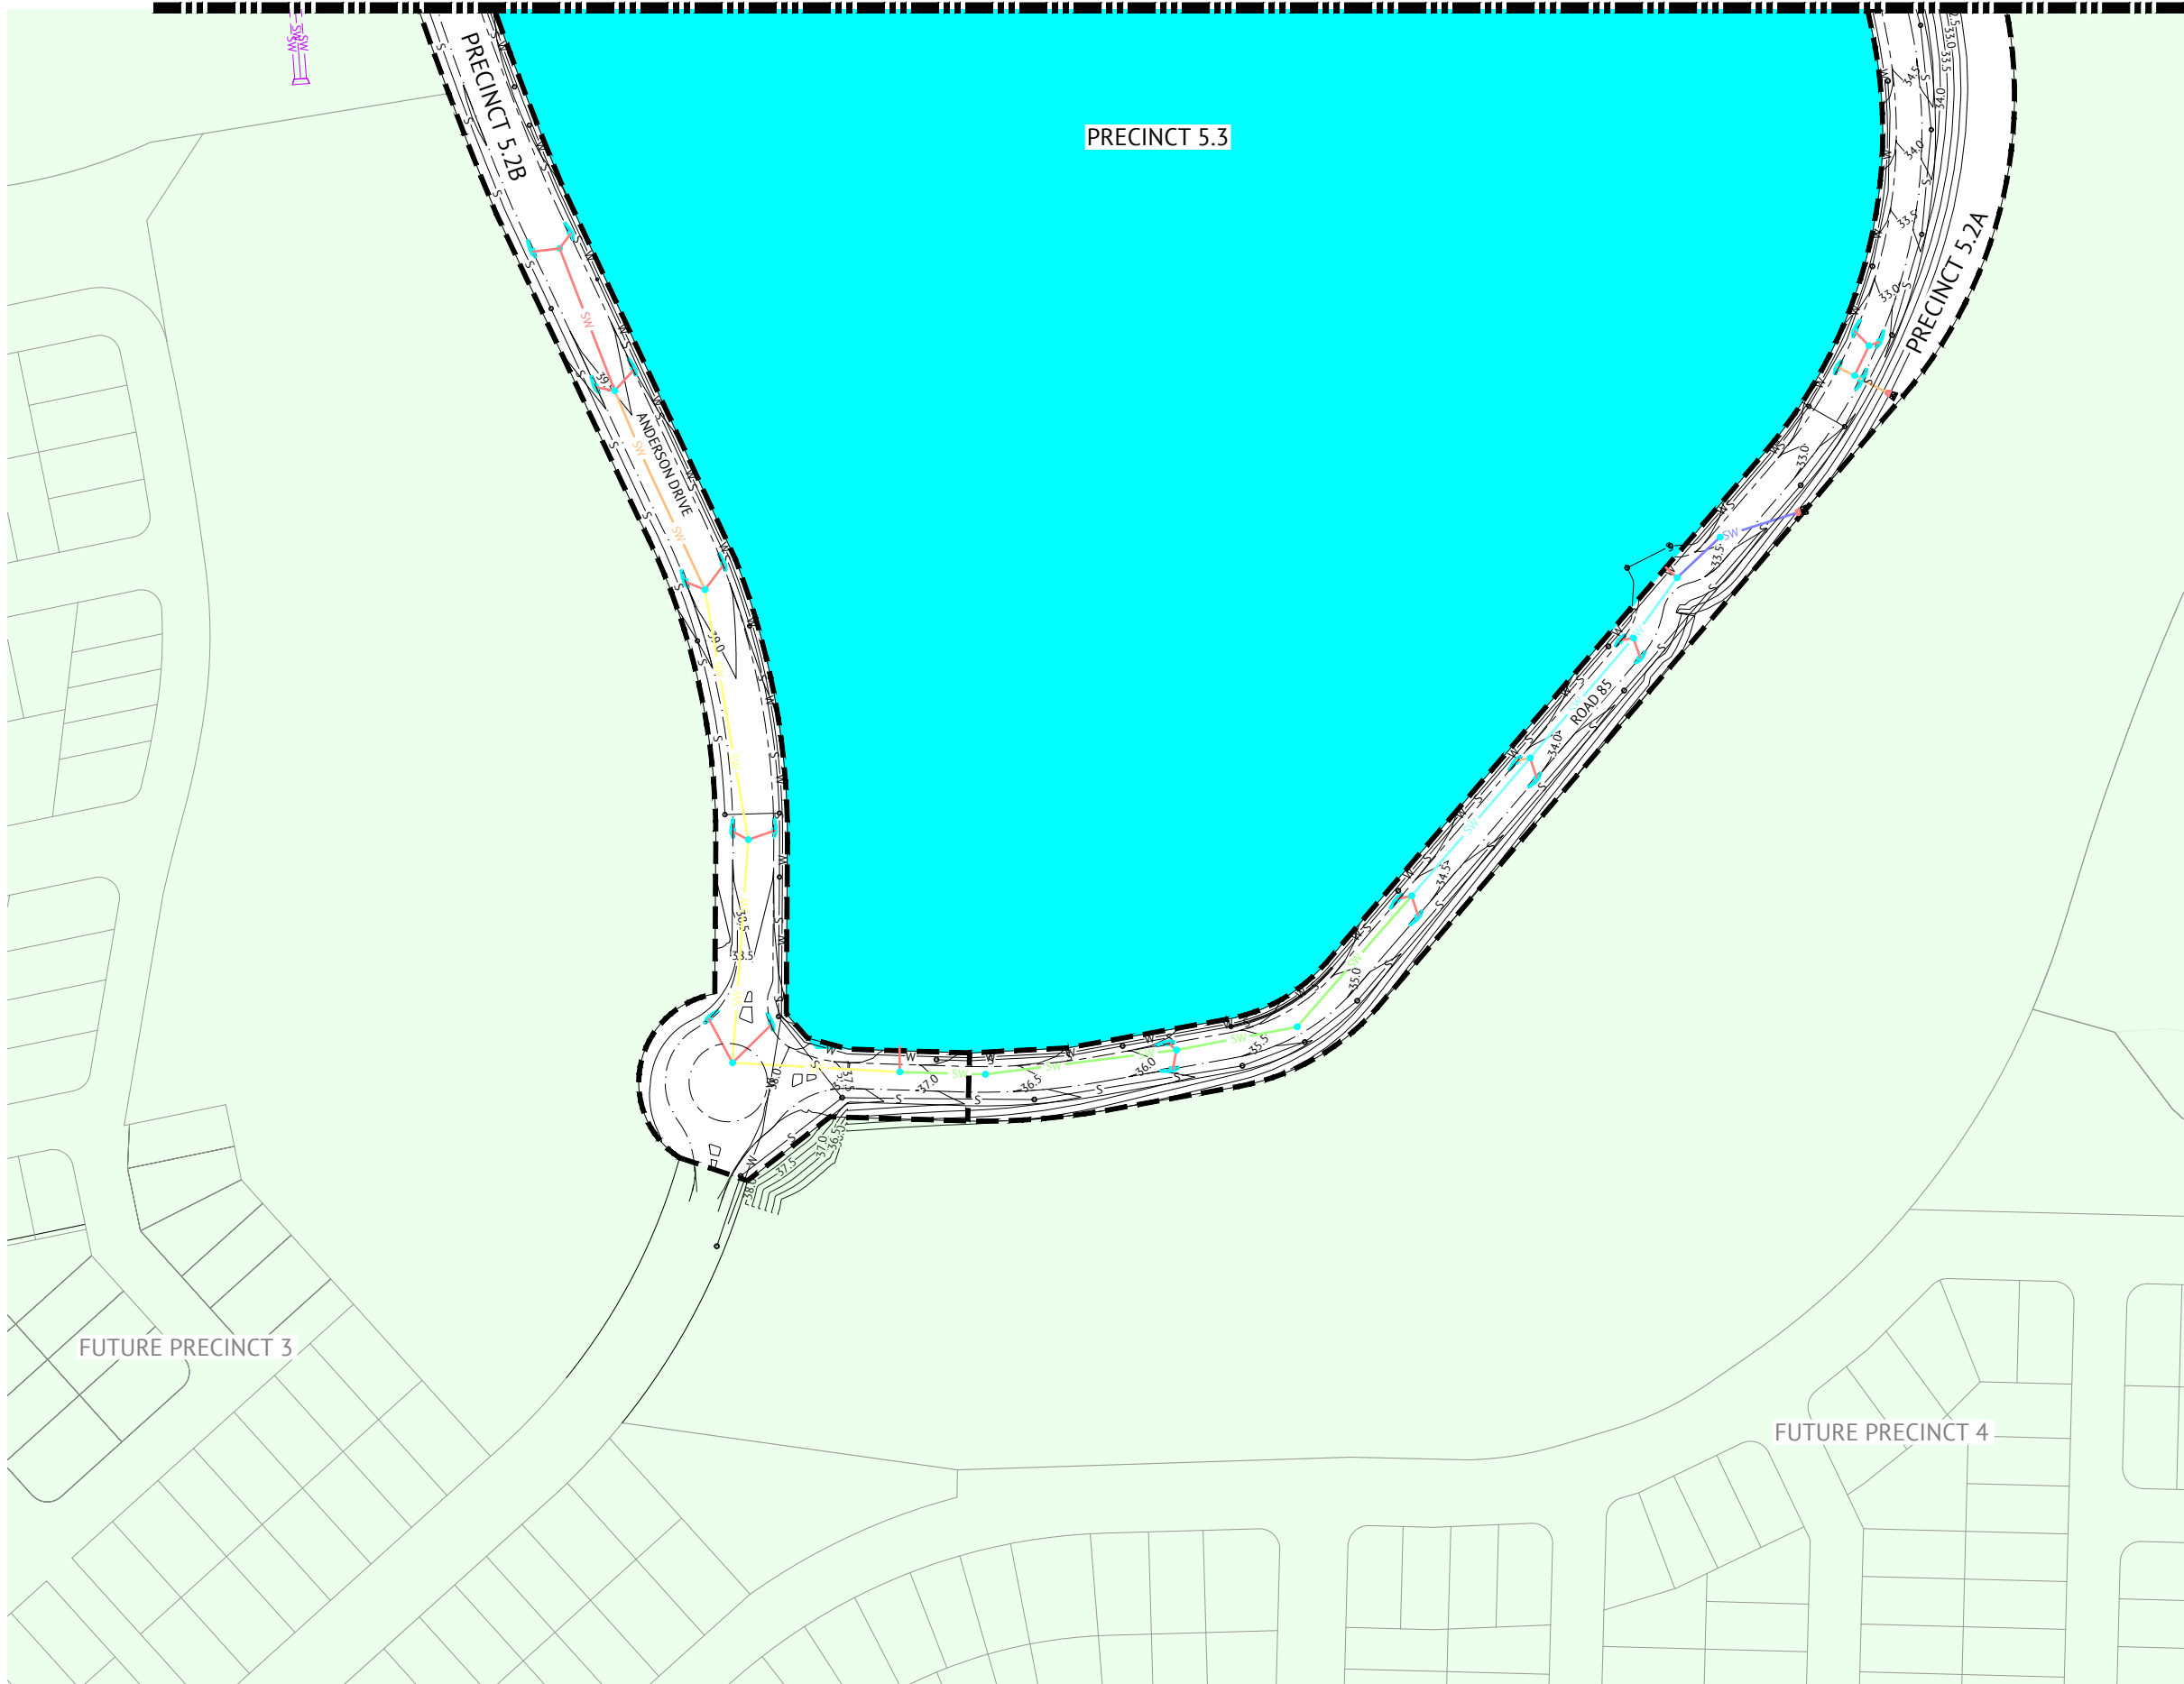

LEGEND - PROPOSED

- DN375 STORMWATER
- DN450 STORMWATER
- DN525 STORMWATER
- DN600 STORMWATER
- DN675 STORMWATER
- DN750 STORMWATER
- DN825 STORMWATER
- DN900 STORMWATER
- DN1050 STORMWATER
- DN1200 STORMWATER
- 900x450 BOX CULVERT
- OVERLAND FLOW PATH
- FINISHED CONTOURS (0.50m)
- PROPOSED IPWEA STD TYPE 'B1' KERB & CHANNEL. REFER IPWEA STD DWG RS-080.
- PROPOSED IPWEA STD TYPE 'B2' KERB ONLY. REFER IPWEA STD DWG RS-080.
- PROPOSED IPWEA TYPE 'M3' KERB & CHANNEL. REFER IPWEA STD DWG RS-080.
- PROPOSED IPWEA STD TYPE 'ER1' EDGE RESTRAINT. REFER IPWEA STD DWG RS-080.
- PROPOSED IPWEA INVERT. REFER IPWEA STD DWG RS-080.
- IPWEA STD TYPE 'SM5' KERB ONLY. REFER IPWEA STD DWG RS-080.
- GRAVITY SEWER
- SEWER RISING MAIN
- WATER
- PRECINCT BOUNDARY

LEGEND - EXISTING

- STORMWATER
- GRAVITY SEWER
- SEWER RISING MAIN
- WATER
- ELECTRICAL
- TELSTRA
- GAS


PRELIMINARY - NOT FOR CONSTRUCTION

DATE	REV	DESCRIPTION	REC	APP
05/11/2024	4	UPDATED STORMWATER AS PER CHANGES TO LOT LAYOUT	KK	NS
22/05/2024	3	ADDED BOX CULVERT TO LEGEND	KK	NS
14/05/2024	2	UPDATED TO PRECINCT NUMBERS AND LAYOUT	KK	NS
10/02/2022	1	PRELIMINARY - NOT FOR CONSTRUCTION	KK	NS



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ENGINEERING CERTIFICATION
PATRICK BRADY RPEQ 7112

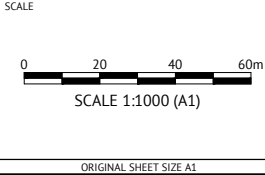

CLIENT
MIRVAC QLD PTY LTD
PROJECT
EVERLEIGH ROL13 SUBDIVISION DEVELOPMENT
LOCATION
TEVIOT ROAD, GREENBANK
SHEET TITLE
PRELIMINARY STORMWATER LAYOUT PLAN - SHEET 4

JOB CODE
MIR-1300
SHEET NUMBER
SKC50
REV
4

APPENDIX G

PRELIMINARY SEWER RETICULATION PLANS




LEGEND - PROPOSED

- DN150 PVC GRAVITY SEWER (MAX. 3m DEEP)
- DN225 PVC GRAVITY SEWER (MAX. 3m DEEP)
- DN300 PVC GRAVITY SEWER (MAX. 3m DEEP)
- GRAVITY SEWER (DEPTH >3m)
- MAINTENANCE STRUCTURE
- DN250 SEWER RISING MAIN
- DRINKING WATER MAIN
- STORMWATER DRAINAGE
- FUTURE GRAVITY SEWER
- PRECINCT BOUNDARY

LEGEND - EXISTING

- GRAVITY SEWER
- SEWER RISING MAIN
- STORMWATER DRAINAGE
- WATER
- ELECTRICAL
- TELSTRA
- GAS

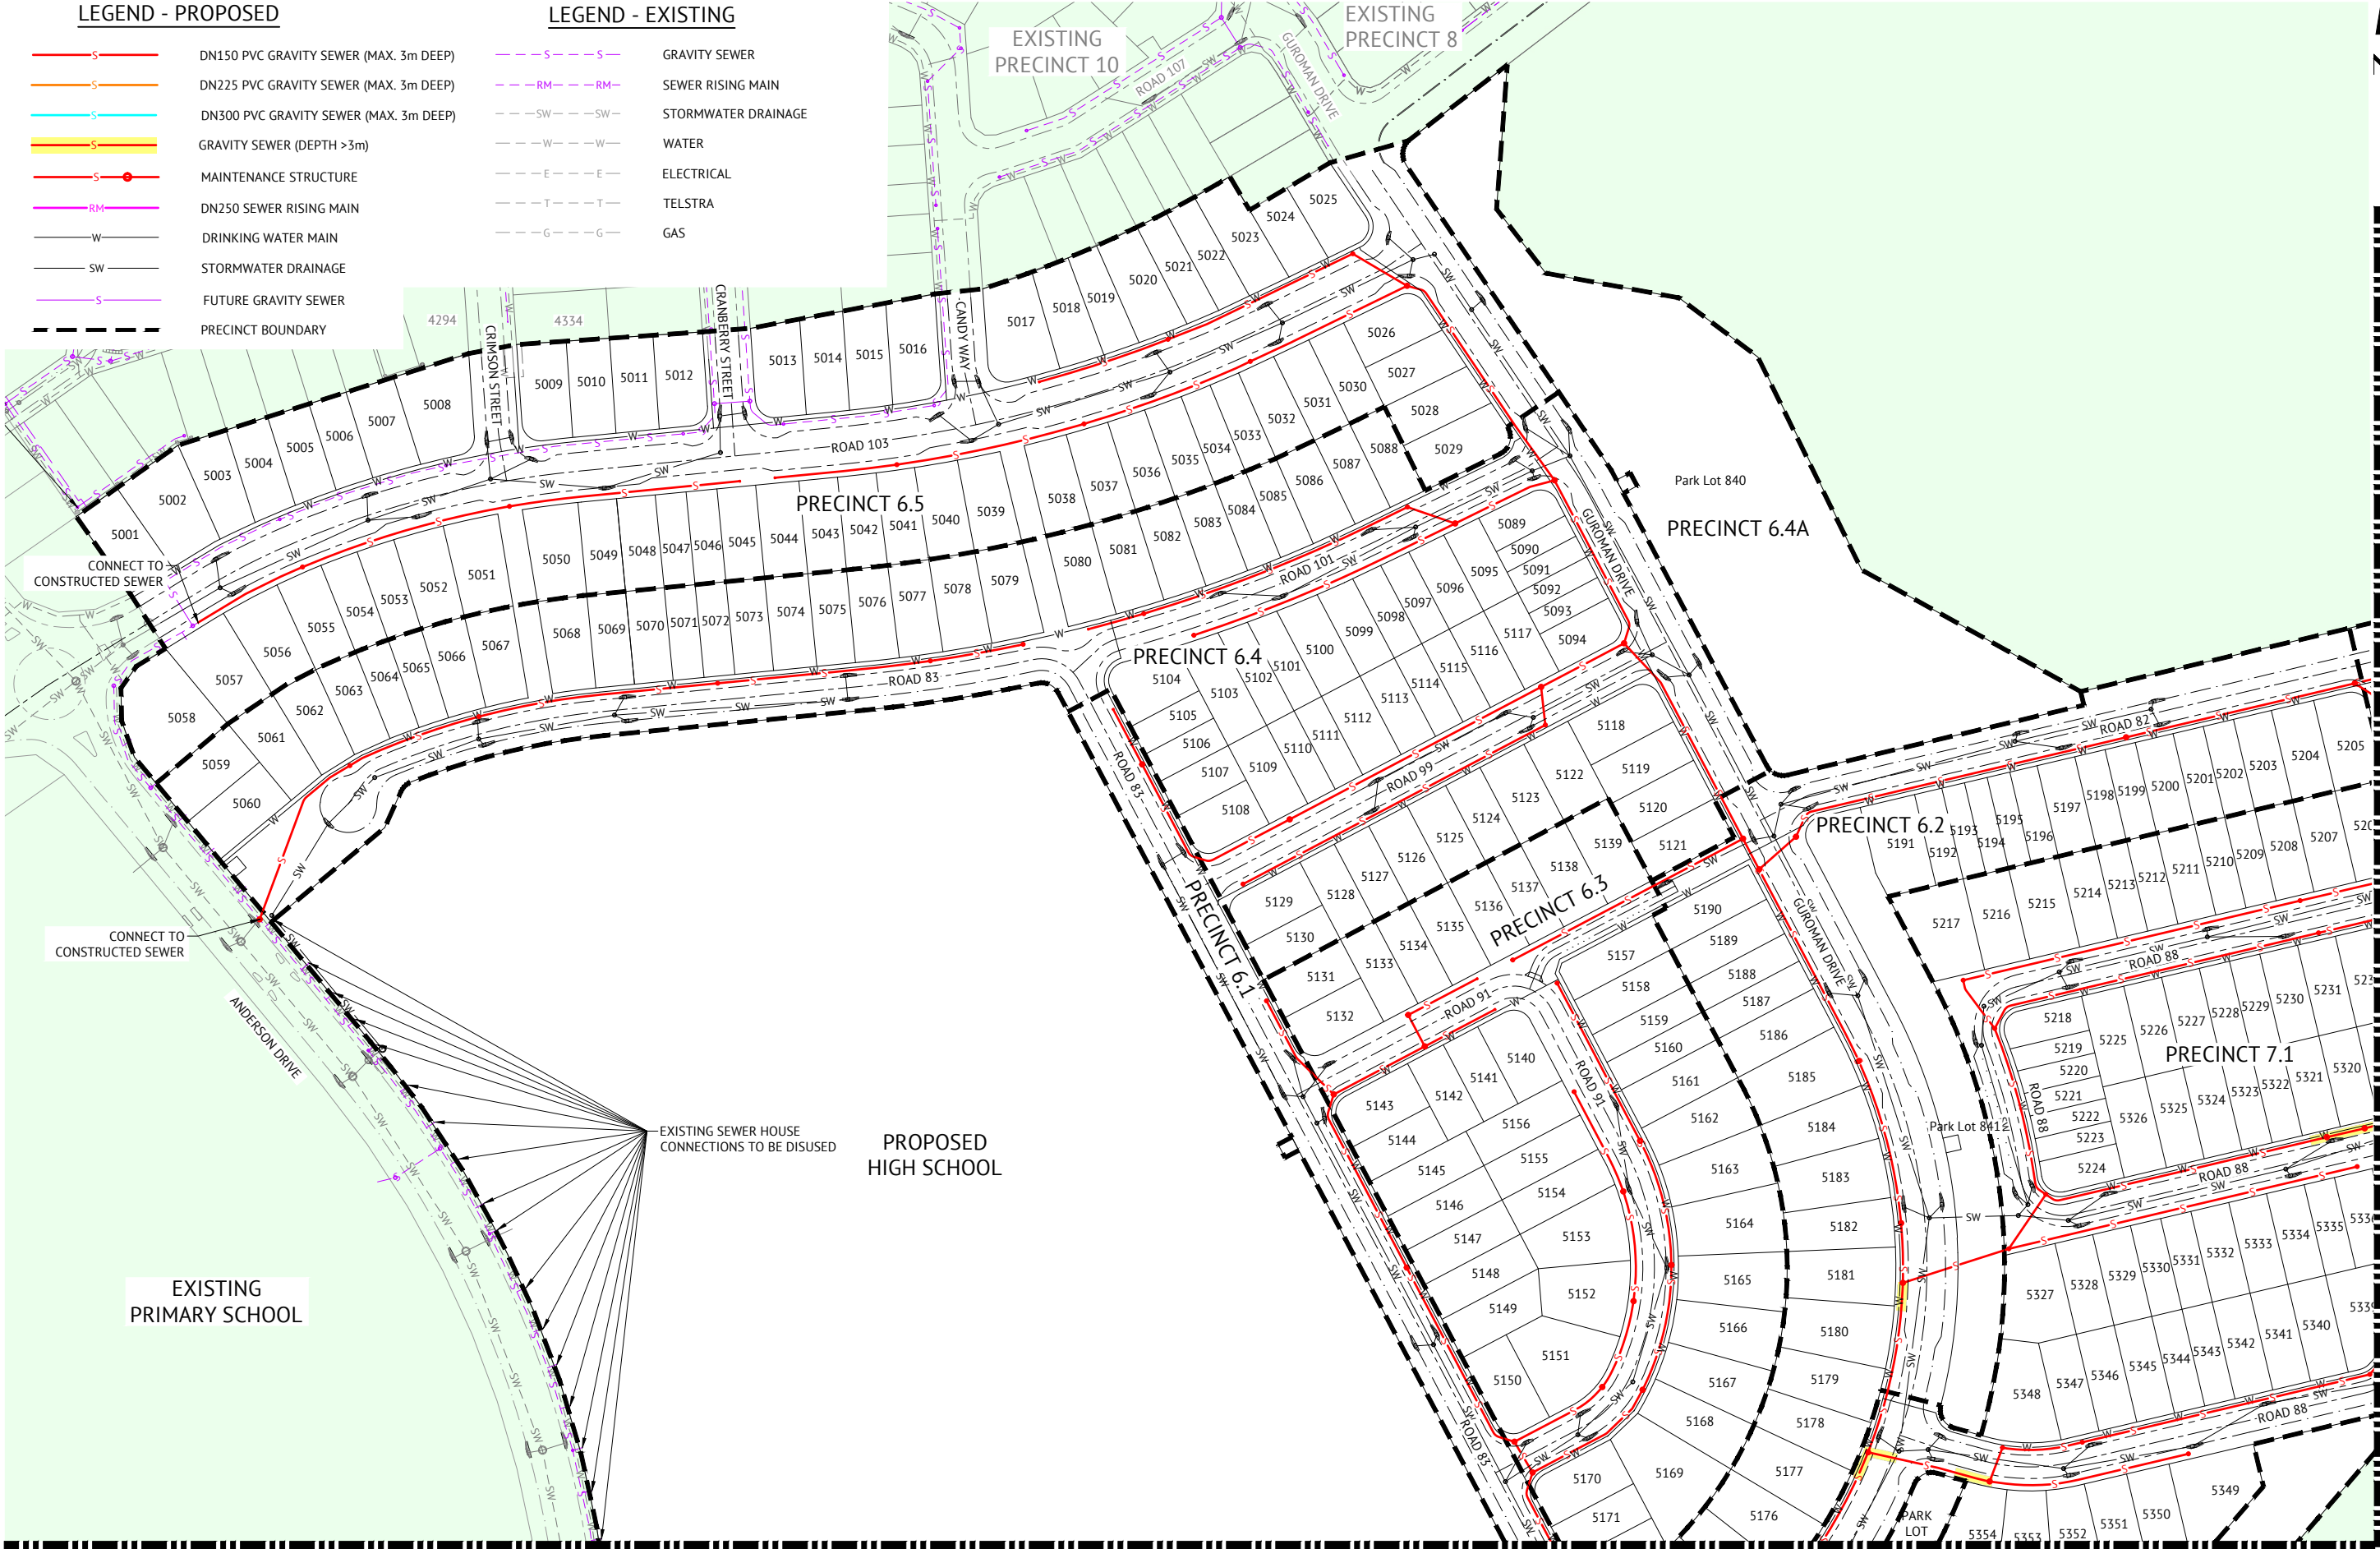

JOINS SHEET 3


PRELIMINARY - NOT FOR CONSTRUCTION

DATE	REV	DESCRIPTION	REC	APP
05/11/2024	4	UPDATED SEWER AS PER CHANGES TO LOT LAYOUT	KK	NS
14/05/2024	2	UPDATED TO PRECINCT NUMBERS AND LAYOUT	KK	NS
29/09/2023	1	PRELIMINARY - NOT FOR CONSTRUCTION	KK	NS



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ANDREW LANGDON
PROJECT MANAGER
NICK SOMERVILLE
ENGINEERING CERTIFICATION
PATRICK BRADY RPEQ 7112

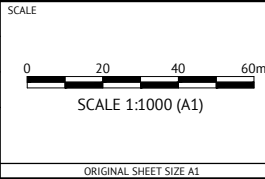

CLIENT

MIRVAC QLD PTY LTD

PROJECT

EVERLEIGH ROL13 SUBDIVISION DEVELOPMENT

LOCATION

TEVIOT ROAD, GREENBANK

SHEET TITLE

PRELIMINARY SEWER LAYOUT PLAN - SHEET 1

JOB CODE


MIR-1300

SHEET NUMBER

SKC51

REV

4

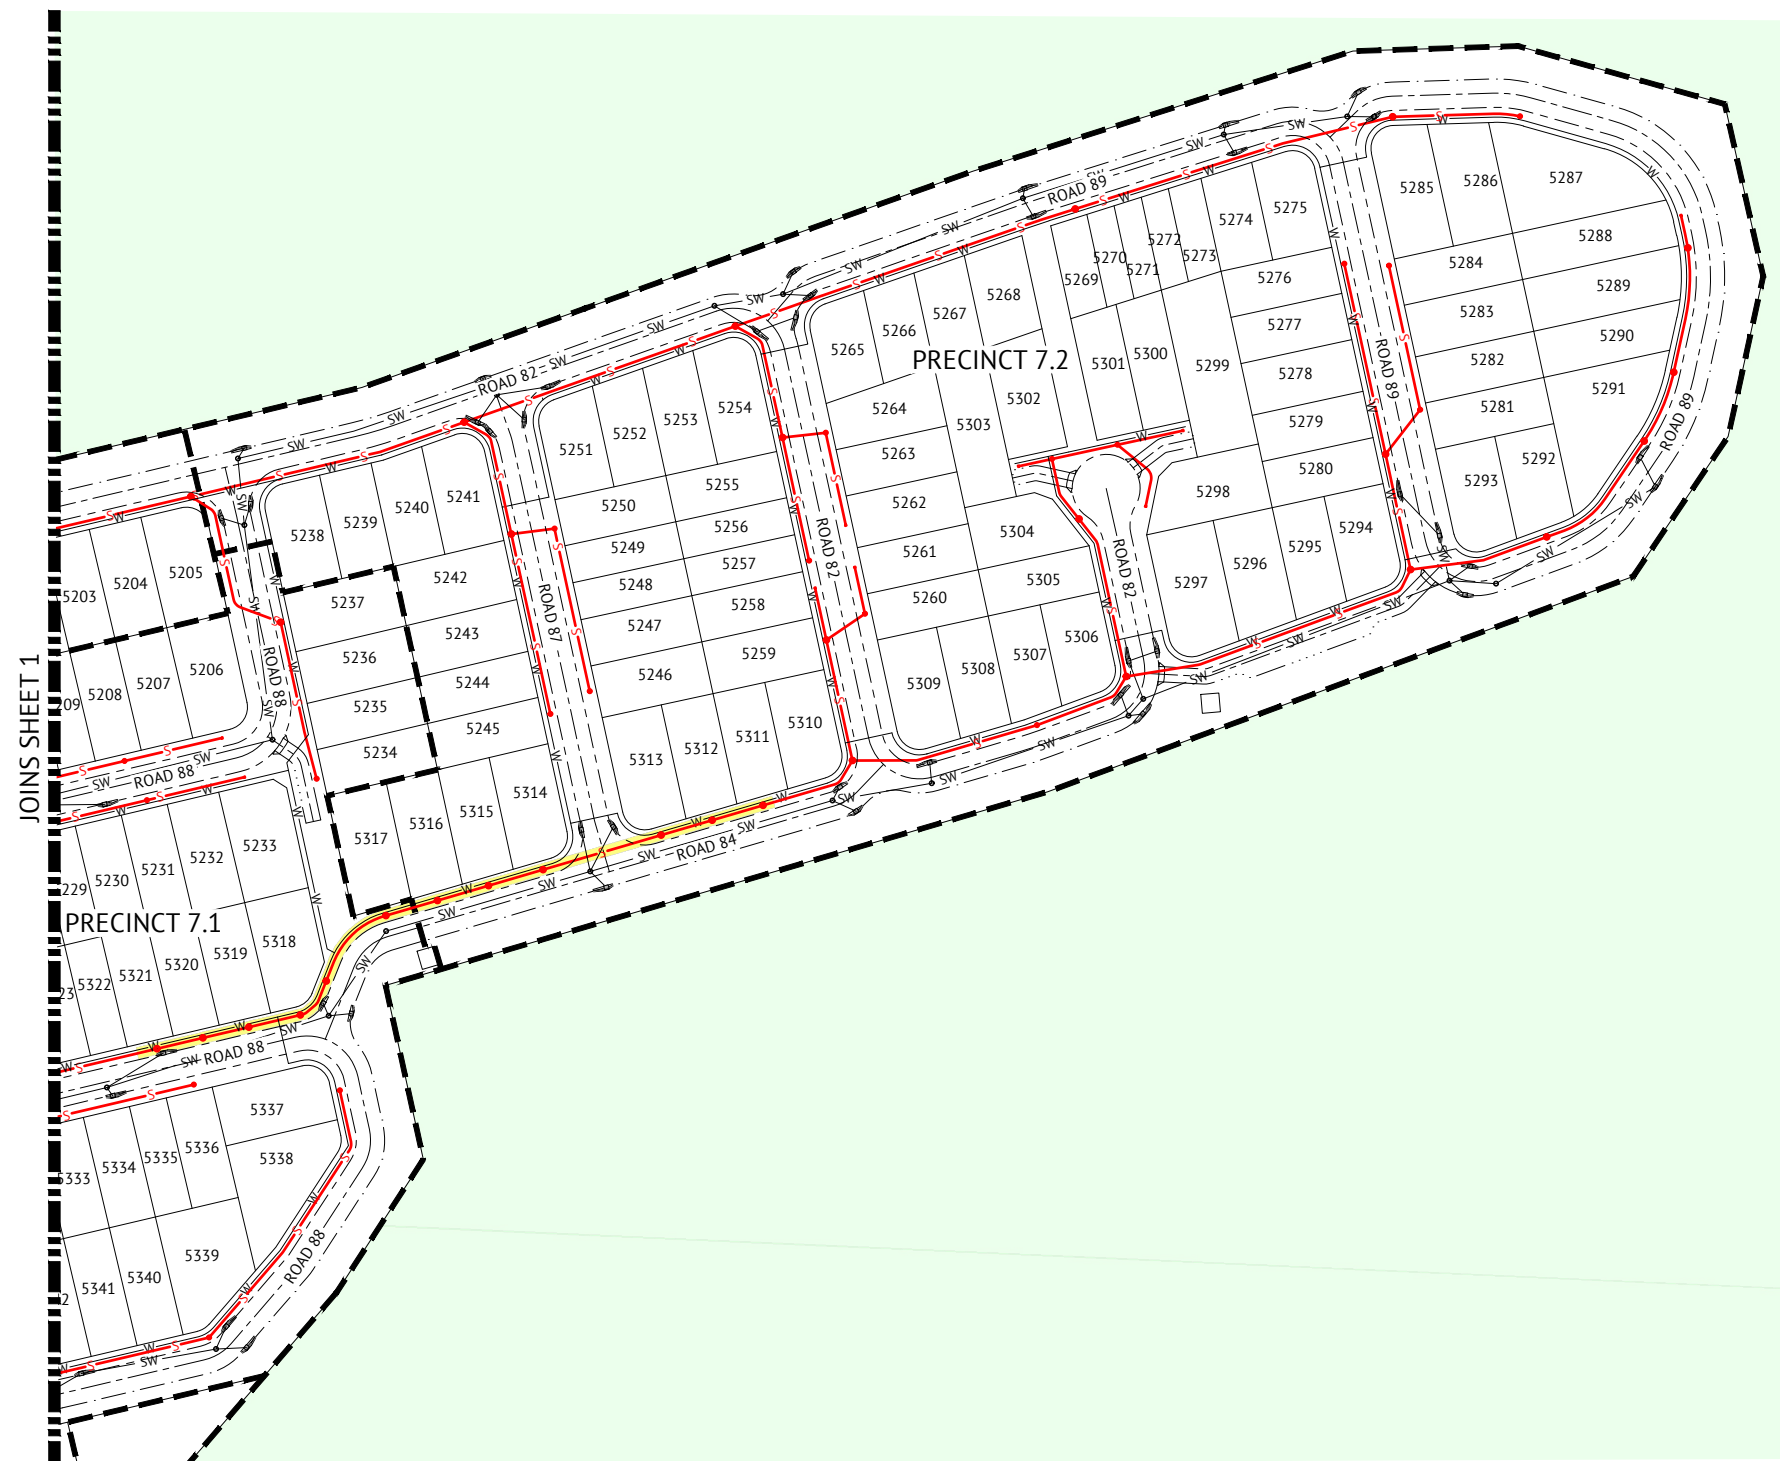

NOTE:
PROPOSED SEWER WITHIN PRECINCT 7.2 TO CROSS ABOVE
STORMWATER DRAINAGE TO MINIMISE LENGTH OF SEWER
MAIN OVER 3m DEEP AND NUMBER OF MAINTENANCE
STRUCTURES FOR HOUSE CONNECTIONS

LEGEND - PROPOSED

- DN150 PVC GRAVITY SEWER (MAX. 3m DEEP)
- DN225 PVC GRAVITY SEWER (MAX. 3m DEEP)
- DN300 PVC GRAVITY SEWER (MAX. 3m DEEP)
- GRAVITY SEWER (DEPTH >3m)
- MAINTENANCE STRUCTURE
- DN250 SEWER RISING MAIN
- DRINKING WATER MAIN
- STORMWATER DRAINAGE
- FUTURE GRAVITY SEWER
- PRECINCT BOUNDARY

LEGEND - EXISTING

- GRAVITY SEWER
- SEWER RISING MAIN
- STORMWATER DRAINAGE
- WATER
- ELECTRICAL
- TELSTRA
- GAS

PRELIMINARY - NOT FOR CONSTRUCTION

DATE	REV	DESCRIPTION	REC	APP
05/11/2024	4	UPDATED SEWER AS PER CHANGES TO LOT LAYOUT	KK	NS
14/05/2024	2	UPDATED TO PRECINCT NUMBERS AND LAYOUT	KK	NS
29/09/2023	1	PRELIMINARY - NOT FOR CONSTRUCTION	KK	NS




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CHECKED
ANDREW LANGDON
PROJECT MANAGER
NICK SOMERVILLE
ENGINEERING CERTIFICATION
PATRICK BRADY RPEQ 7112

SCALE
0 20 40 60m
SCALE 1:1000 (A1)
ORIGINAL SHEET SIZE A1

CLIENT	MIRVAC QLD PTY LTD	JOB CODE	MIR-1300
PROJECT	EVERLEIGH ROL13 SUBDIVISION DEVELOPMENT	SHEET NUMBER	SKC52
LOCATION	TEVIOT ROAD, GREENBANK	REV	4
SHEET TITLE	PRELIMINARY SEWER LAYOUT PLAN - SHEET 2		

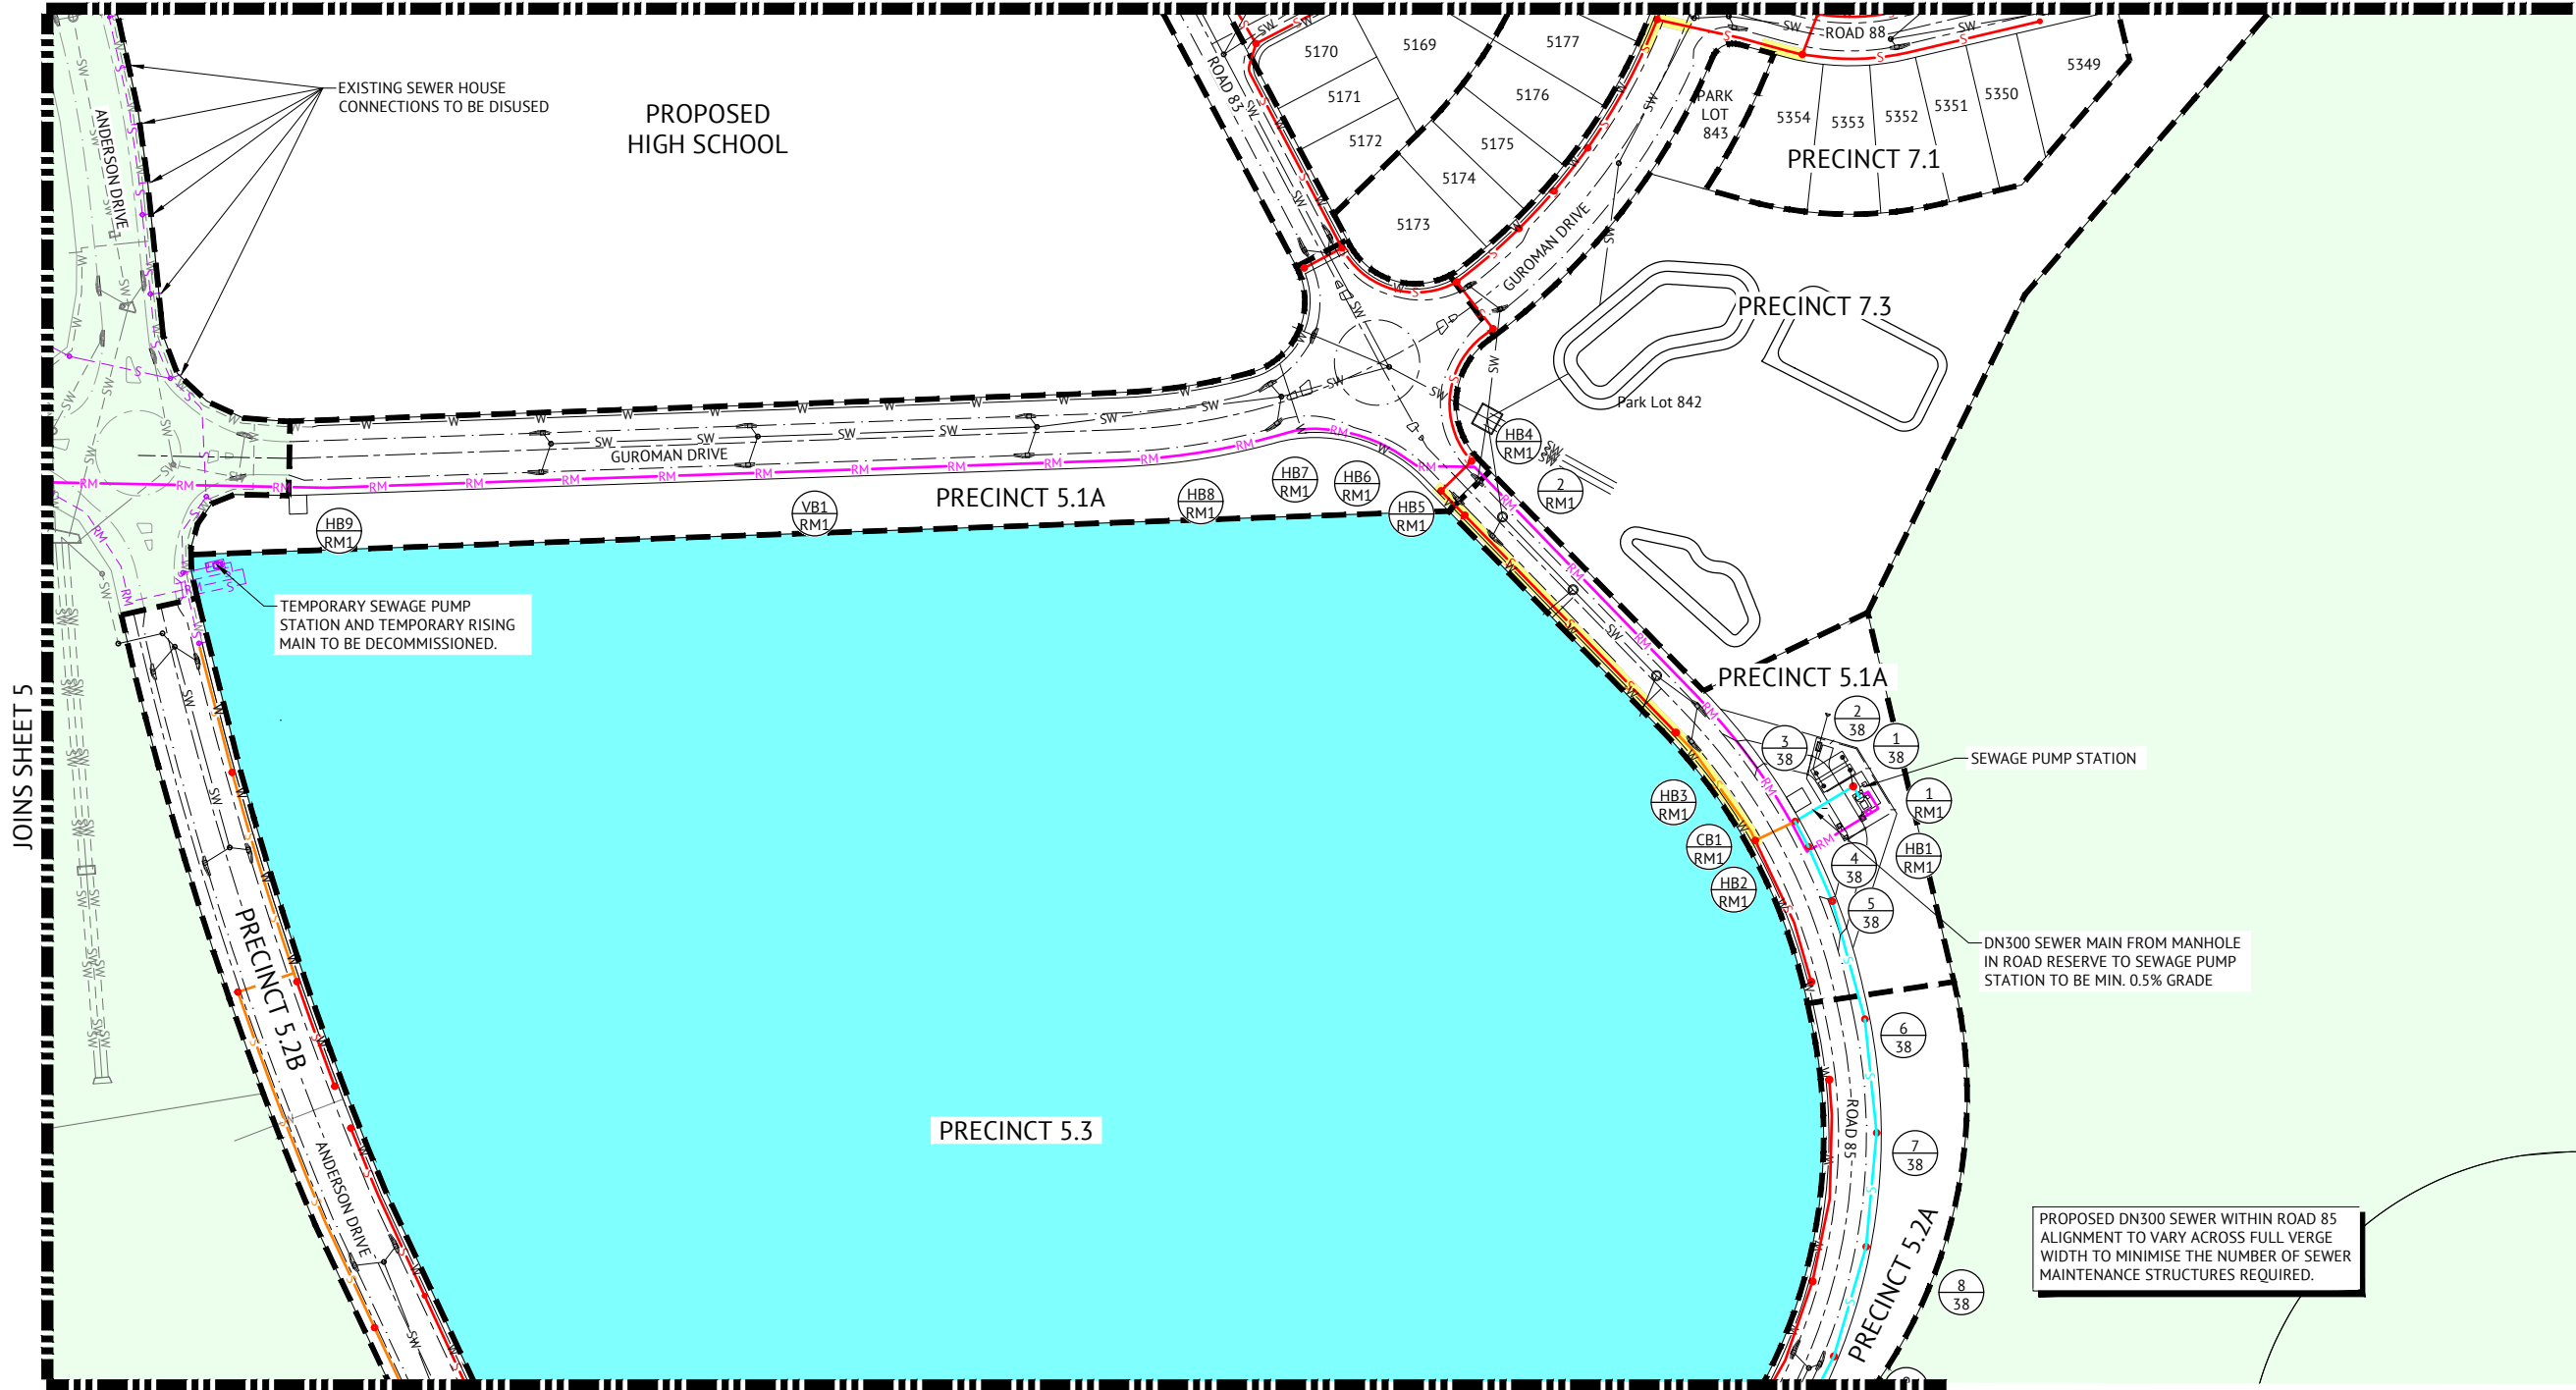

LEGEND - PROPOSED

- DN150 PVC GRAVITY SEWER (MAX. 3m DEEP)
- DN225 PVC GRAVITY SEWER (MAX. 3m DEEP)
- DN300 PVC GRAVITY SEWER (MAX. 3m DEEP)
- GRAVITY SEWER (DEPTH >3m)
- MAINTENANCE STRUCTURE
- DN250 SEWER RISING MAIN
- DRINKING WATER MAIN
- STORMWATER DRAINAGE
- FUTURE GRAVITY SEWER
- PRECINCT BOUNDARY

LEGEND - EXISTING

- GRAVITY SEWER
- SEWER RISING MAIN
- STORMWATER DRAINAGE
- WATER
- ELECTRICAL
- TELSTRA
- GAS


PRELIMINARY - NOT FOR CONSTRUCTION

DATE	REV	DESCRIPTION	REVISIONS
05/11/2024	4	UPDATED SEWER AS PER CHANGES TO LOT LAYOUT	KK NS
22/05/2024	3	AMENDED STORMWATER LAYOUT	KK NS
14/05/2024	2	UPDATED TO PRECINCT NUMBERS AND LAYOUT	KK NS
29/09/2023	1	PRELIMINARY - NOT FOR CONSTRUCTION	KK NS




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WEB: www.premise.com.au

DESIGNED
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CHECKED
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PROJECT MANAGER
NICK SOMERVILLE
ENGINEERING CERTIFICATION
PATRICK BRADY RPEQ 7112

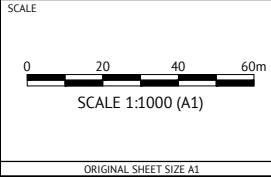

CLIENT
MIRVAC QLD PTY LTD
PROJECT
EVERLEIGH ROL13 SUBDIVISION DEVELOPMENT
LOCATION
TEVIOT ROAD, GREENBANK
SHEET TITLE
PRELIMINARY SEWER LAYOUT PLAN - SHEET 3

JOB CODE
MIR-1300
SHEET NUMBER
SKC53
REV
4

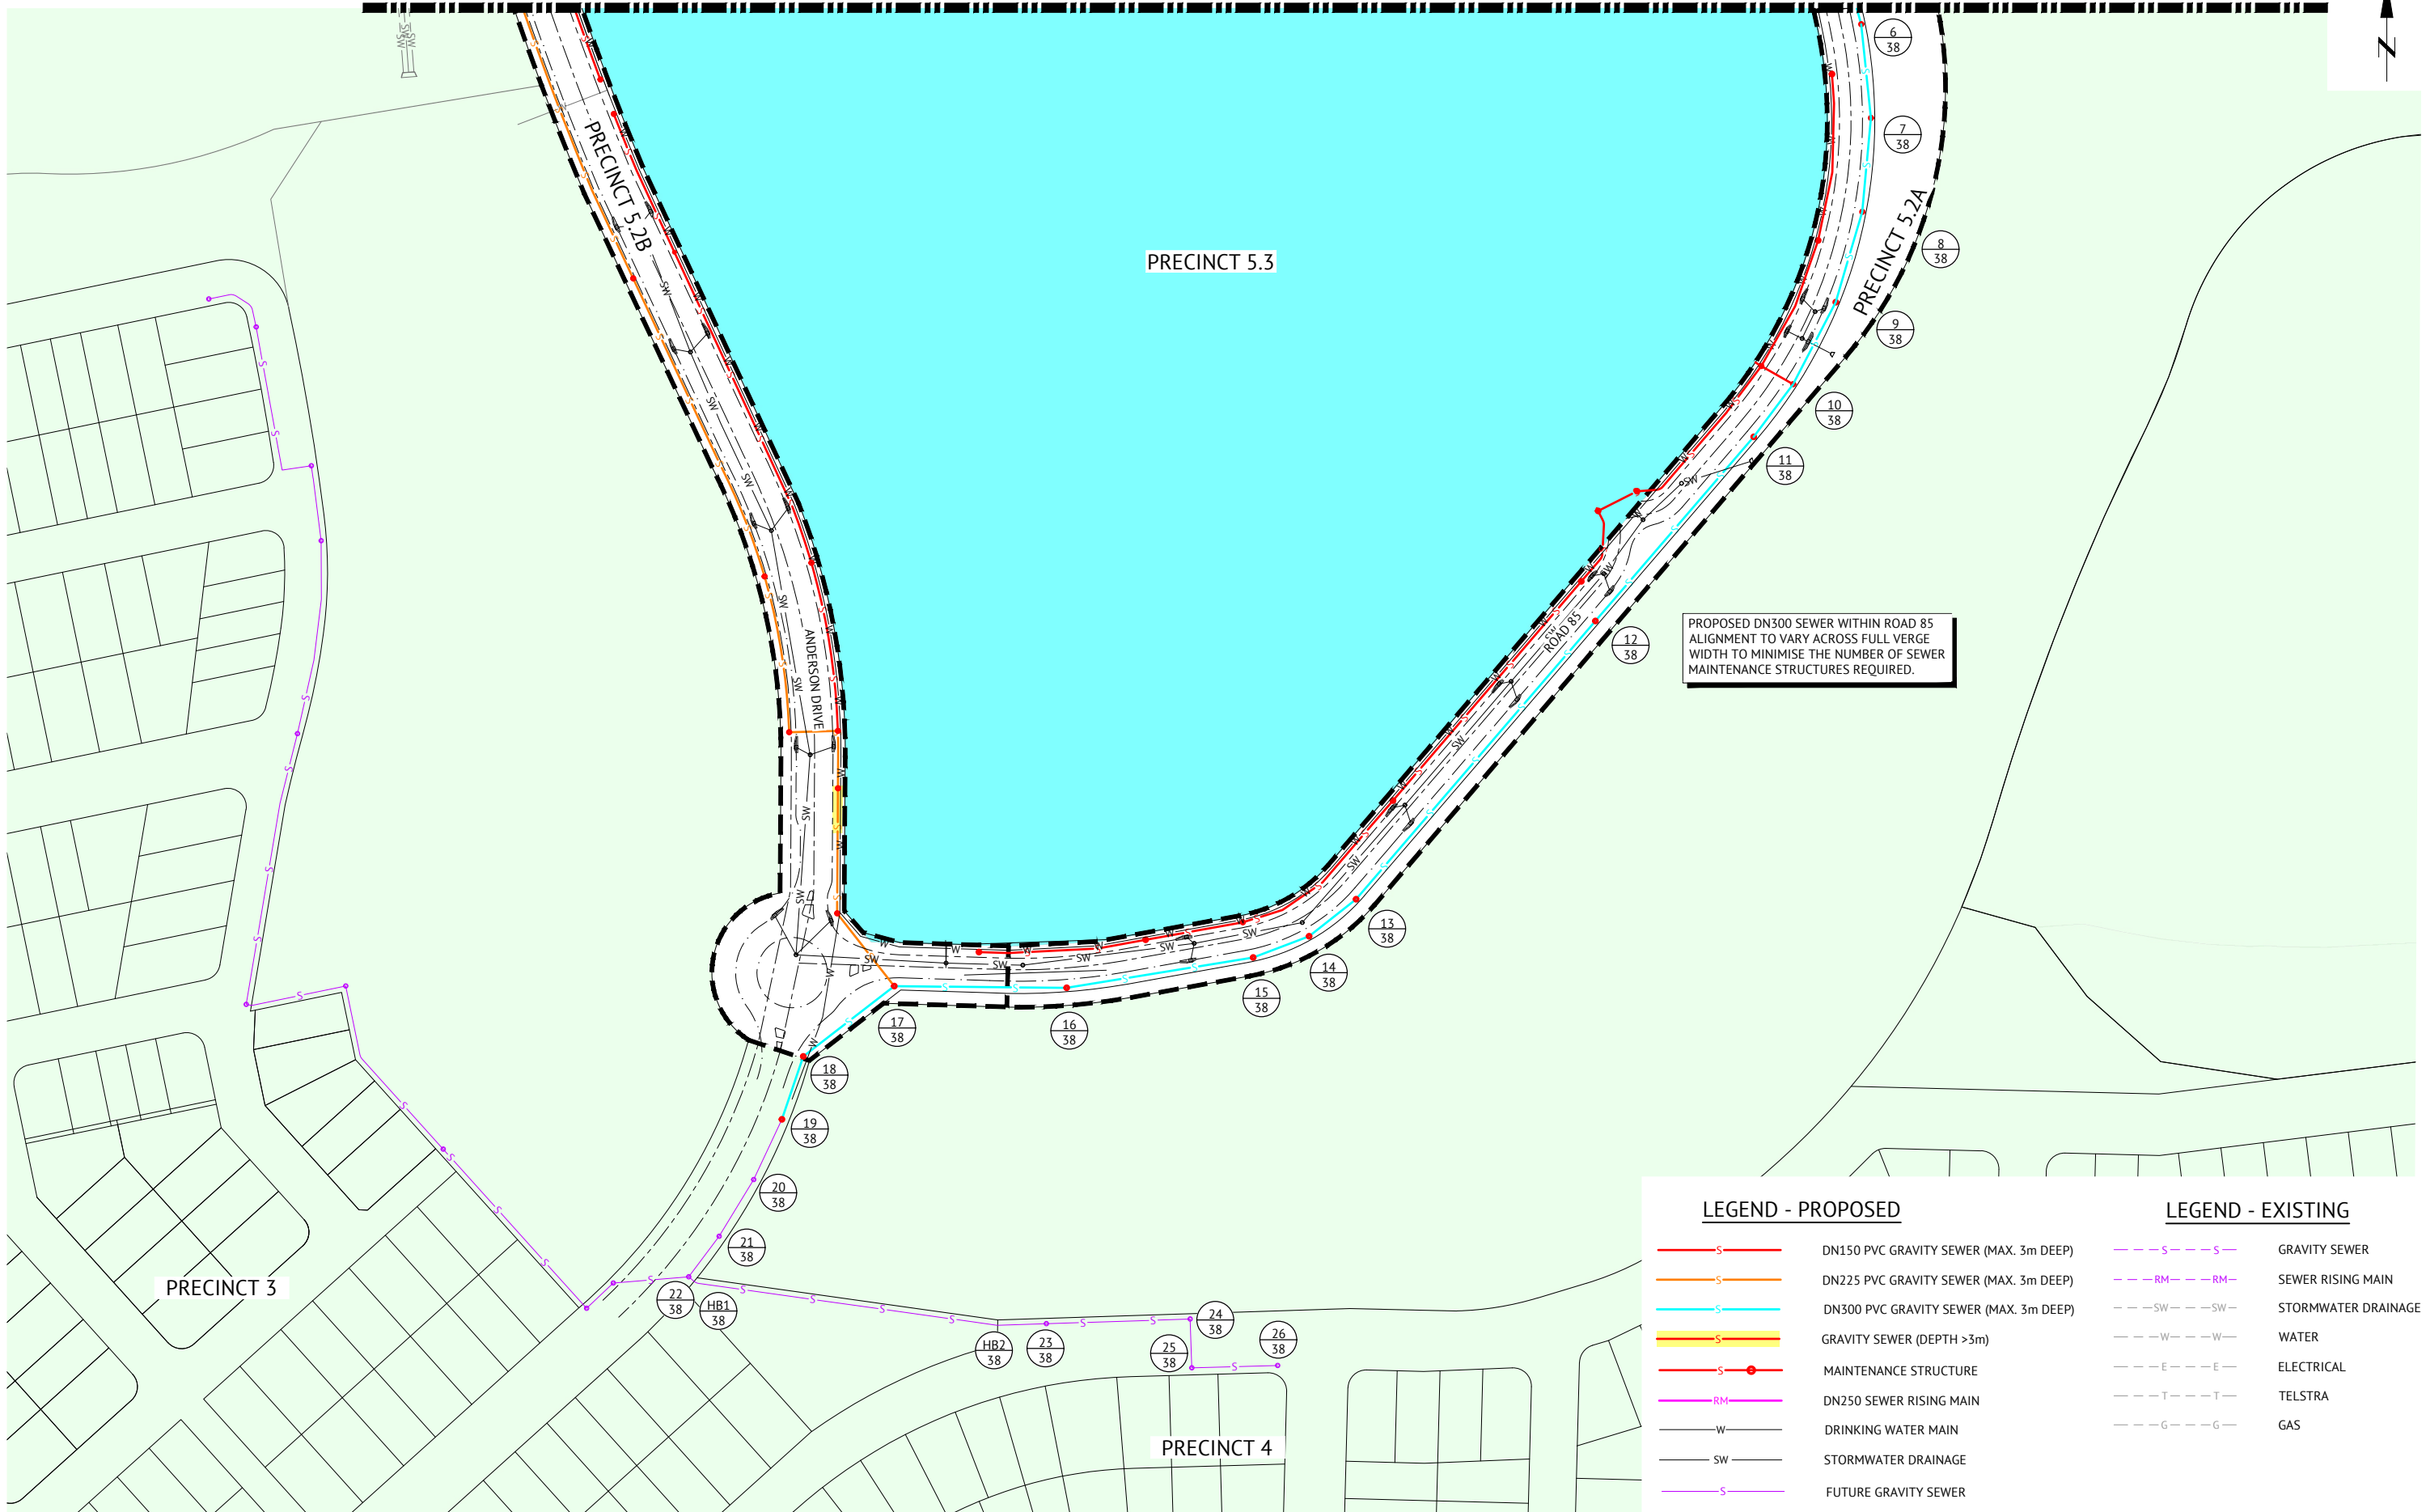

LEGEND - PROPOSED

- DN150 PVC GRAVITY SEWER (MAX. 3m DEEP)
- DN225 PVC GRAVITY SEWER (MAX. 3m DEEP)
- DN300 PVC GRAVITY SEWER (MAX. 3m DEEP)
- GRAVITY SEWER (DEPTH >3m)
- MAINTENANCE STRUCTURE
- DN250 SEWER RISING MAIN
- DRINKING WATER MAIN
- STORMWATER DRAINAGE
- FUTURE GRAVITY SEWER
- PRECINCT BOUNDARY

LEGEND - EXISTING

- GRAVITY SEWER
- SEWER RISING MAIN
- STORMWATER DRAINAGE
- WATER
- ELECTRICAL
- TELSTRA
- GAS


PRELIMINARY - NOT FOR CONSTRUCTION

DATE	REV	DESCRIPTION	REC	APP
05/11/2024	3	UPDATED SEWER AS PER CHANGES TO LOT LAYOUT	KK	NS
14/05/2024	2	UPDATED TO PRECINCT NUMBERS AND LAYOUT	KK	NS
29/09/2023	1	PRELIMINARY - NOT FOR CONSTRUCTION	KK	NS




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ANDREW LANGDON
PROJECT MANAGER
NICK SOMERVILLE
ENGINEERING CERTIFICATION
PATRICK BRADY RPEQ 7112

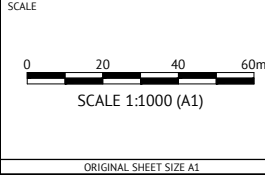

CLIENT	MIRVAC QLD PTY LTD	JOB CODE	MIR-1300
PROJECT	EVERLEIGH ROL13 SUBDIVISION DEVELOPMENT	SHEET NUMBER	SKC54
LOCATION	TEVIOT ROAD, GREENBANK	REV	3
SHEET TITLE	PRELIMINARY SEWER LAYOUT PLAN - SHEET 4		

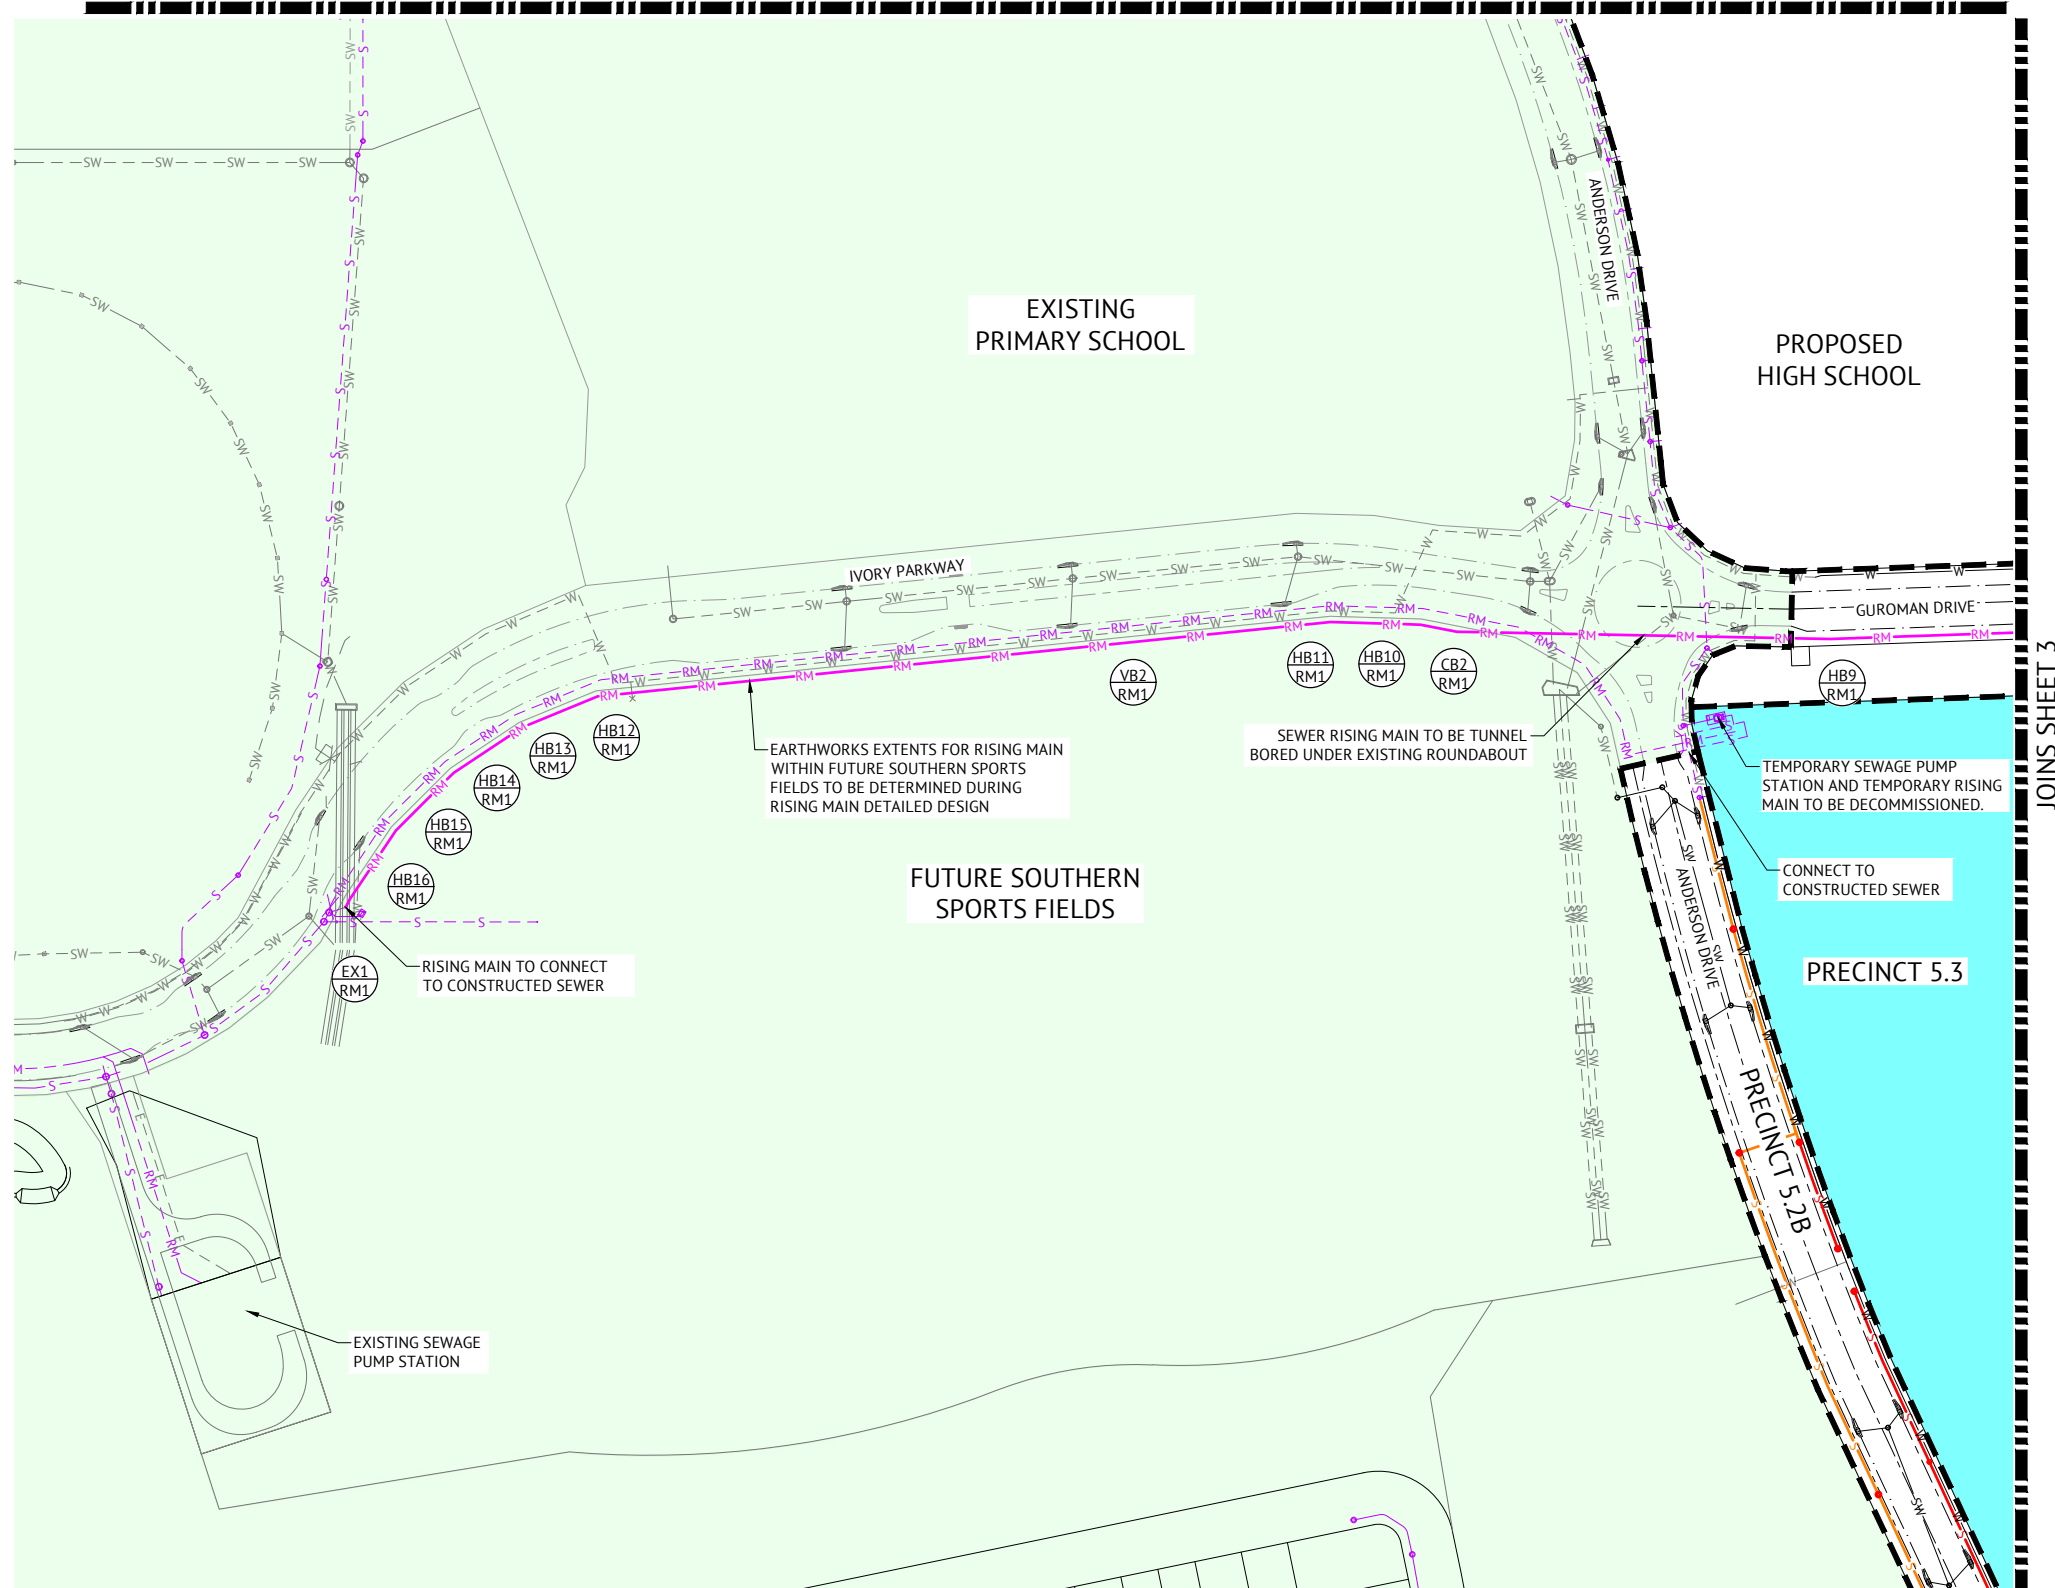

LEGEND - PROPOSED

	DN150 PVC GRAVITY SEWER (MAX. 3m DEEP)
	DN225 PVC GRAVITY SEWER (MAX. 3m DEEP)
	DN300 PVC GRAVITY SEWER (MAX. 3m DEEP)
	GRAVITY SEWER (DEPTH >3m)
	MAINTENANCE STRUCTURE
	DN250 SEWER RISING MAIN
	DRINKING WATER MAIN
	STORMWATER DRAINAGE
	FUTURE GRAVITY SEWER
	PRECINCT BOUNDARY

LEGEND - EXISTING

	GRAVITY SEWER
	SEWER RISING MAIN
	STORMWATER DRAINAGE
	WATER
	ELECTRICAL
	TELSTRA
	GAS

PRELIMINARY - NOT FOR CONSTRUCTION


DATE	REV	DESCRIPTION	REC	APP
14/05/2024	2	UPDATED TO PRECINCT NUMBERS AND LAYOUT	KK	NS
29/09/2023	1	PRELIMINARY - NOT FOR CONSTRUCTION	KK	NS



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DESIGNED
KLYNT KIWANG
CHECKED
ANDREW LANGDON
PROJECT MANAGER
NICK SOMERVILLE
ENGINEERING CERTIFICATION

PATRICK BRADY RPEQ 7112

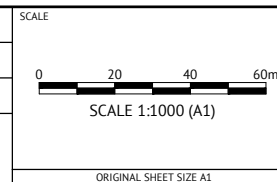

CLIENT

MIRVAC QLD PTY LTD

PROJECT

EVERLEIGH ROL13 SUBDIVISION DEVELOPMENT

LOCATION

TEVIOT ROAD, GREENBANK

SHEET TITLE

PRELIMINARY SEWER LAYOUT PLAN - SHEET 5

JOB CODE


MIR-1300

SHEET NUMBER

SKC55

REV

2

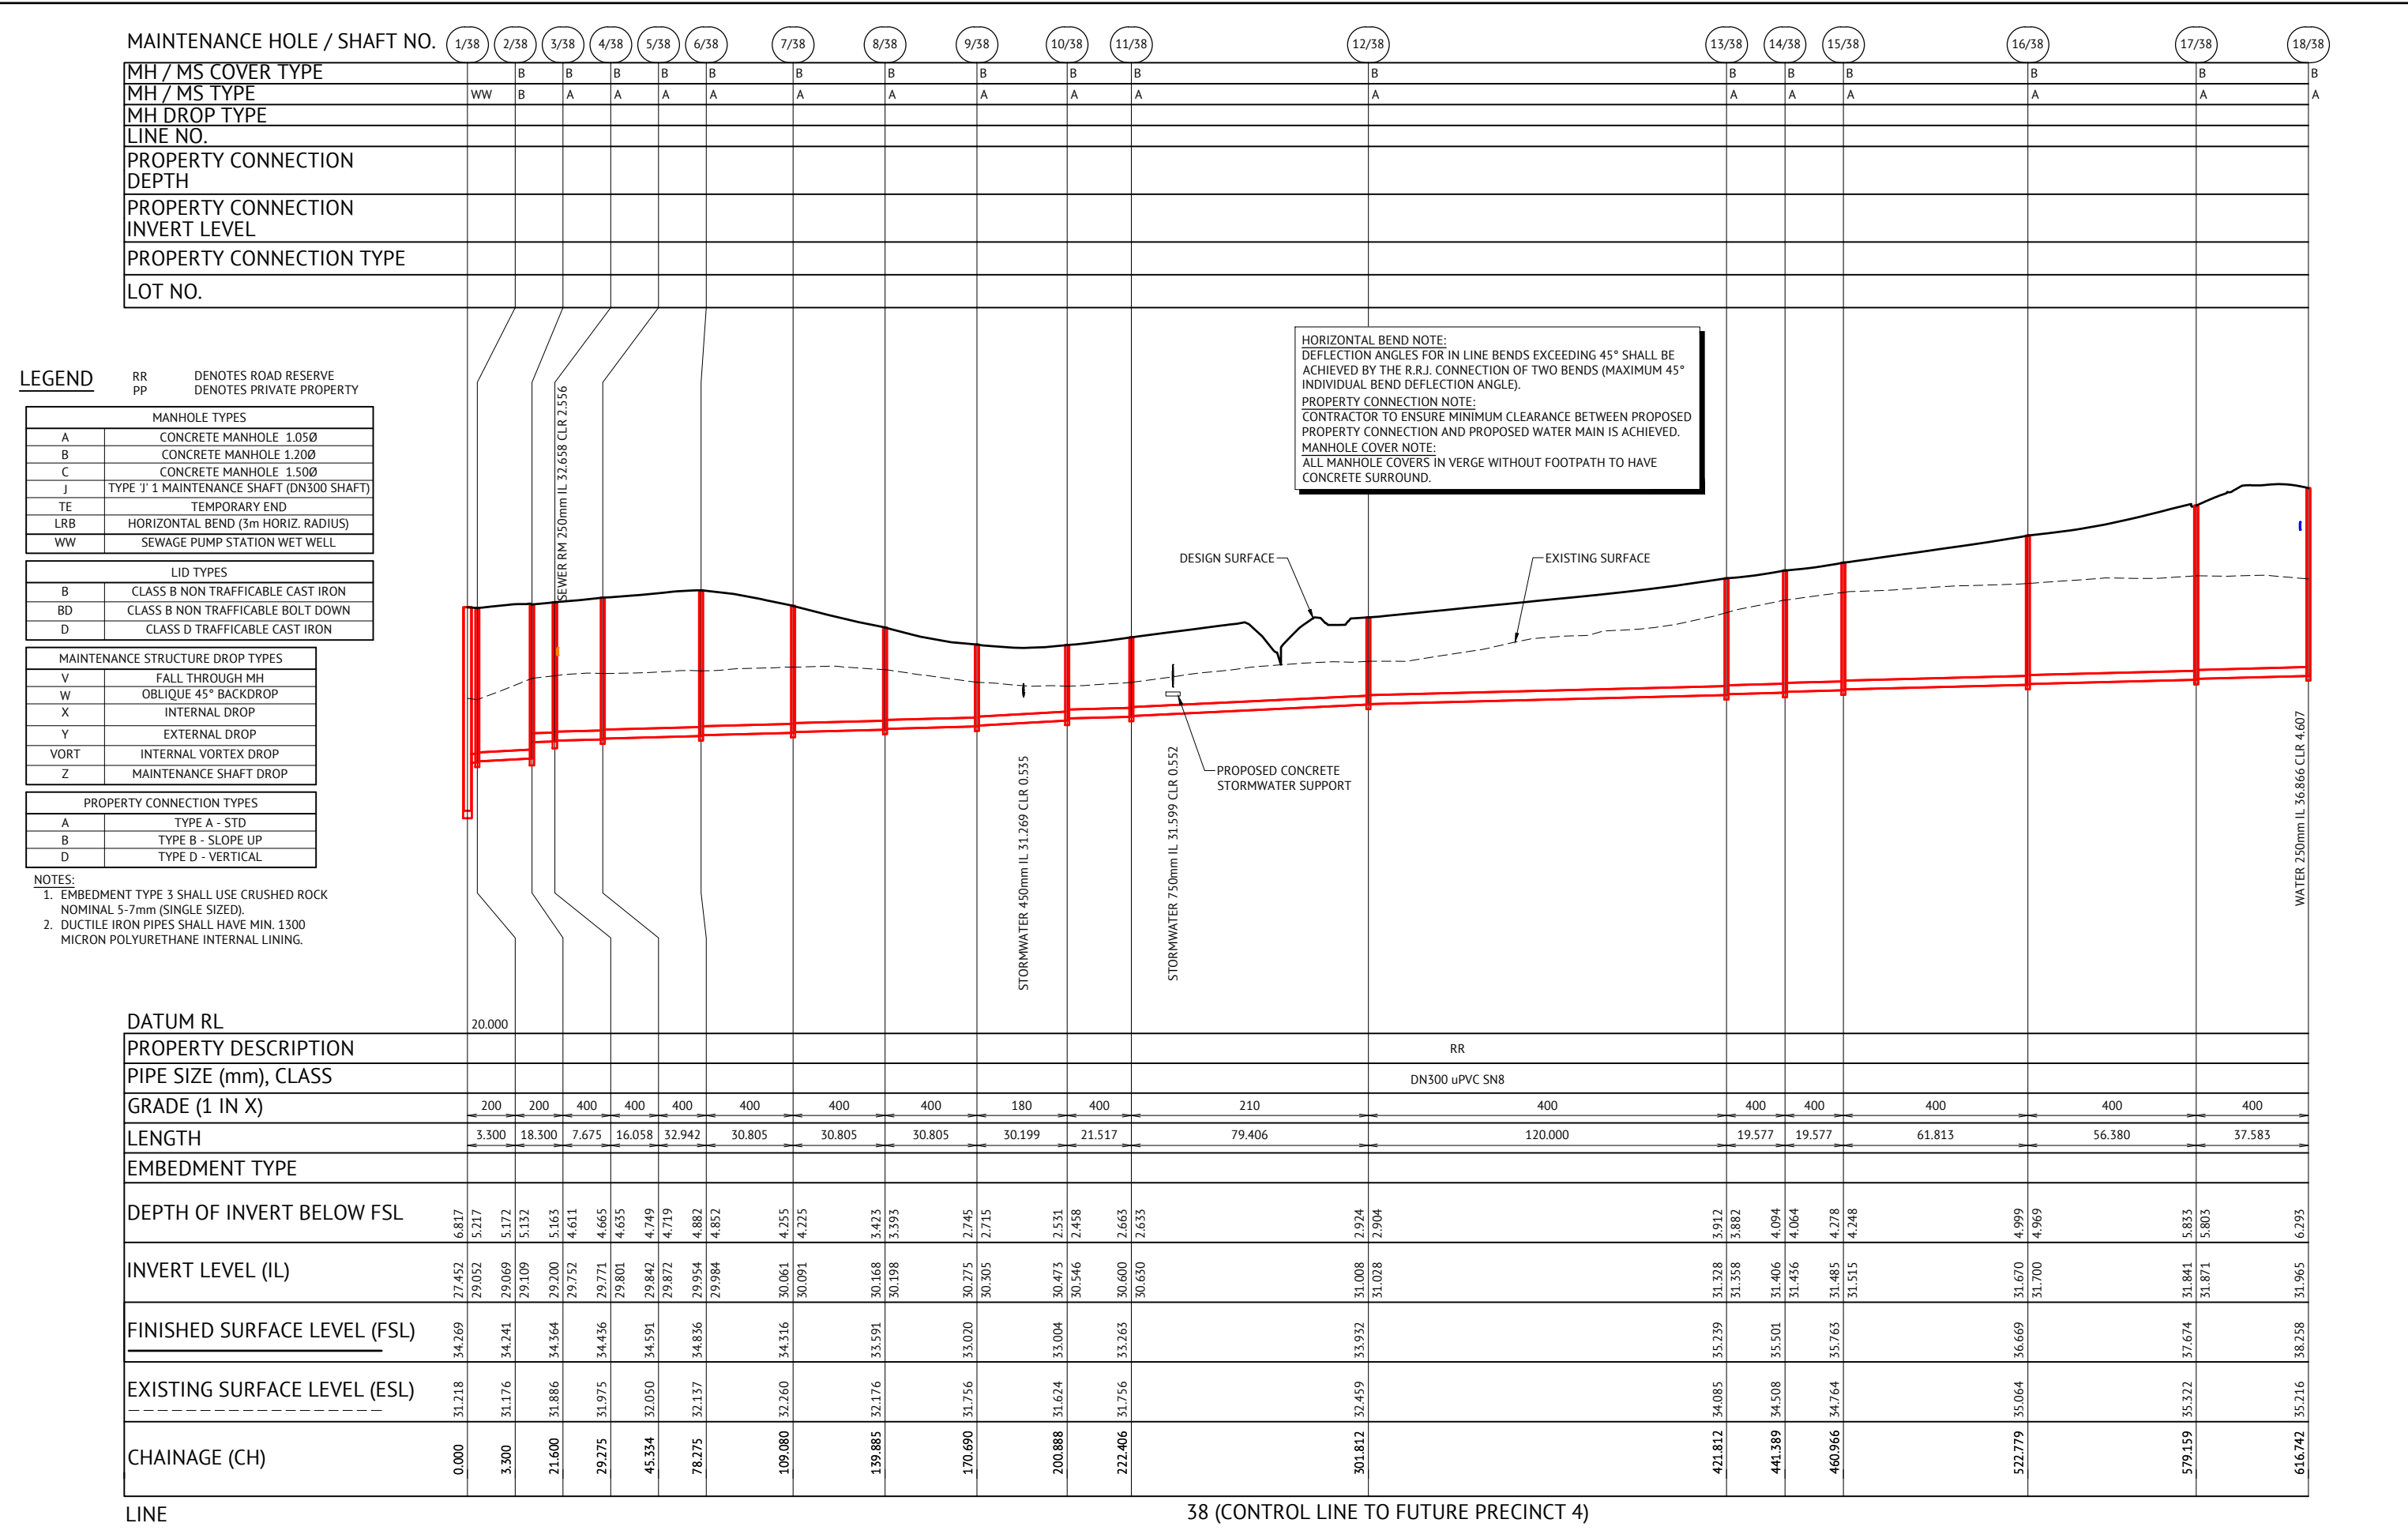

LEGEND

RR	DENOTES ROAD RESERVE
PP	DENOTES PRIVATE PROPERTY

LID TYPES	
B	CLASS B NON TRAFFICABLE CAST IRON
BD	CLASS B NON TRAFFICABLE BOLT DOWN
D	CLASS D TRAFFICABLE CAST IRON

PROPERTY CONNECTION TYPES	
A	TYPE A - STD
B	TYPE B - SLOPE UP
D	TYPE D - VERTICAL

NOTES:



1. EMBLEMENT TYPE 3 SHALL USE CRUSHED ROCK NOMINAL 5-7mm (SINGLE SIZED).
2. DUCTILE IRON PIPES SHALL HAVE MIN. 1300 MICRON POLYURETHANE INTERNAL LINING.


LINE 38 (CONTROL LINE TO FUTURE PRECINCT 4)

HORIZONTAL BEND NOTE:
DEFLECTION ANGLES FOR IN LINE BENDS EXCEEDING 45° SHALL BE ACHIEVED BY THE R.R.J. CONNECTION OF TWO BENDS (MAXIMUM 45° INDIVIDUAL BEND DEFLECTION ANGLE).

PROPERTY CONNECTION NOTE:
CONTRACTOR TO ENSURE MINIMUM CLEARANCE BETWEEN PROPOSED PROPERTY CONNECTION AND PROPOSED WATER MAIN IS ACHIEVED.

MANHOLE COVER NOTE:
ALL MANHOLE COVERS IN VERGE WITHOUT FOOTPATH TO HAVE CONCRETE SURROUND.

PRELIMINARY - NOT FOR CONSTRUCTION												DESIGNED KLYNT KIWANG		SCALE		CLIENT MIRVAC QLD PTY LTD				JOB CODE	
										BRISBANE OFFICE		CHECKED ANDREW LANGDON				PROJECT EVERLEIGH ROL13 SUBDIVISION DEVELOPMENT				MIR-1300	
										LEVEL 11, 300 ADELAIDE STREET		PROJECT MANAGER NICK SOMERVILLE				LOCATION TEVIOT ROAD, GREENBANK				SHEET NUMBER	
										BRISBANE, QLD 4000		PROJECT DIRECTOR				SHEET TITLE PRELIMINARY SEWER GRAVITY MAIN LONG SECTIONS - SHEET 2				REV	
										PH: (07) 3253 2222		PATRICK BRADY		RPEQ 7112						SKC67	
05/11/2024 2 UPDATED LONG SECTION TO MATCH SEWER MAIN UPDATES KK NS										WEB: www.premise.com.au										2	
21/05/2024 1 PRELIMINARY - NOT FOR CONSTRUCTION KK NS																					
DATE REV DESCRIPTION REVISIONS REC APP																					

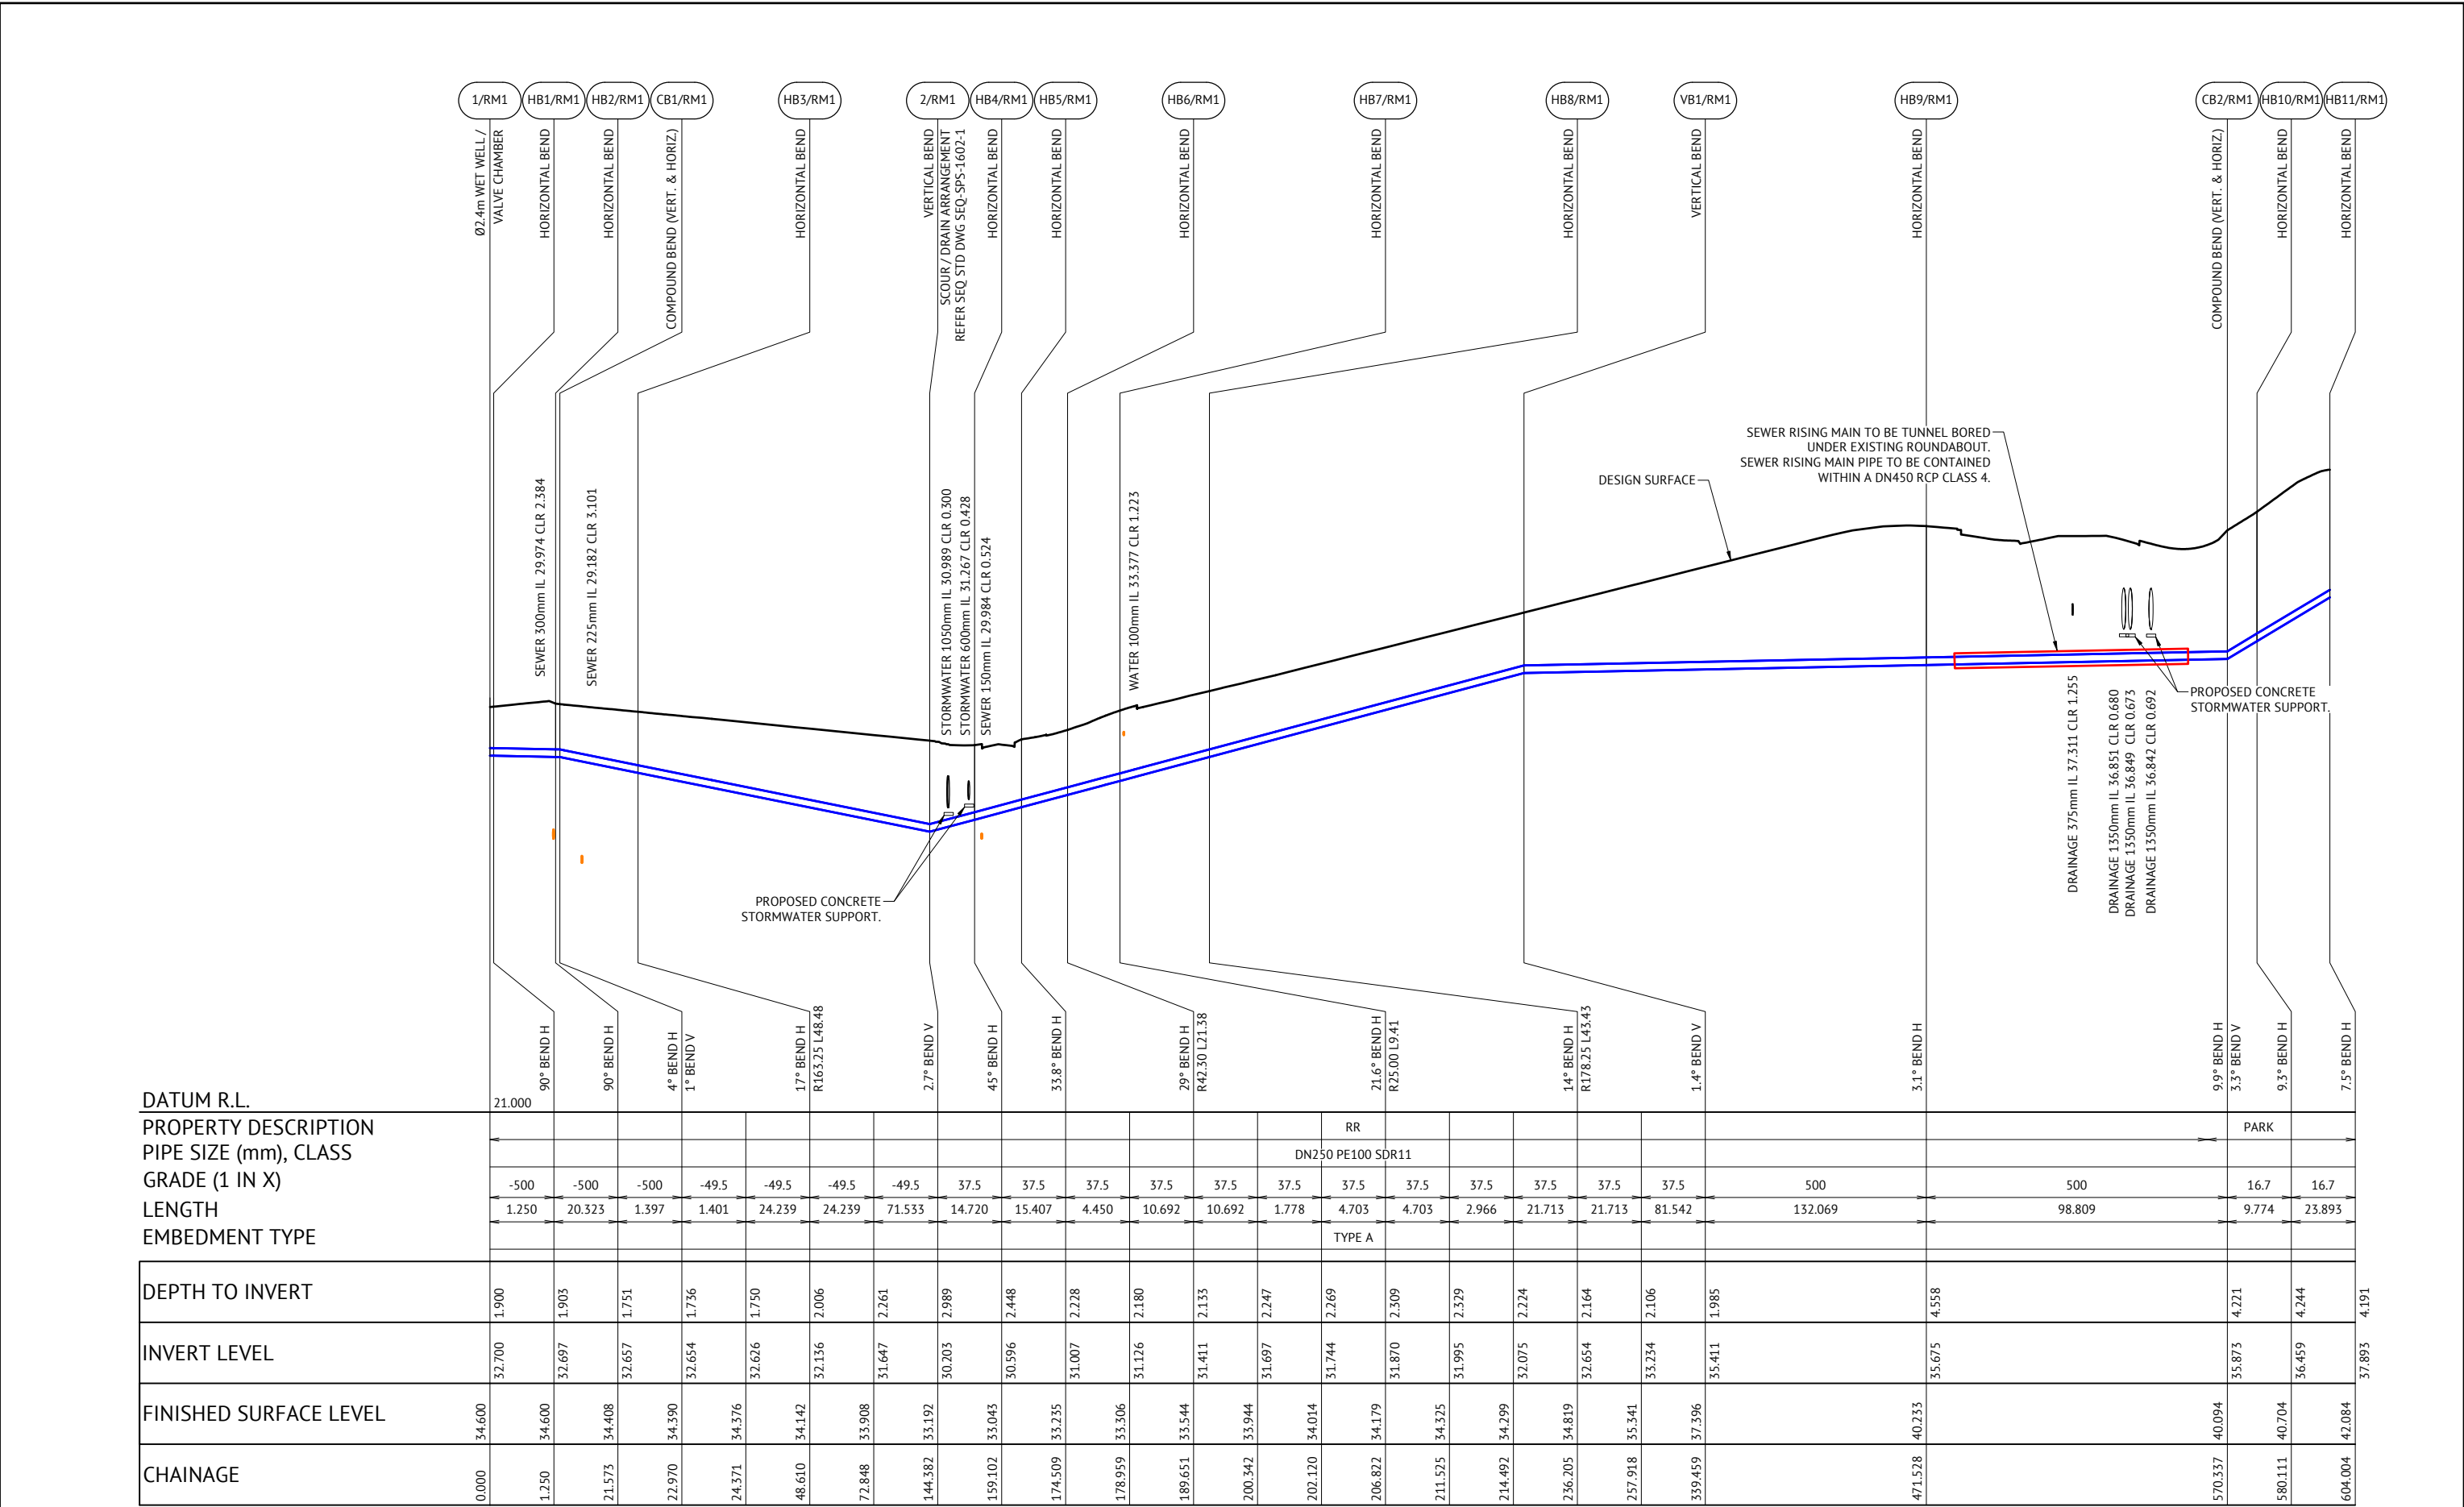

DATUM R.L.

PROPERTY DESCRIPTION

PIPE SIZE (mm), CLASS

GRADE (1 IN X)

LENGTH

EMBEDMENT TYPE

DEPTH TO INVERT

INVERT LEVEL

FINISHED SURFACE LEVEL

CHAINAGE

PRELIMINARY - NOT FOR CONSTRUCTION

21/05/2024	1	PRELIMINARY - NOT FOR CONSTRUCTION	KK	NS
DATE	REV	DESCRIPTION	REC	APP
REVISIONS				




BRISBANE OFFICE
LEVEL 11, 300 ADELAIDE STREET
BRISBANE, QLD 4000
PH: (07) 3253 2222
WEB: www.premise.com.au

DESIGNED
KLYNT KIWANG
CHECKED
ANDREW LANGDON
PROJECT MANAGER
NICK SOMERVILLE
PROJECT DIRECTOR
PATRICK BRADY
RPEQ 7112

SCALE
HORIZONTAL 1:1000 (A1)
VERTICAL 1:100 (A1)
ORIGINAL SHEET SIZE A1

CLIENT
MIRVAC QLD PTY LTD
PROJECT
EVERLEIGH ROL13 SUBDIVISION DEVELOPMENT
LOCATION
TEVIOT ROAD, GREENBANK
SHEET TITLE
PRELIMINARY SEWER RISING MAIN LONG SECTIONS - SHEET 1


JOB CODE
MIR-1300
SHEET NUMBER
SKC68
REV
1

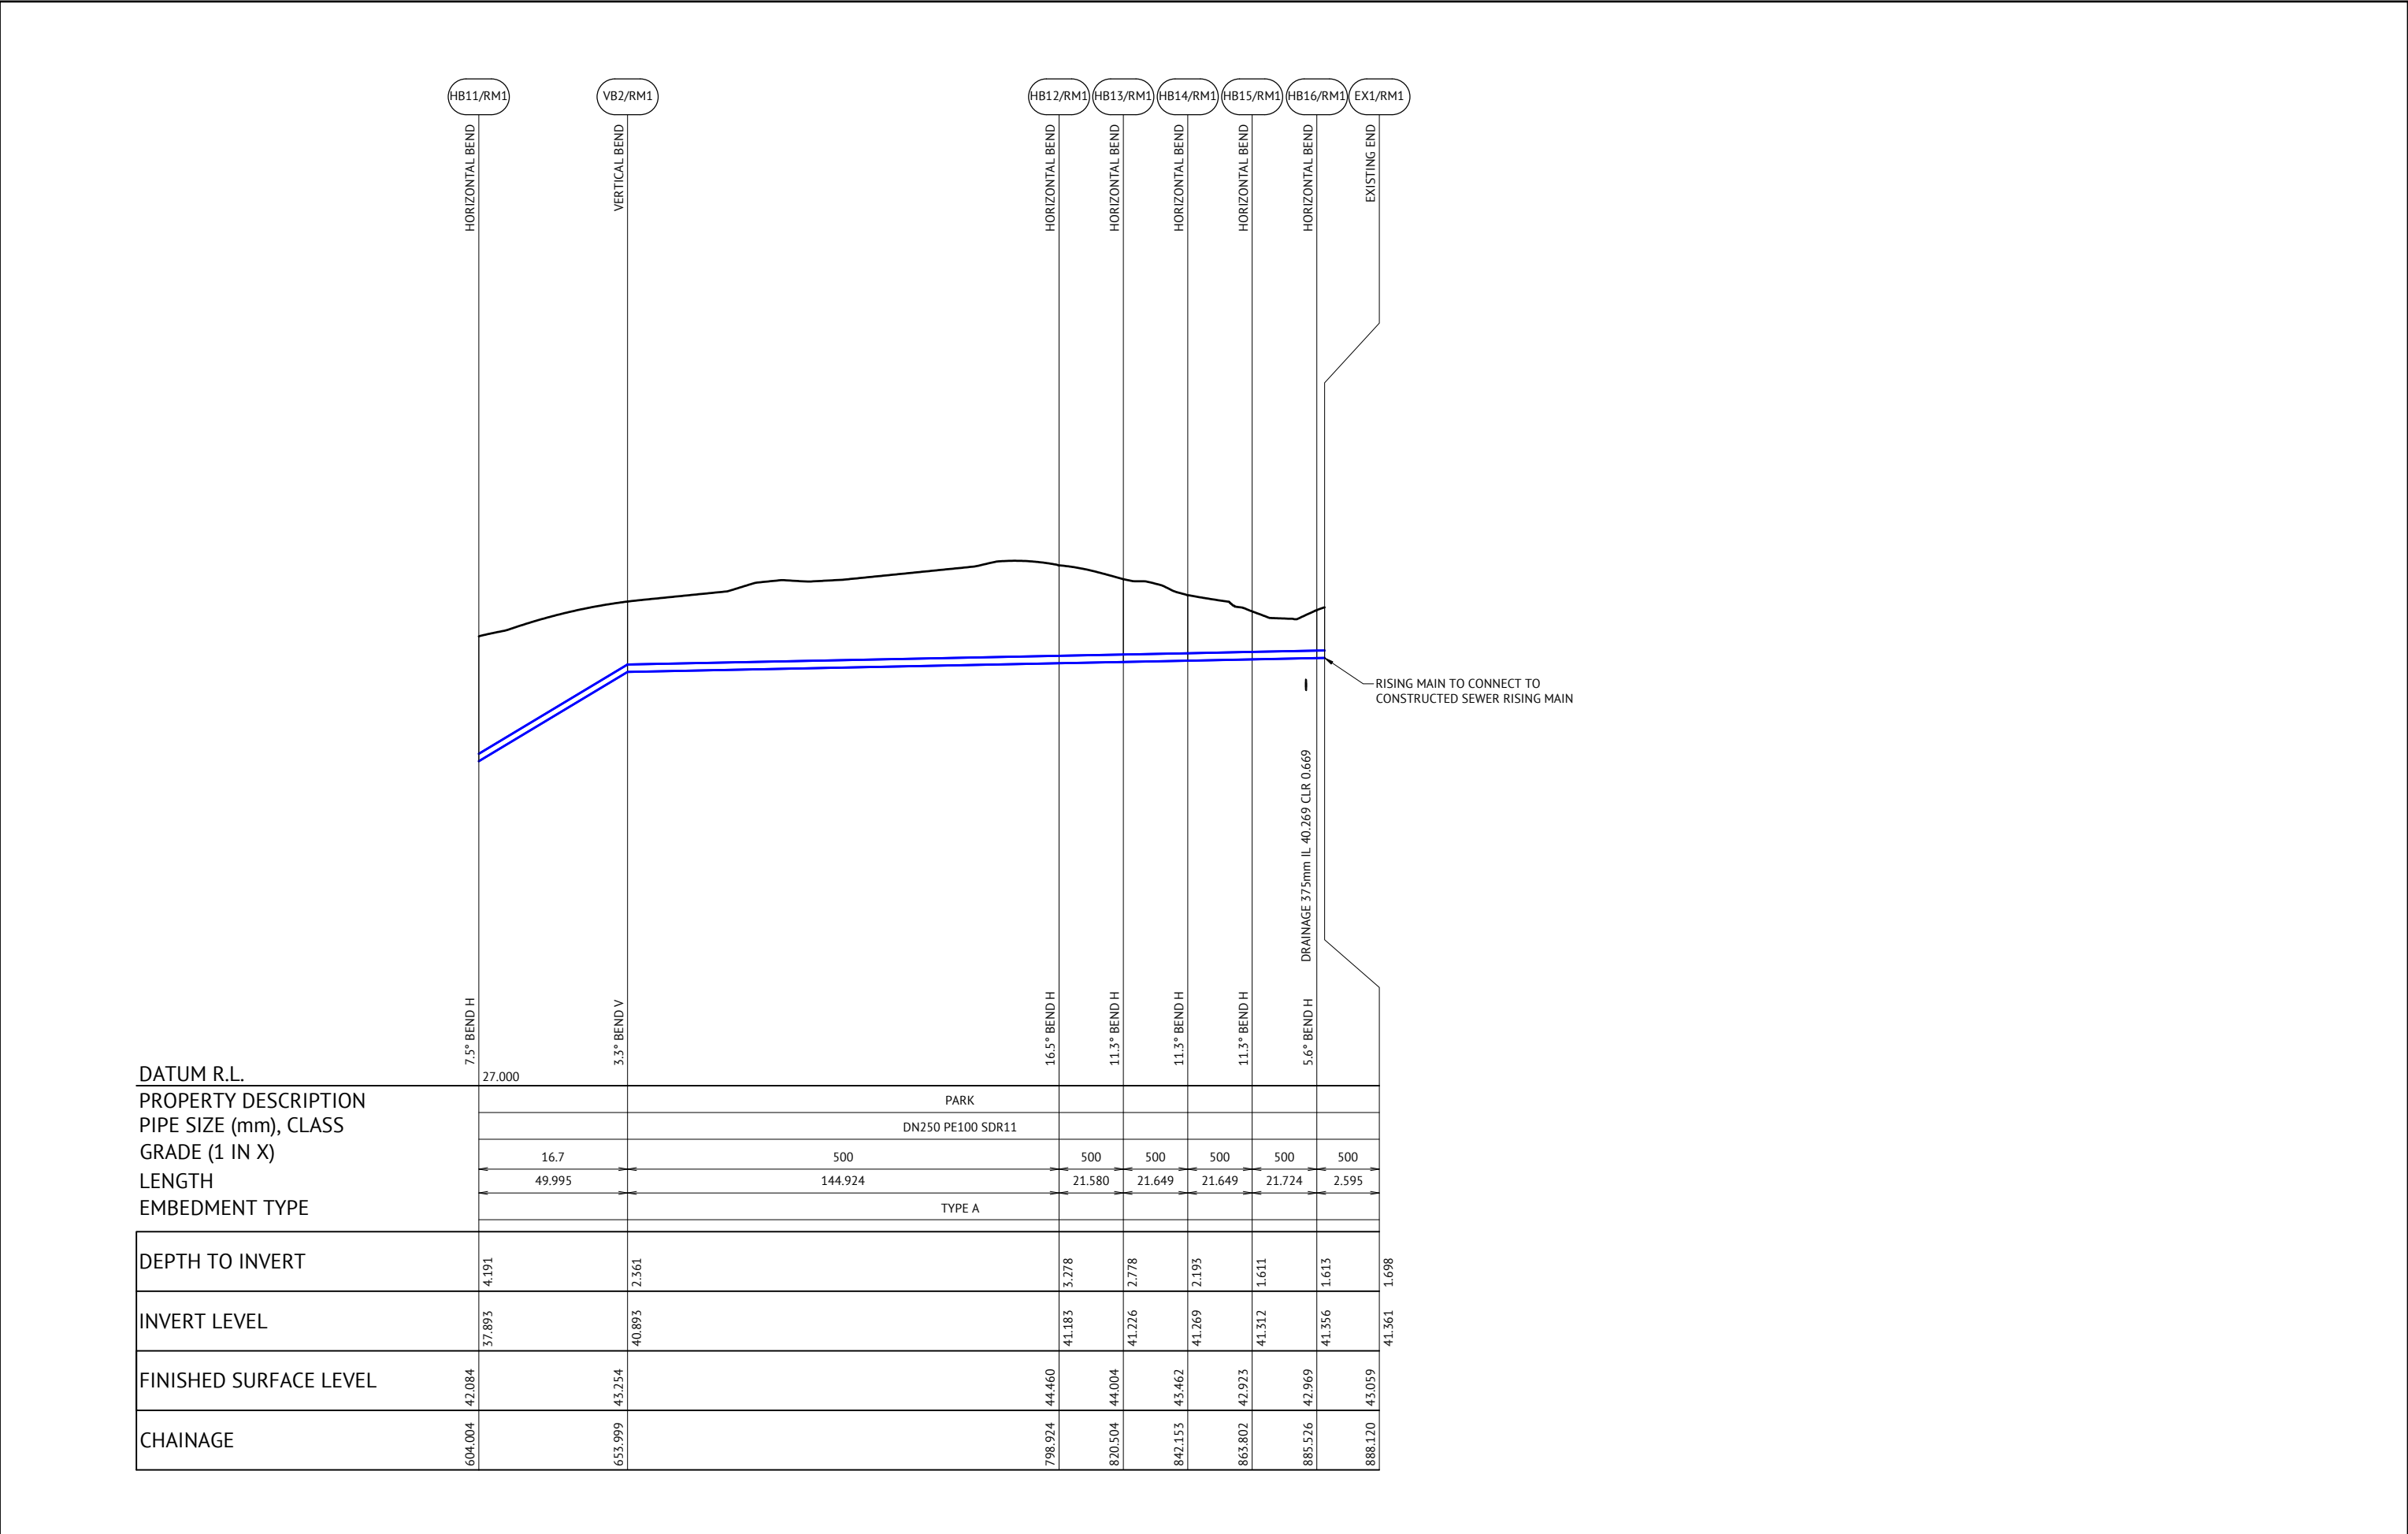

APPENDIX H

PRELIMINARY WATER RETICULATION PLANS



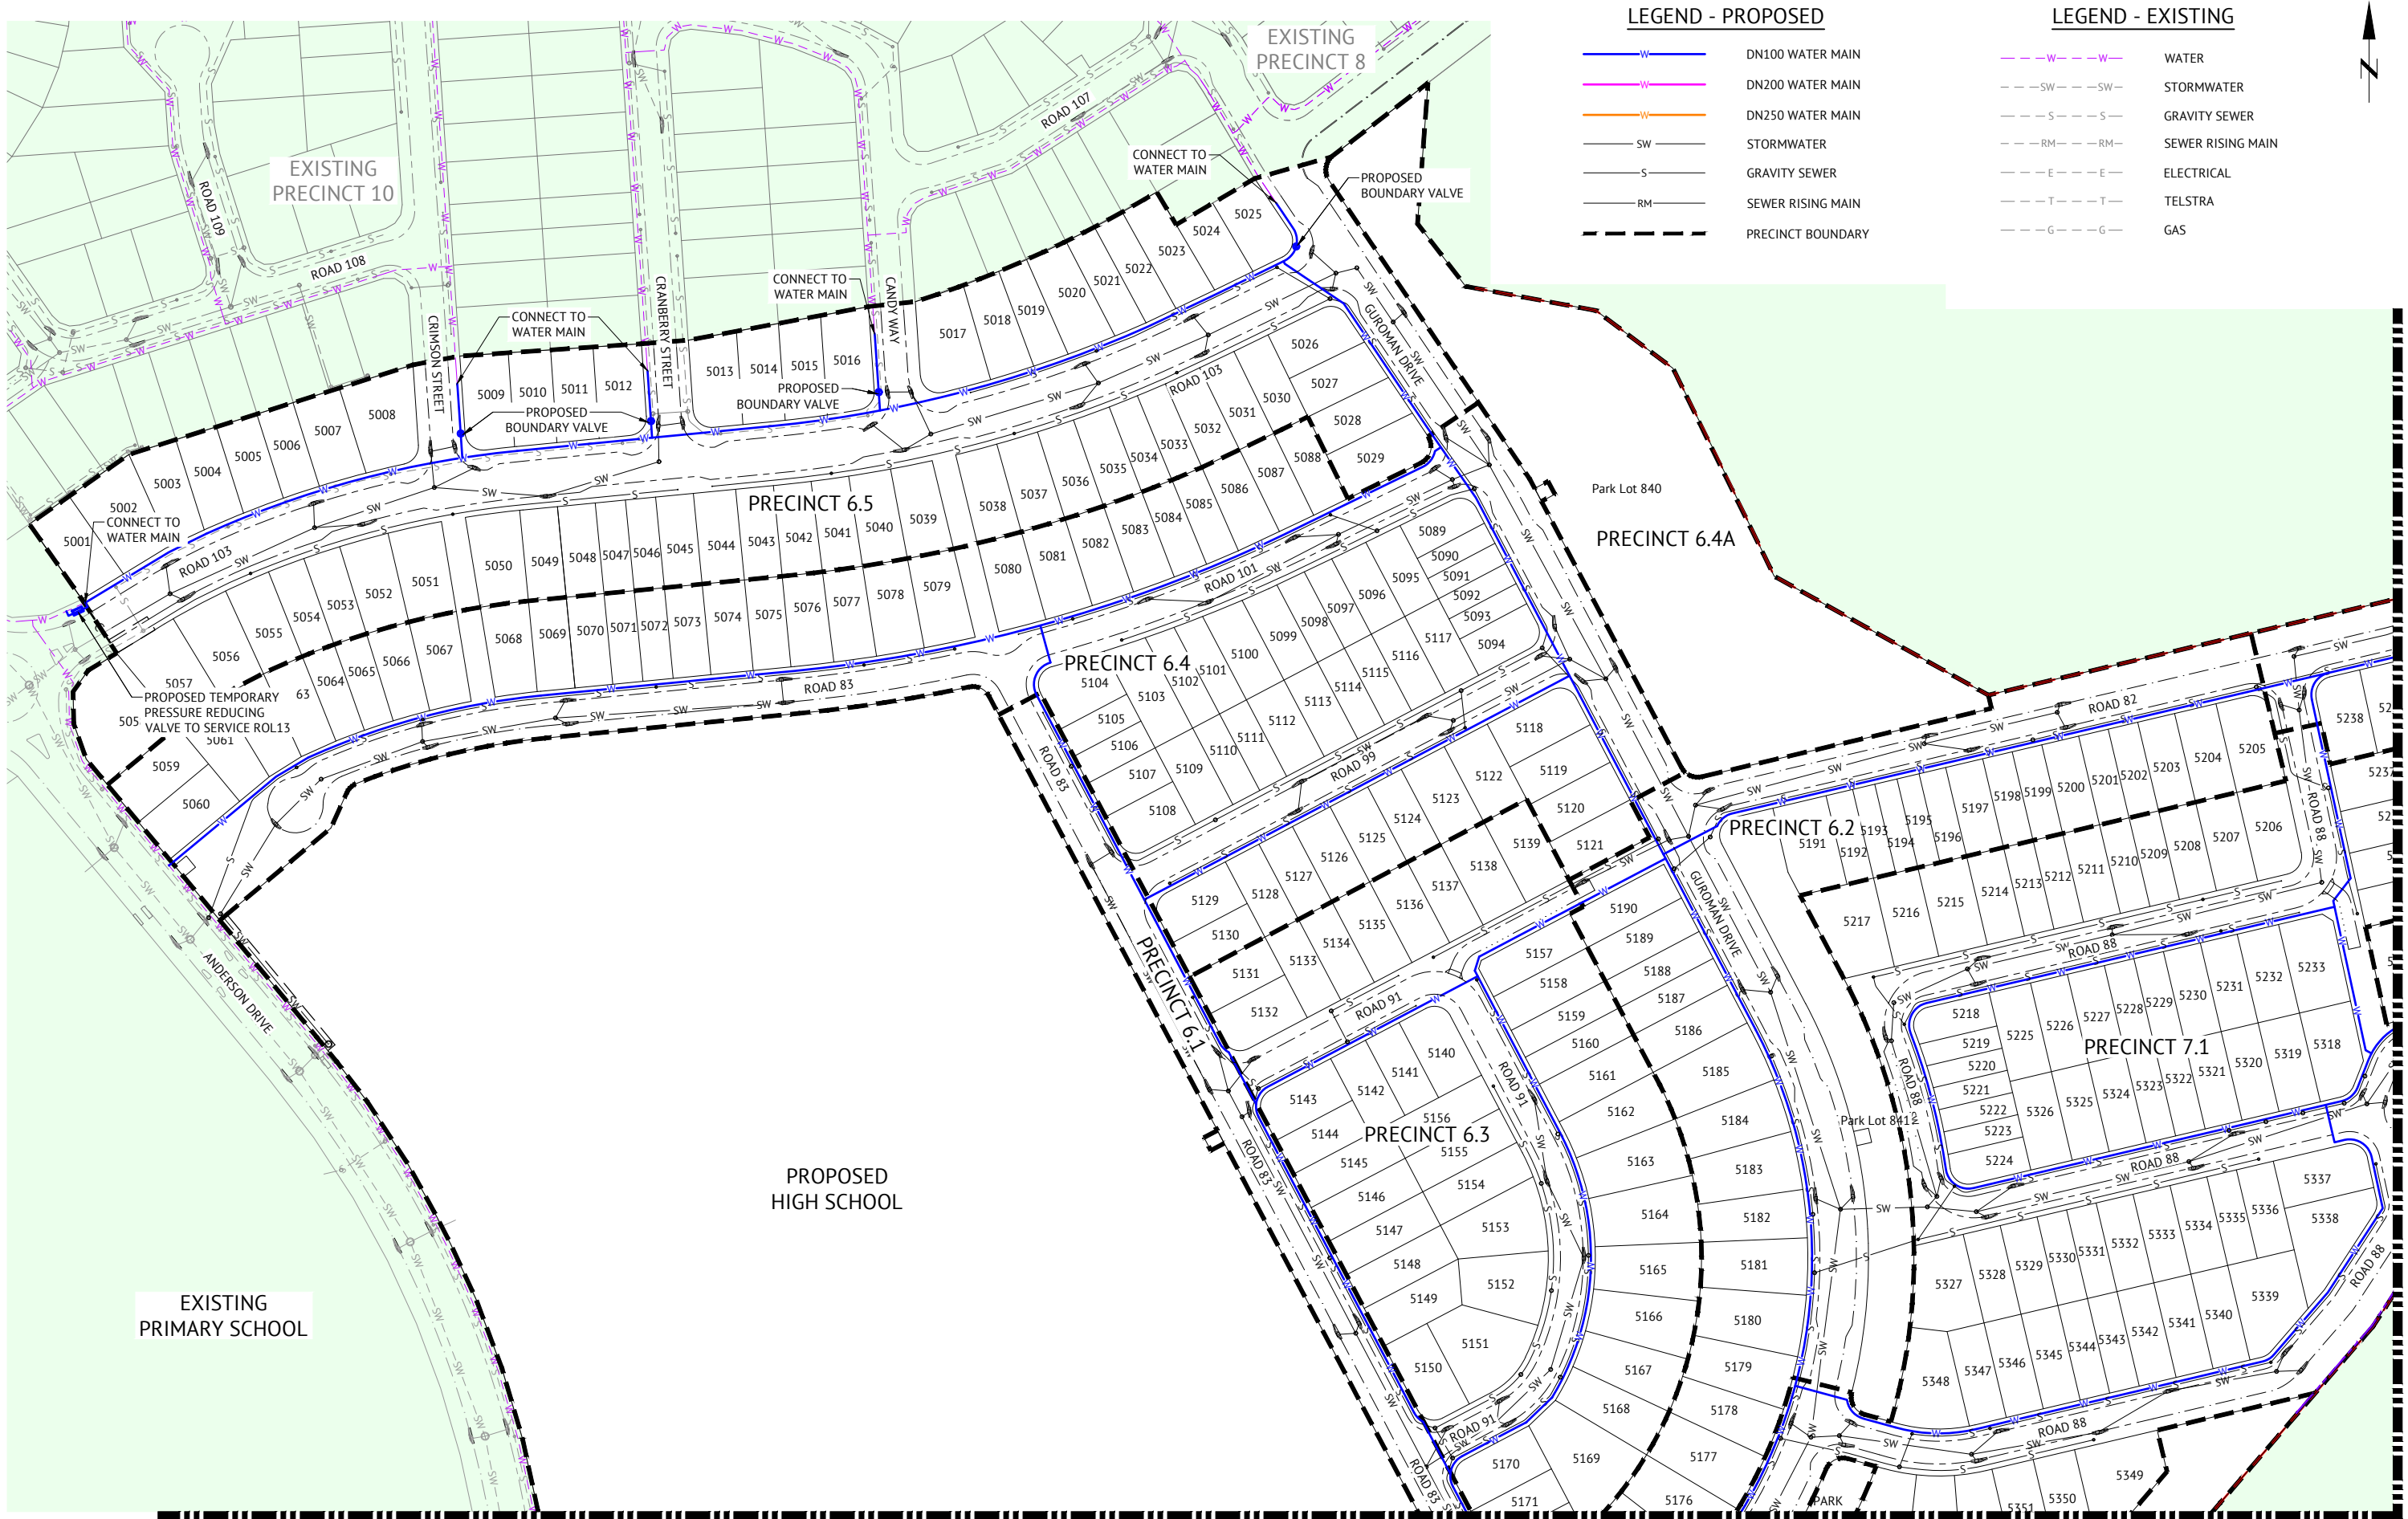


PRELIMINARY - NOT FOR CONSTRUCTION

DATE	REV	DESCRIPTION	REVISIONS
05/11/2024	3	UPDATED LOT LAYOUT	KK NS
14/05/2024	2	UPDATED TO PRECINCT NUMBERS AND LAYOUT	KK NS
29/09/2023	1	PRELIMINARY - NOT FOR CONSTRUCTION	KK NS
DATE	REV	DESCRIPTION	REC APP



BRISBANE OFFICE
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WEB: www.premise.com.au

DESIGNED
KLYNT KIWANG
CHECKED
ANDREW LANGDON
PROJECT MANAGER
NICK SOMERVILLE
ENGINEERING CERTIFICATION
PATRICK BRADY RPEQ 7112

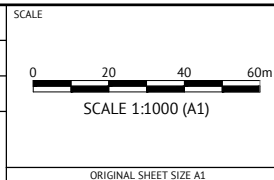

CLIENT

MIRVAC QLD PTY LTD

PROJECT

EVERLEIGH ROL13 SUBDIVISION DEVELOPMENT

LOCATION

TEVIOT ROAD, GREENBANK

SHEET TITLE

PRELIMINARY WATER LAYOUT PLAN - SHEET 1

JOB CODE


MIR-1300

SHEET NUMBER

SKC56

REV

3

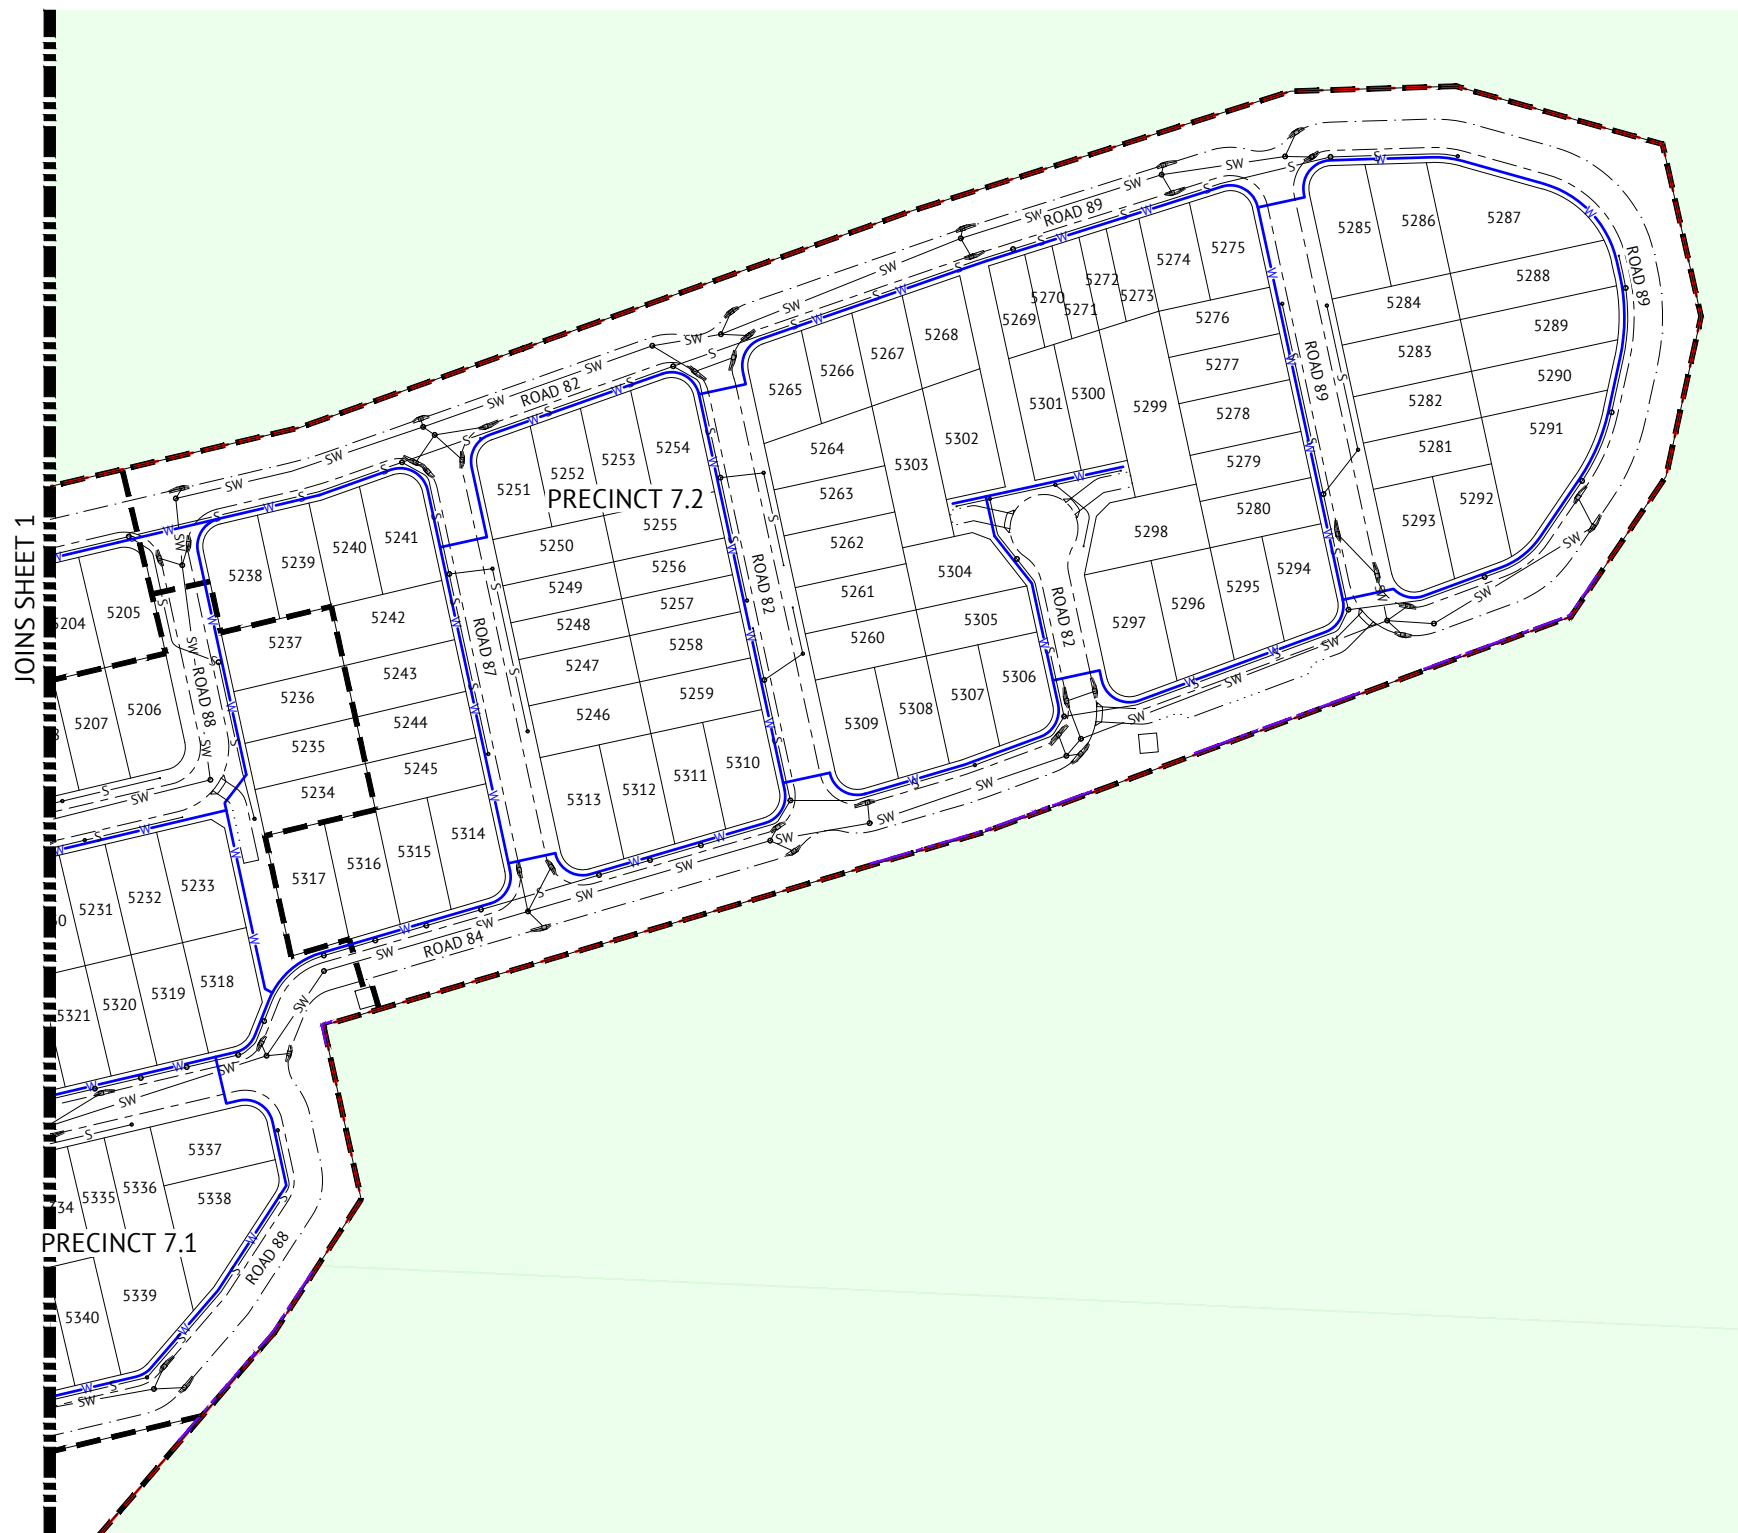

LEGEND - PROPOSED

- W— DN100 WATER MAIN
- W— DN200 WATER MAIN
- W— DN250 WATER MAIN
- SW— STORMWATER
- S— GRAVITY SEWER
- RM— SEWER RISING MAIN
- — — — — PRECINCT BOUNDARY

LEGEND - EXISTING

- W— WATER
- SW— STORMWATER
- S— GRAVITY SEWER
- RM— SEWER RISING MAIN
- E— ELECTRICAL
- T— TELSTRA
- G— GAS

PRELIMINARY - NOT FOR CONSTRUCTION

DATE	REV	DESCRIPTION	REC	APP
05/11/2024	3	UPDATED WATER AS PER CHANGES TO LOT LAYOUT	KK	NS
14/03/2024	2	UPDATED TO PRECINCT NUMBERS AND LAYOUT	KK	NS
29/09/2023	1	PRELIMINARY - NOT FOR CONSTRUCTION	KK	NS




BRISBANE OFFICE
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WEB: www.premise.com.au

DESIGNED
KLYNT KIWANG
CHECKED
ANDREW LANGDON
PROJECT MANAGER
NICK SOMERVILLE
ENGINEERING CERTIFICATION
PATRICK BRADY RPEQ 7112

SCALE
0 20 40 60m
SCALE 1:1000 (A1)
ORIGINAL SHEET SIZE A1

CLIENT
MIRVAC QLD PTY LTD
PROJECT
EVERLEIGH ROL13 SUBDIVISION DEVELOPMENT
LOCATION
TEVIOT ROAD, GREENBANK
SHEET TITLE
PRELIMINARY WATER LAYOUT PLAN - SHEET 2

JOB CODE
MIR-1300
SHEET NUMBER
SKC57
REV
3

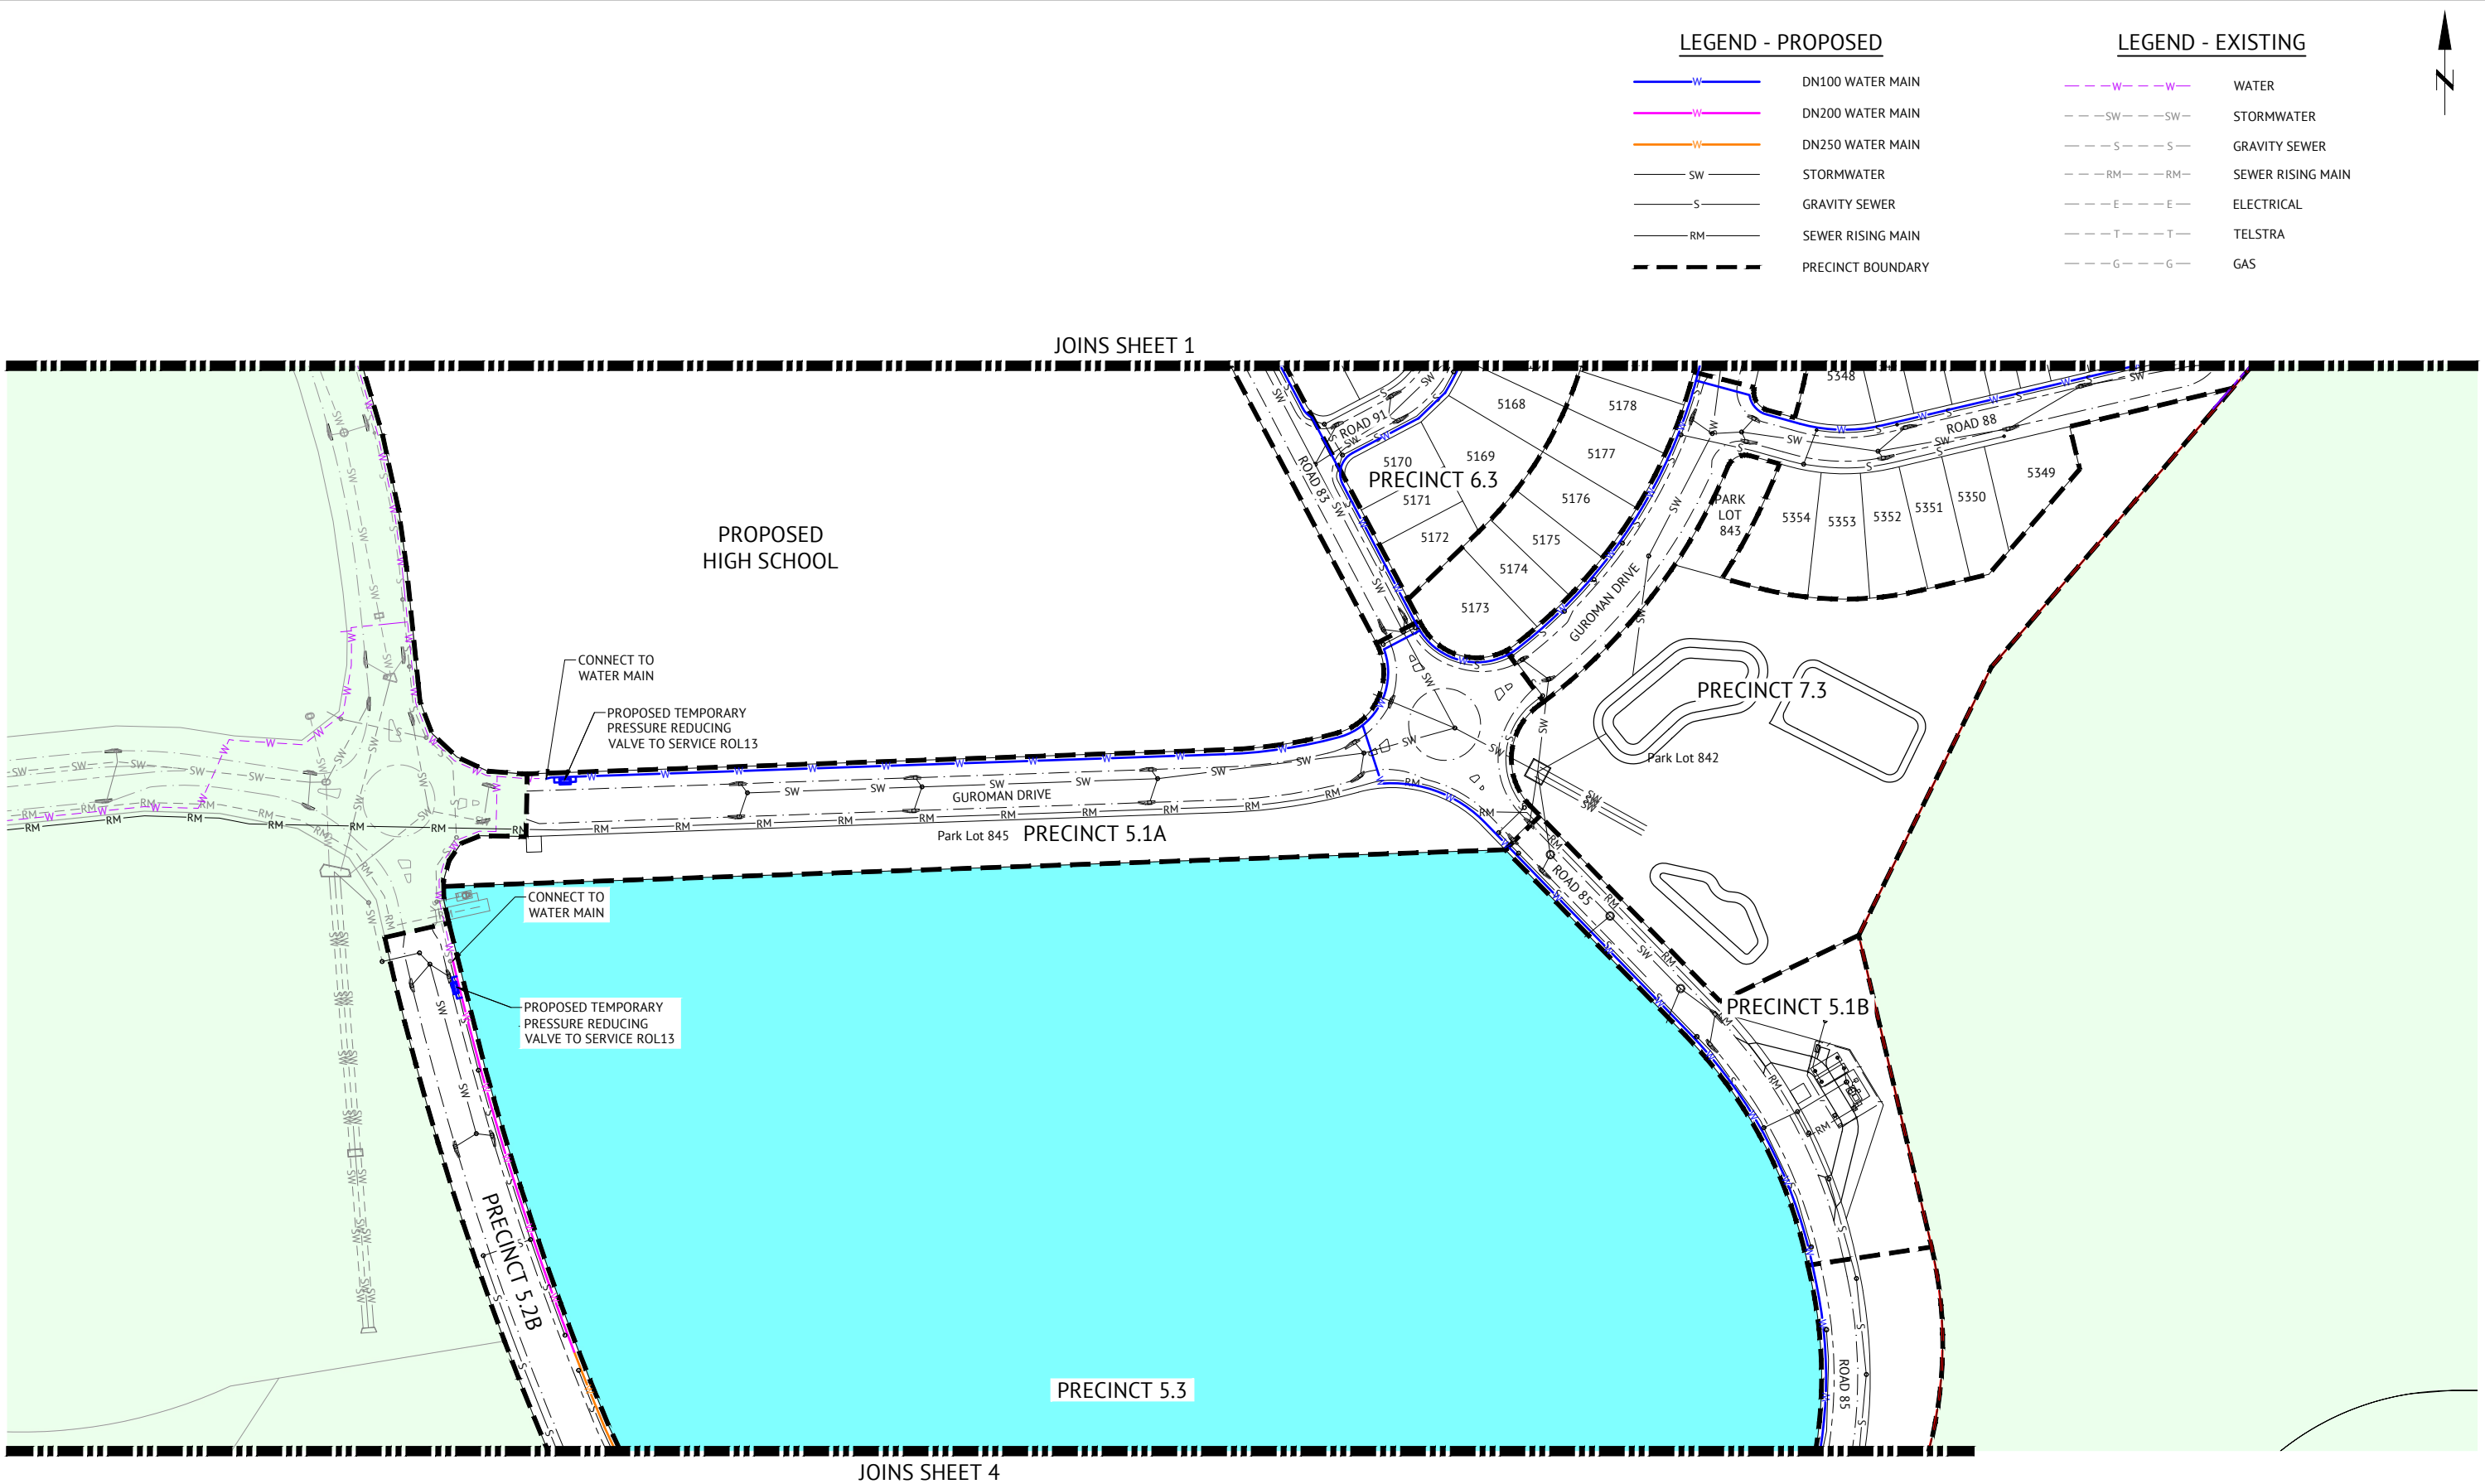

LEGEND - PROPOSED

- W— DN100 WATER MAIN
- W— DN200 WATER MAIN
- W— DN250 WATER MAIN
- SW— STORMWATER
- S— GRAVITY SEWER
- RM— SEWER RISING MAIN
- PRECINCT BOUNDARY

LEGEND - EXISTING

- - -W- - -W- WATER
- - -SW- - -SW- STORMWATER
- - -S- - -S- GRAVITY SEWER
- - -RM- - -RM- SEWER RISING MAIN
- - -E- - -E- ELECTRICAL
- - -T- - -T- TELSTRA
- - -G- - -G- GAS




PRELIMINARY - NOT FOR CONSTRUCTION

DATE	REV	DESCRIPTION	REC	APP
22/05/2024	3	UPDATED WATER AS PER CHANGES TO LOT LAYOUT	KK	NS
14/05/2024	2	UPDATED TO PRECINCT NUMBERS AND LAYOUT	KK	NS
29/09/2023	1	PRELIMINARY - NOT FOR CONSTRUCTION	KK	NS




BRISBANE OFFICE
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BRISBANE, QLD 4000
PH: (07) 3253 2222
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DESIGNED
KLYNT KIWANG
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ANDREW LANGDON
PROJECT MANAGER
NICK SOMERVILLE
ENGINEERING CERTIFICATION
PATRICK BRADY RPEQ 7112

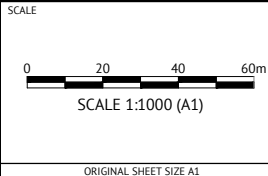

CLIENT
MIRVAC QLD PTY LTD
PROJECT
EVERLEIGH ROL13 SUBDIVISION DEVELOPMENT
LOCATION
TEVIOT ROAD, GREENBANK
SHEET TITLE
PRELIMINARY WATER LAYOUT PLAN - SHEET 3

JOB CODE
MIR-1300
SHEET NUMBER
SKC58
REV
3

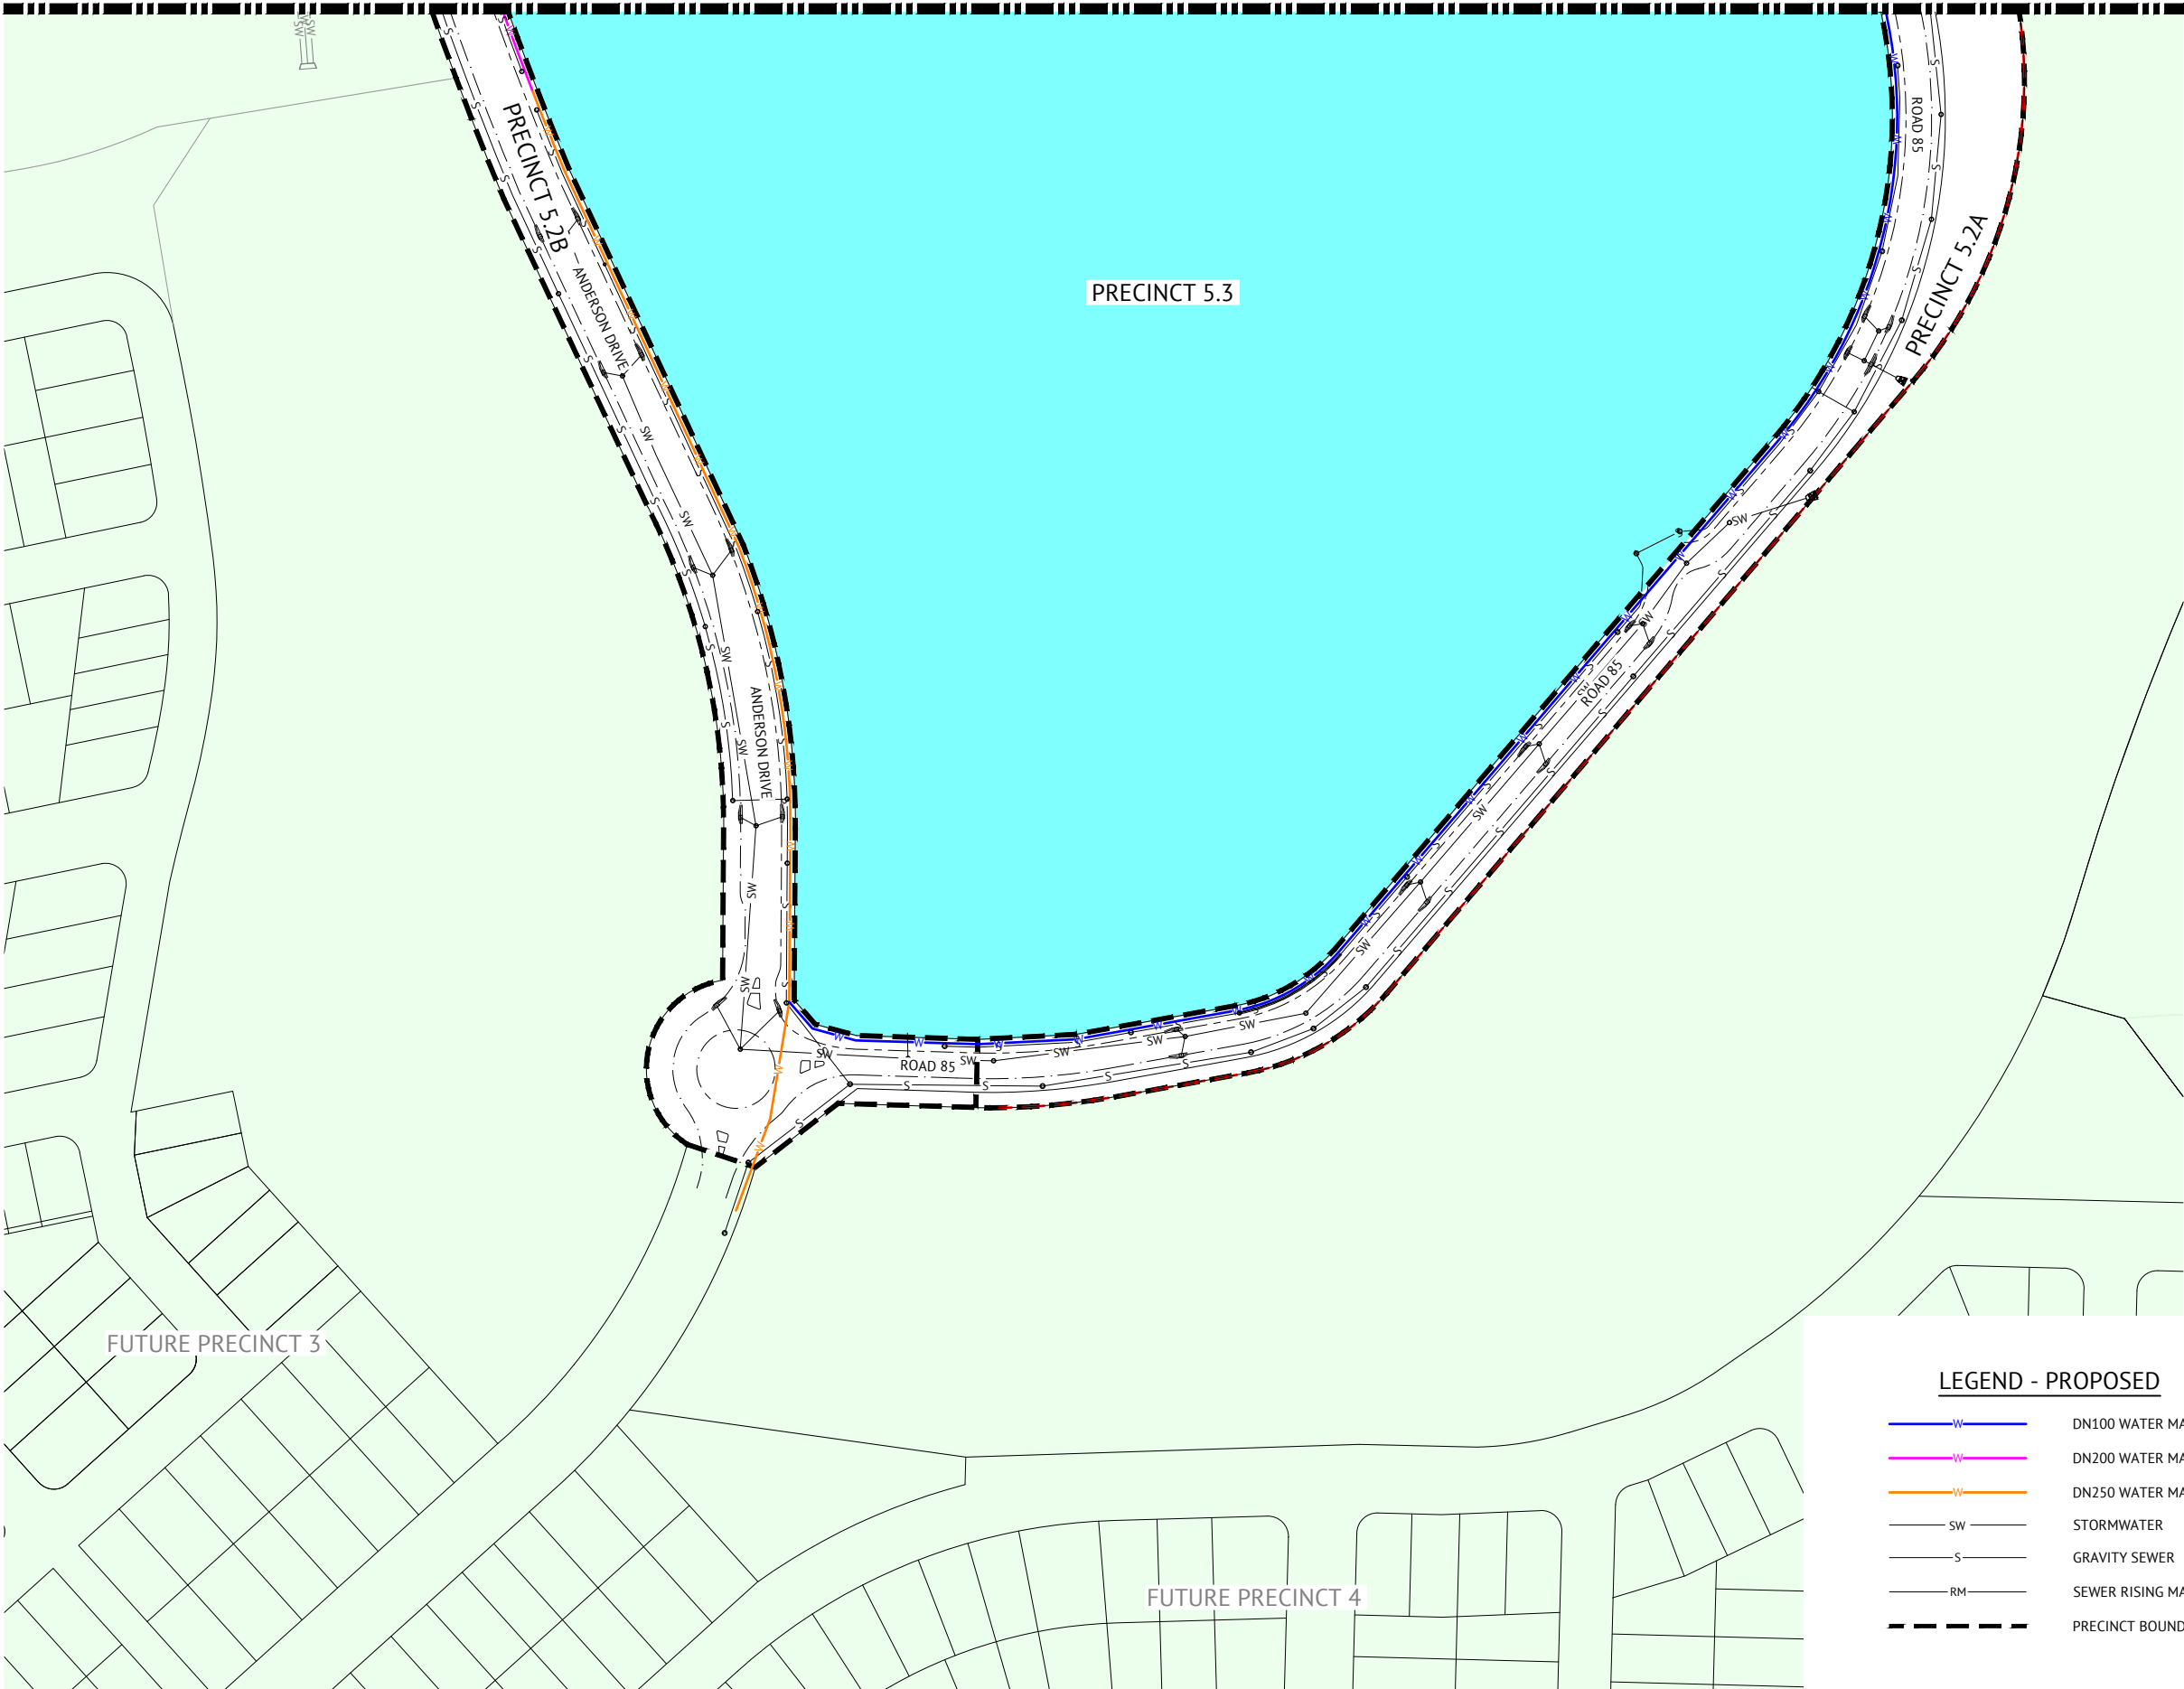

LEGEND - PROPOSED

- DN100 WATER MAIN
- DN200 WATER MAIN
- DN250 WATER MAIN
- STORMWATER
- GRAVITY SEWER
- SEWER RISING MAIN
- PRECINCT BOUNDARY

LEGEND - EXISTING

- WATER
- STORMWATER
- GRAVITY SEWER
- SEWER RISING MAIN
- ELECTRICAL
- TELSTRA
- GAS

