# 10 CAMPBELL STREET, BOWEN HILLS BUILD TO RENT

CFMEU

#### CLIENT



PREPARED FOR

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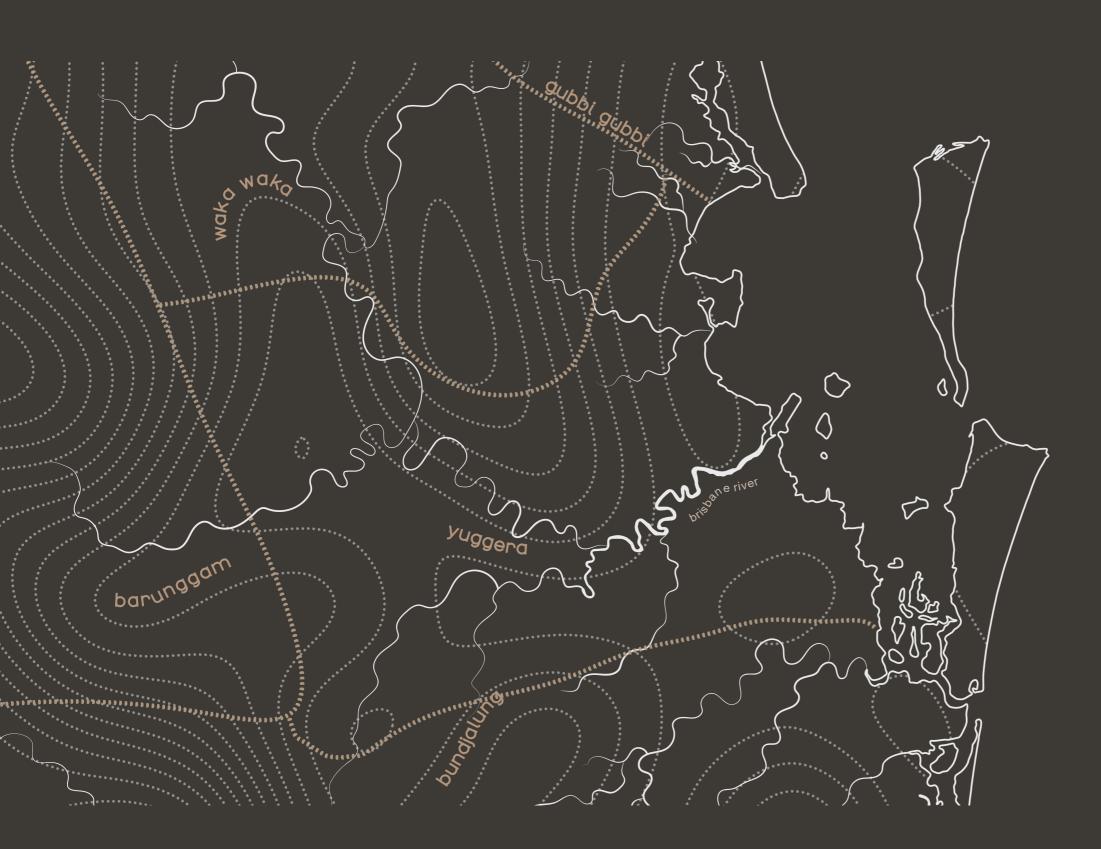
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# ACKNOWLEDGEMENT OF COUNTRY



nettletontribe acknowledges the important contribution that Aboriginal and Torres Strait Islander people make in creating a strong and vibrant Australian society. We pay our respects to the elders, past, present and emerging and acknowledge, in each of our offices, the Traditional Owners on whose land we stand.

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# 01 Summary and Context

#### 01 SITE CONTEXT

#### **DEVELOPMENT SUMMARY**

Property Address: 10-16 Campbell St, Bowen Hills, 4006

Lot Plan: Lot 1 on RP144614 Lot 3-5 on RP10074

Zone: EC Emerging Community

Site Area: 2081.62 m<sup>2</sup>

Site Cover Tower: 1041.43 m² (50.03%)

Site Cover Podium: 1984.97 m<sup>2</sup> (95.36%)

Building Height: 30 Storeys (297 Units)

Landscaped area: 1214.27 m<sup>2</sup> (58.33%)

Proposed Carparking:

Resident Car Parks: 96 Car Parking Bays

Visitor Car Parks: 30 + 1 Accessible Car Parking Bays

Total car parks: 127

Motorcycle: 17 Resident Motorcycle Bays

Proposed Bicycle Parking

Resident Bicycle: 201 Bays

Visitor Bicycle = 41 Bays internal + 10 Bays external

Total Bycycles: 252

Service Vehicle: Medium Rigid Vehicle (MRV)

|                | 2 Bed                    | 1 Bed + MPR              | 1 Bed          | Studio | Total  | GFA              | Landscaped Area |               |
|----------------|--------------------------|--------------------------|----------------|--------|--------|------------------|-----------------|---------------|
| LMR            |                          | Roof Terrace and         | BTR Communal a | and    |        |                  |                 |               |
| Roof Deck      |                          | Services                 |                |        |        | 100.32           | 226.12          | sqm           |
| Lower Roof     |                          | BTR Communal a           | and Services   |        |        | 343.15           | 86.59           | sqm           |
| Level 26       | 4                        | 5                        | 1              | 3      | 13     | 852.83           | 11.18           | sqm           |
| Level 25       | 4                        | 5                        | 1              | 3      | 13     | 852.83           | 22.62           | sqm           |
| Level 24       | 4                        | 4                        | 2              | 3      | 13     | 846.04           | 11.18           | sqm           |
| Level 23       | 4                        | 5                        | 1              | 3      | 13     | 852.83           | 22.62           | sqm           |
| Level 22       | 4                        | 5                        | 1              | 3      | 13     | 852.83           | 11.18           | sqm           |
| Level 21       | 4                        | 5                        | 1              | 3      | 13     | 852.83           | 22.62           | sqm           |
| Level 20       | 4                        | 4                        | 2              | 3      | 13     | 846.04           | 11.18           | sqm           |
| Level 19       | 4                        | 5                        | 1              | 3      | 13     | 852.83           | 22.62           | sqm           |
| Level 18       | 4                        | 5                        | 1              | 3      | 13     | 852.83           | 11.18           | sqm           |
| Level 17       | 4                        | 5                        | 1              | 3      | 13     | 852.83           | 22.62           | sqm           |
| Level 16       | 4                        | 4                        | 2              | 3      | 13     | 846.04           | 11.18           | sqm           |
| Level 15       | 4                        | 5                        | 1              | 3      | 13     | 852.83           | 22.62           | sqm           |
| Level 14       | 4                        | 5                        | 1              | 3      | 13     | 852.83           | 11.18           | sqm           |
| Level 13       | 4                        | 5                        | 1              | 3      | 13     | 852.83           | 22.62           | sqm           |
| Level 12       | 4                        | 4                        | 2              | 3      | 13     | 846.04           | 11.18           | sqm           |
| Level 11       | 4                        | 5                        | 1              | 3      | 13     | 852.83           | 22.62           | sqm           |
| Level 10       | 4                        | 5                        | 1              | 3      | 13     | 852.83           | 11.18           | sqm           |
| Level 9        | 4                        | 5                        | 1              | 3      | 13     | 852.83           | 22.62           | sqm           |
| Level 8        | 4                        | 4                        | 2              | 3      | 13     | 846.04           | 11.18           | sqm           |
| Level 7        | 4                        | 5                        | 1              | 3      | 13     | 852.83           | 22.62           | sqm           |
| Level 6        | 4                        | 5                        | 1              | 3      | 13     | 852.83           | 11.18           | sqm           |
| Level 5        | 4                        | 5                        | 1              | 3      | 13     | 852.83           | 22.62           | sqm           |
| Podium Deck    | 3                        | 4                        | 1              | 3      | 11     | 865.73           | 364.45          | sqm           |
| Podium Level 3 |                          | Carpark and              |                | 159.22 | 36.15  | sqm              |                 |               |
| Podium Level 2 |                          | Carpark and BTR Communal |                |        |        | 238.15           | 33.98           | sqm           |
| Podium Level 1 | Carpark and BTR Communal |                          |                |        |        | 248.79           | 36.72           | sqm           |
| Mezzanin       |                          | Services and             | BTR Communal   |        |        |                  |                 |               |
| €round         |                          | BTR (                    |                | 719.50 | 51.52  | sqm              |                 |               |
| Lower Ground   | Carpark and BTR Communal |                          |                |        |        | 43.75            | 6.94            | sqm           |
| Sub Total      | 91                       | 109                      | 28             | 69     | 297    | 21433.67         | 1214.27         |               |
|                | 30.64%                   | 36.70%                   | 9.43%          | 23.239 | 6 100% | refer to drawing | 58.33%          | Ratio to Site |

Note 1: All areas are approximate only and are to be confirmed by surveyor.

Note 2: GFA (Gross Floor Area) - Brisbane City Council Definition:

*Gross floor area*, for a building, means the total floor area of all storeys of the building, measured from the outside of the external walls and the centre of any common walls of the building, other than areas used for—

- · building services, plant or equipment; or
- access between levels; or
- · a ground floor public lobby; or
- a mall; or
- · parking, loading or manoeuvring vehicles; or
- · unenclosed private balconies, whether roofed or not.

# 01 SURROUNDING CONTEXT INTRODUCTION

The project is located at the corner of Campbell Street and Hurworth Street, and shares a laneway with Richmond Apartments to the south. The site currently contains single / 2 storey buildings relative to its Campbell street frontage increasing to 2/3 storeys when accessed from the aforementioned service laneway.

The site is within the Bowen Hills Priority Development Area and zoned mixed use. To the west of the site, across Hurworth Street is Code Apartments. To the North, nearby is Madison Heights Apartments at 30 storeys and a DA approved 30 storey development (DA ref#: DEV2021/1193) replacing a collection of one / two story businesses. Bowen Hills railway station is also located to the North of the site. To the east is retail and residential areas. To the south is Fortitude Valley and Brisbane City beyond.

The proposal provides a new residential tower with basement and podium parking, podium communal areas and activated spaces on the ground level. The proposal has been designed as a build-to-rent tower.

Build to rent refers to a residential development in which all apartments are owned by the developer and are leased out to tenants.

For the design, this means provision of enhanced residential facilities and amenities tailored to attract a longer term rental market with a mix suited to the rental demographic.


The design addresses the various street frontages with a unique composition of highly articulated forms. The design program focuses of maximising street activation along the Campbell + Hurworth street frontages with more public orientated communal spaces. Improved verge setbacks, footpath treatments, planting and awnings, seamlessly integrate with the building architecture entry points, terrace spaces and fully glazed circulation features, that encourage passive surveillance in a high amenity vibrant environment. The corner of Hurworth street and the service orientated laneway is composed of vehicular / services entry points contained within a setback facade under uniquely articulated, cantilevering podium elements. They include a random composition of layered precast features, including linear green walls, planters and a select number of openings that disguise the service / vehicular entry points and necessary service orientated program elements of the project.

Queensland's subtropical climate has informed the introduction of many planted features. Green wall features, planter boxes and street trees are integrated into highly articulated podium elements capped by landscaped features on the podium deck. The tower form continues this theme with a fluid pattern of planter boxes that run up the full length of the facade and within facade recesses that address the circulation corridors of the tower. The roof top communal spaces similarly integrate landscape elements around pool, BBQ and common use spaces. All improve the biophilic attributes of the project to the benefit of the residents and the immediate local community / streetscapes that the project addresses.

The proposal responds to a range of factors to provide livability within the rental market in the Bowen Hills precinct. The built form delivers a range of apartment spaces, and a variety of communal use spaces to the podium focusing on street activation, podium roof deck spaces, and roof areas that take advantage of the extensive outlook opportunities.



# 01 SURROUNDING CONTEXT

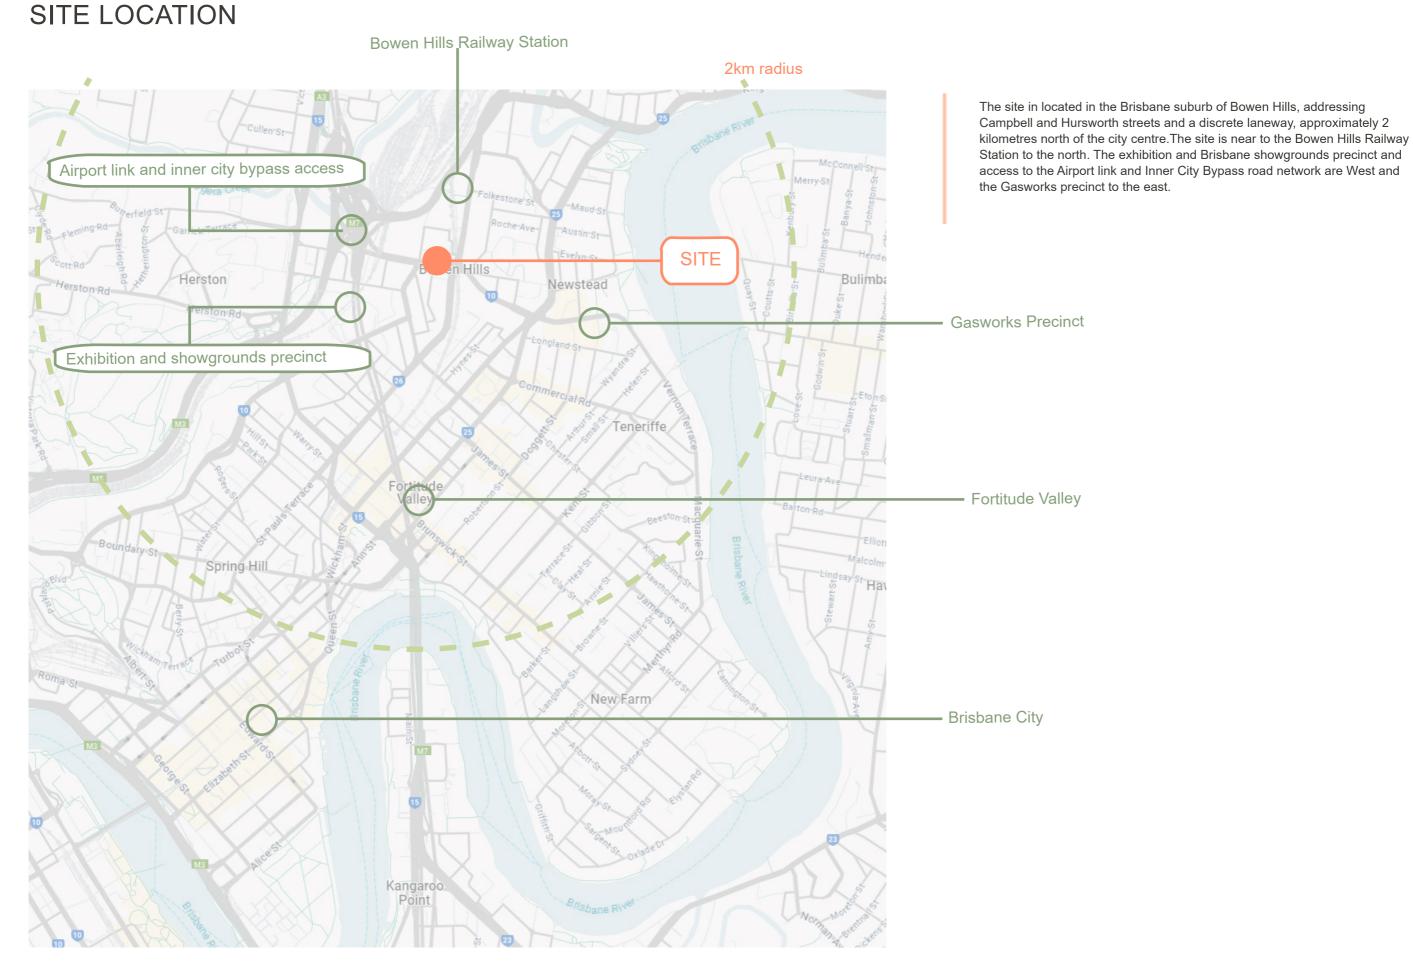

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#### 01 SURROUNDING CONTEXT

#### **EXISTING URBAN PRECINCT**




**SOUTHERN VIEW** 



NORTHERN VIEW

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#### **EXISTING STREET VIEWS**

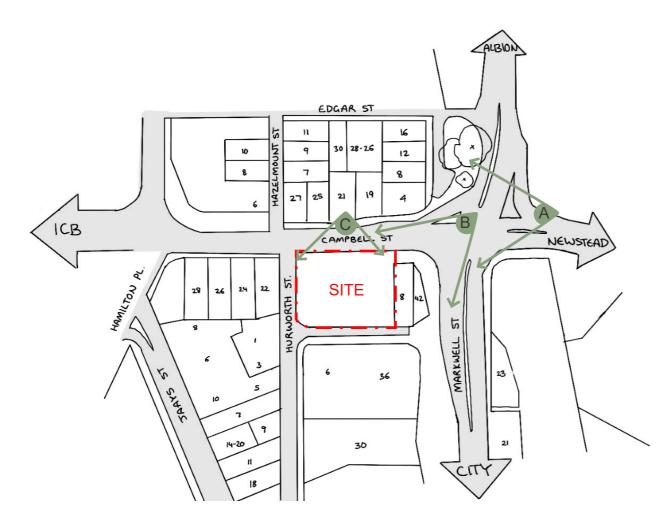

The sites' main frontage addresses Campbell Street and will focus entry and street activation enhanced pedestrian amenity attributes along the full length of this frontage. The site sits behind the long term MSI Brisbane - womens health clinic, that addresses the main intersection of Markwell and Campbell streets, and is visible along significant vehicular links in both directions of Markwell street and from Montipelier Road when approaching the same intersection from Fortitude Vallley.








A View from Montpelier Road toward site

View from Markwell Street Intersection toward site

C Campbell Street

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#### **EXISTING STREET VIEWS**

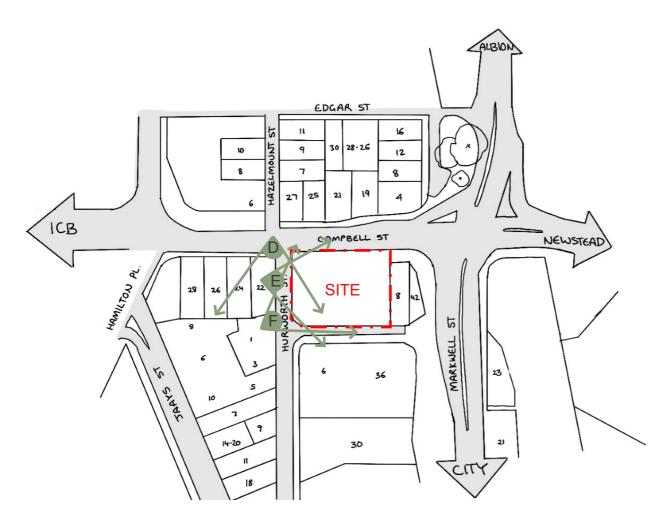

The view of the intersection of Campbell Street with the secondary Hurworth Street show existing single / two storey business with some off street parking that predominantly address Campbell street. Hurworth street falls over two meters towards a dead end laneway to the southern side of the site, that services the sites existing businesses + Richmond Apartments vehicular / services entry points.








D Hurworth Street looking south

E Hurworth Street looking at site

Hurworth St and laneway Corner

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#### SURROUNDING VIEWS

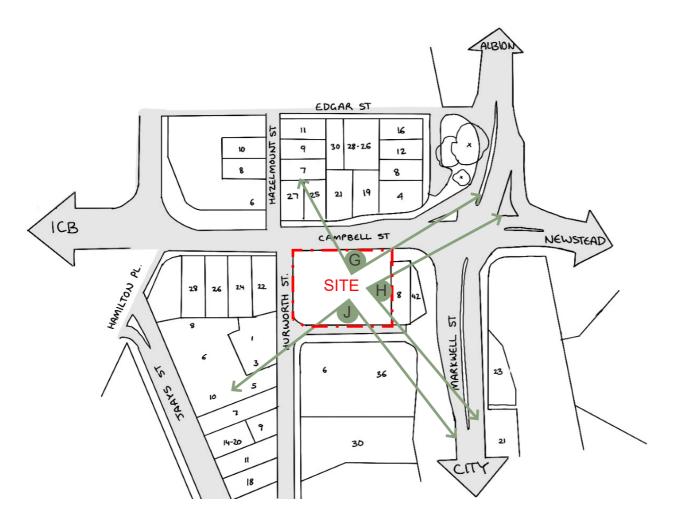

View lines to the east are uninterrupted across Newstead toward the Brisbane River. The south offers elevated city views across the fully developed Richmond and Code apartments and over the adjacent Sullivan Nicolaides Pathology Lab.







G North east suburban views @ 100m

H Newstead views @ 100m elevation


J City views @ 100m elevation



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# 02 Site Analysis

#### **CONTEXT - SITE ANALYSIS**

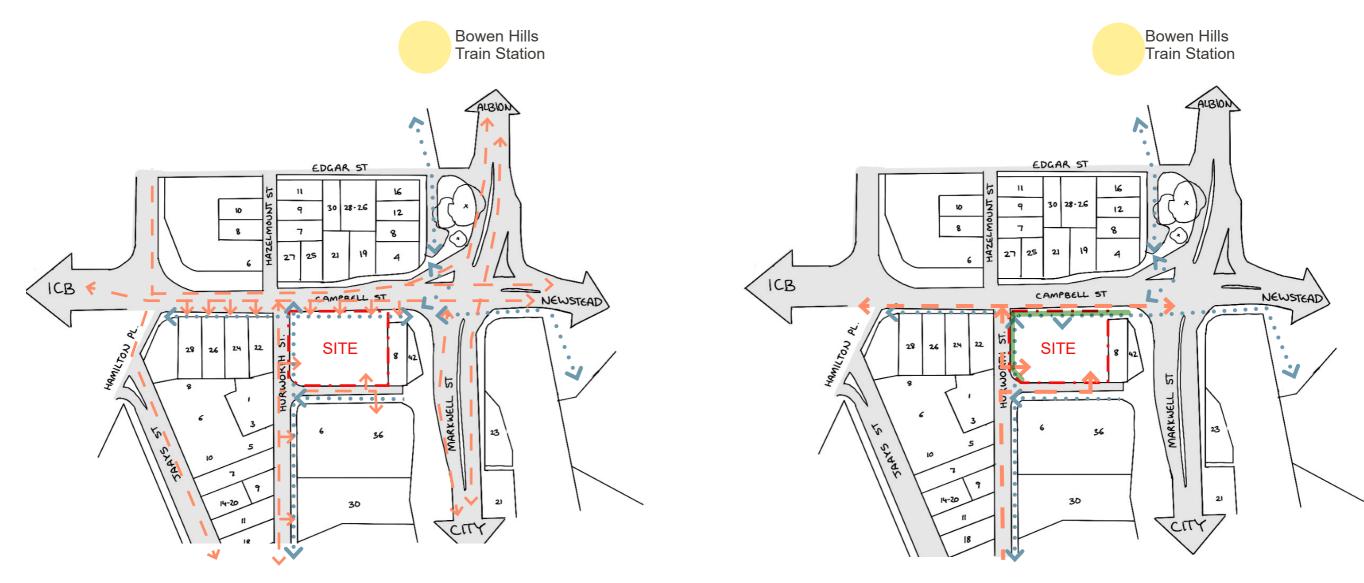

Traffic + Pedestrian Analysis

Traffic + Pedestrian Site Response

A pedestrian analysis shows strength in the pedestrian connection that exists from the south of the site travelling north across Campbell Street and to the Bowen Hills train station (and vice versa). Significant attention will subsequently be given to the sites main Hurworth Street and Campbell Street frontages ensuring the pedestrian footpath enhancements, landscaping, safety and activation from the project functionalities, enhances the experience along the envisioned PDA's boulevard

#### enhancements.

Vehicle servicing and drop-off will be difficult along the busy Campbell Street frontage with the relatively steep Hurworth street frontage only suitable for on street short term parking. Vehicular access into the site will be limited to the southern end of Hurworth street - maximising the distance to the Campbell Street intersection, along with the laneway, that currently is the main vehicular service point for the adjacent Richmond Apartments.

#### Legend


••>


Pedestrian route

Traffic + vehicular loading

Footpath / Landscaped boulevard enhancement opportunities

#### **CONTEXT - SITE ANALYSIS**

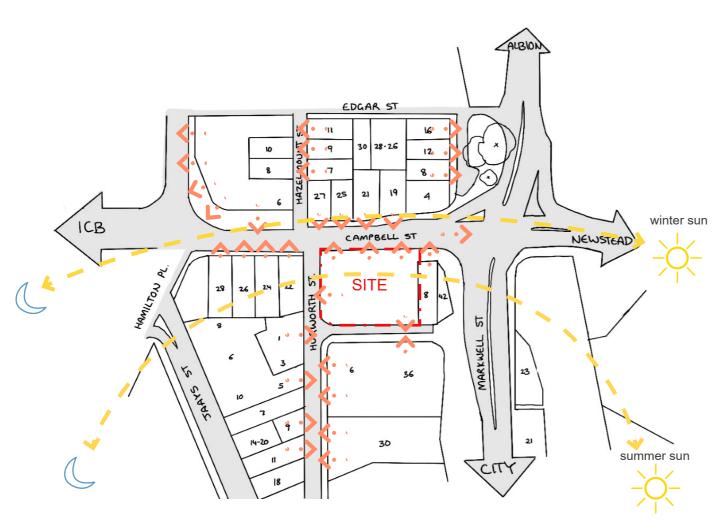

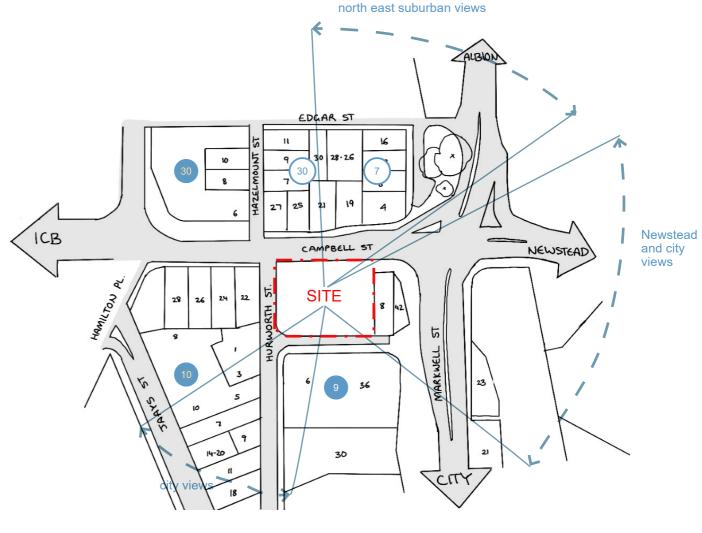

Land Use + Activation Analysis

Views + Open Space Site Response


The existing land use and activation shows a series of one and two storey small businesses flanked by the large residential towers including Code Apartments to the East and Richmond Apartments to the South of the site.

The sites' primary address, Campbell Street, is on the northern side of the site. The summer sun reaches the east, north and west facades, with little impact of shading from existing and future tower developments.

Panoramic views to the north-east across Albion continue uninterrupted to the east/south east across Newstead toward Brisbane River and beyond. The south offers significant city views across the Richmond and Code apartment complex and over the adjacent Sullivan Nicolaides Pathology Lab.



# VIEW CORRIDORS @ 25M

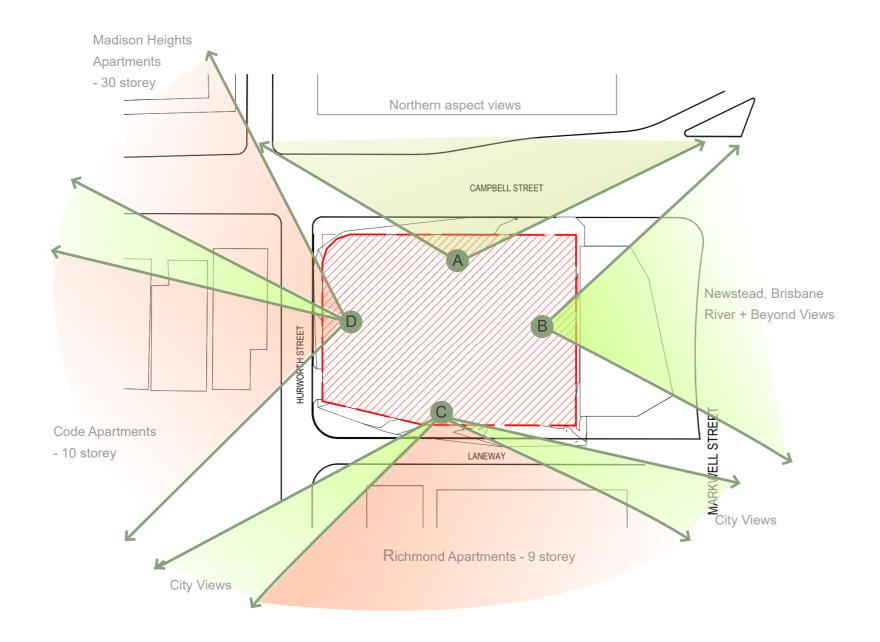

Note: Current Northern views subject to obstruction due to the 9-25 Campbell Street residential development



A Northern views @ 25m elevation



B Eastern views @ 25m elevation




Southern views @ 25m elevation




Western views



# VIEW CORRIDORS @ 50M

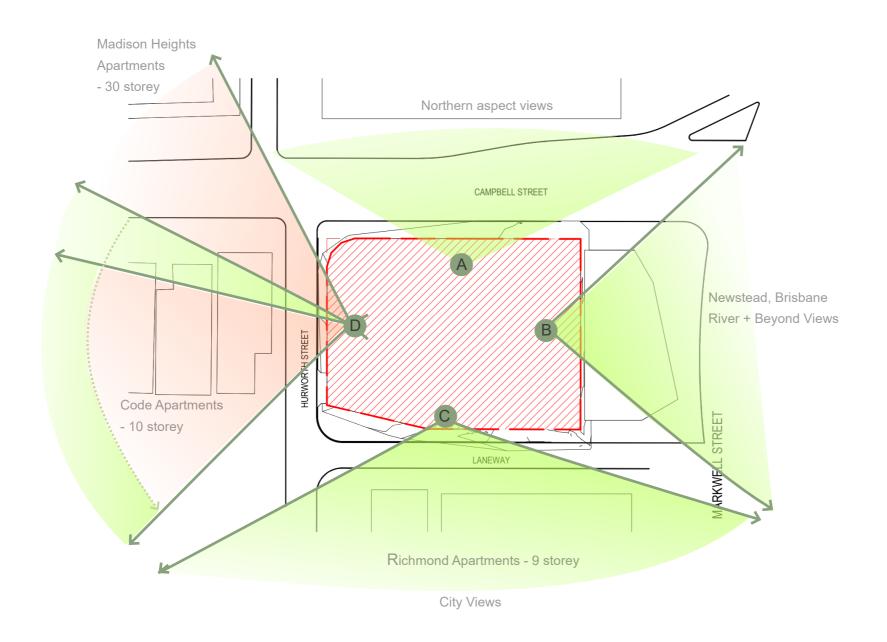

Note: Current Northern views subject to obstruction due to the 9-25 Campbell Street residential development

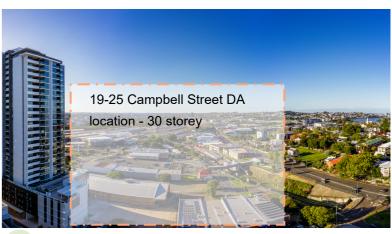

A Northern views @ 50m elevation



B Eastern views @ 50m elevation




C Southern views @ 50m elevation



Western views



# VIEW CORRIDORS @ 75M

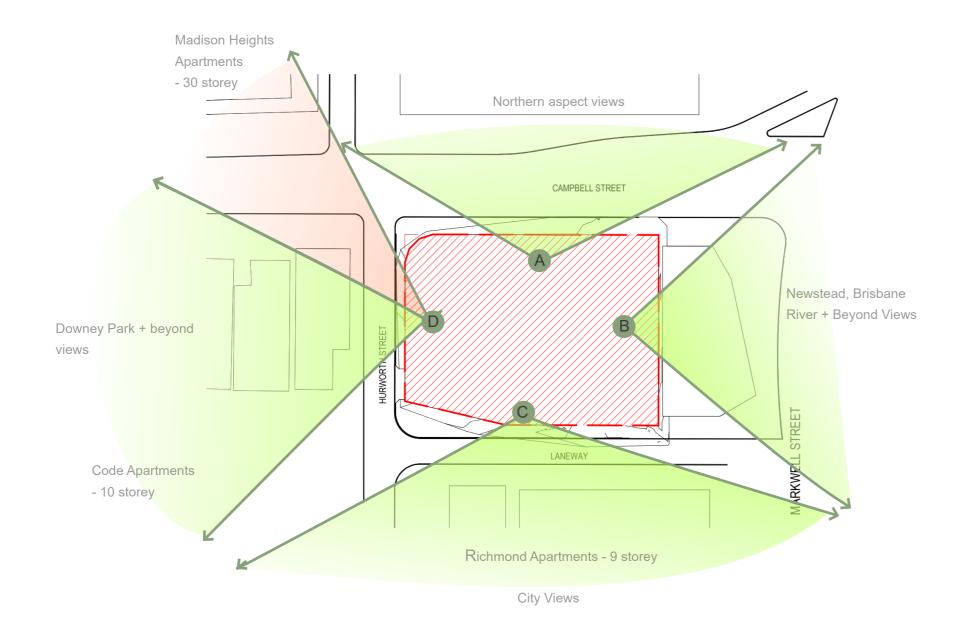

Note: Current Northern views subject to obstruction due to the 9-25 Campbell Street residential development



A Northern views @ 75m elevation



B Eastern views @ 75m elevation




Southern views @ 75m elevation



Western views @ 75m elevation



# VIEW CORRIDORS @ 100M

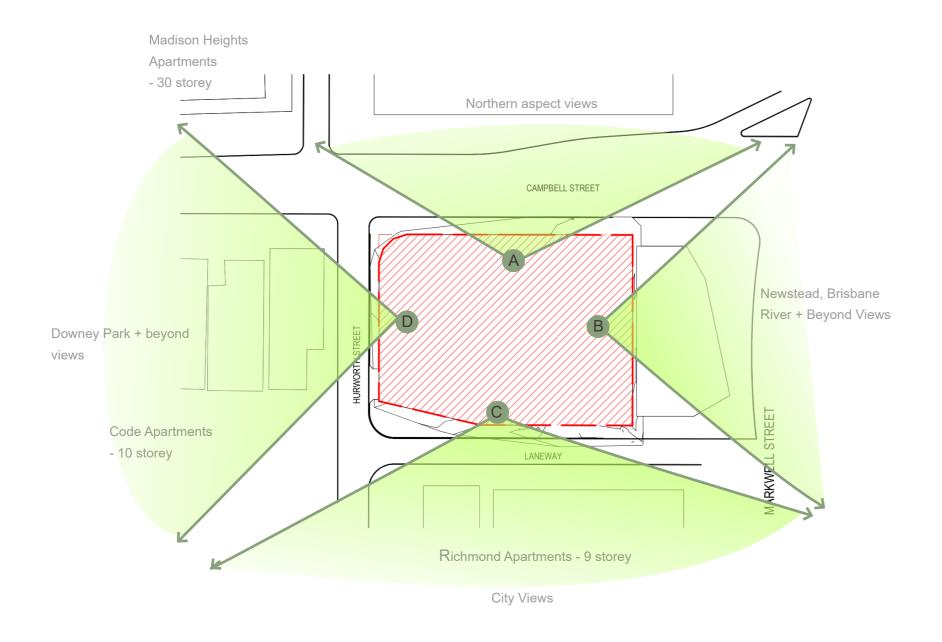

Note: Current Northern views subject to obstruction due to the 9-25 Campbell Street residential development



A Northern views @ 100m elevation



B Eastern views @ 100m elevation



Southern views @ 100m elevation




Western views @ 100m elevation

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# Design Response

#### **DESIGN CONCEPT**

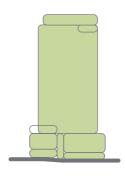

Unique architectural attributes have been utilised to activate the edges of the project in response to the varying contexts and orientations, using layered and fragmented / geometric forms enhanced by functional spaces and landscaped features. The composition of these elements create subtle hierarchies and legibility that intuitively define a vibrant entry experience, the main site corner to Campbell and Hurworth streets, and an activated ground plane focusing on enhanced 'boulevard' attributes with a high level of pedestrian and user amenity.

The interplay of landscape and planter geometries similarly integrate with horizontal and vertical sunshading devices of the tower to optimise its environmental performance, various functionalities and amenity, outlook opportunities, and unique design identity.

Inspired by South-east Queensland architecture, the proposed building form encourages the integration of biophillic attributes that respond to evolving wider urban design contexts, whilst enhancing the immediate local environment / streetscapes, benefiting the amenity of the the local community and residents alike.

Apartments have been orientated to capture mountain, river and / or city views, along with a variety of high quality communal facilities in podium and roof-top locations, that enrich the residents inner urban










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#### DESIGN PRECEDENTS - GROUND INTERFACE /



The detail of the podium facade forms a highly legible and dynamic 3D fissured entry volume. The entry is activated by an equally dynamic circulation stair, linking shared communal facilities within the podium with the semi-public flexible coworking spaces on the ground plane.

All spaces are designed to encourage a sense of community / social interaction between residents, and engage with / activate the primary and secondary street frontages of Campbell + Hurworth Streets. The spaces are enhanced by a composition of interconnected volumes, landscaped features and materials that seamlessly integrate with the uplifted 'boulevard' attributes of the street.

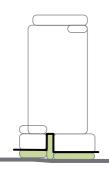

Shady pedestrian pathways

Street edge activation / passive surveillance





Native timber elements





Interconnected / feature stair

Recessed entry



Biophilic Elements









Shared co-work / communal spaces

#### **DESIGN PRECEDENTS - PODIUM FACADE**



The podium design addresses quite diverse streetscape genres / functionalities; from the north facing highly activated main Campbell Street frontage that transitions and falls along to the west facing Hurworth Street, to the utilitarian vehicular / service orientated laneway.

The adjacency and functionalities of the podium program comprised of main entry communal spaces and facilities, bicycle and vehicular circulation and storage, to base building services and associated street interfaces, are carefully managed to optimise the functionality, potential and amenity of each streetscape interface.







Geometric forms











Concrete


Expressed horizontal edges/ vertical screening

Framing Views

A number of architectural elements are used in the differing contexts to create a unified whole, with references to the attributes of the tower design. These include the layered integration of landscaping, featuring green walls in horizontal and vertical recesses engaging with the composition of geometric forms that include expressed or recessed planter boxes.

Geometric shaped recesses or expressed framed elements also integrate with glazing features to frame functional spaces / views from both inside and out. The unique composition of all these elements integrate with horizontal and vertical shading devises to suit the varying orientations and architectural / urban design objectives.

## **BUILT FORM AND SCALE - PODIUM**

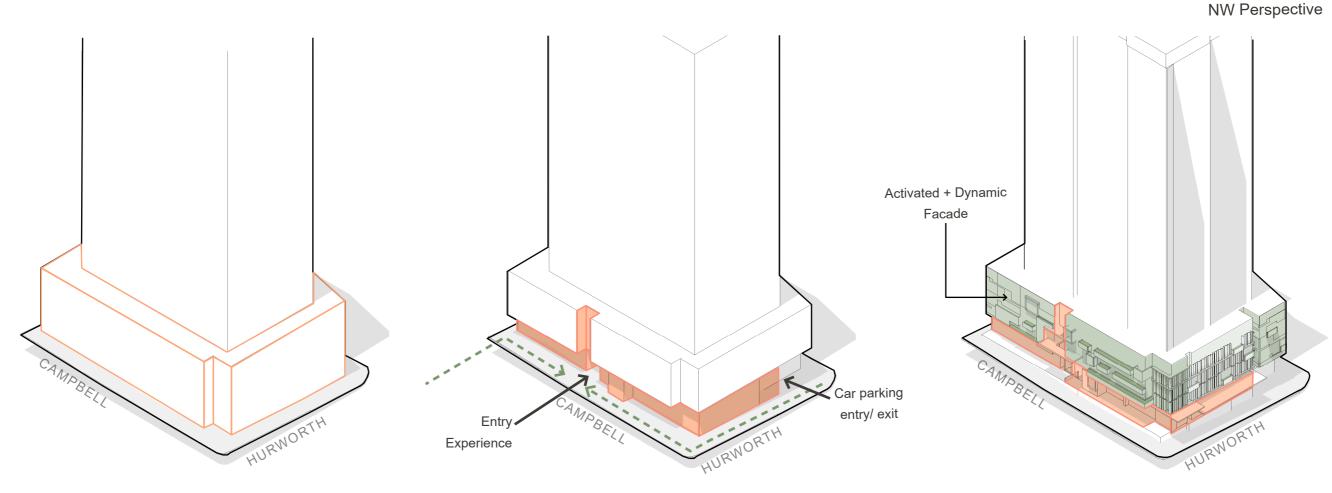

1. BUILDING MASS





2. ARRIVAL SEQUENCE





The activated frontages along Campbell and Hurworth street provide a high amenity link between the surrounding community to the public transport node of Bowen Hills Station. The falls provide opportunities for slightly elevated planters, terraces, and internal communal spaces, that interface with the street providing opportunities of visual connectivity and passive surveillance.

A highly legible entry feature is created by deconstructing geometric forms and spaces, resulting in a highly articulated vertical entry fissure / recess, visually activated by a dynamic transparent stair linking adjoining communal spaces to all podium levels.

3. COMMUNAL AREA + STREET ACTIVATION







The composition of architectural elements, geometric forms and landscape features increase in intensity, transparency, and level of articulation to draw the eye to the main entry and / or podium corner features for improved legibility, activated by the buildings communal spaces.


As the building program within the podium changes to accommodate car parking or base building services infrastructure, the geometric / planter detail changes to a composition with a less transparent backdrop of layered concrete walls or vertical screening, picking up on the detail of the tower over.

The primary north facing frontage of Campbell Street interfaces with a 4 level podium that falls over a meter to a typical 3 chord truncation at the corner with Hurworth street. The street then falls more aggressively along Hurworth street over 2 meters to its southern boundary. Footpath verge and ground level setbacks capped by awnings, provide a distinct recessed break between the street level and built to boundary podium levels over.

## **BUILT FORM AND SCALE - PODIUM**

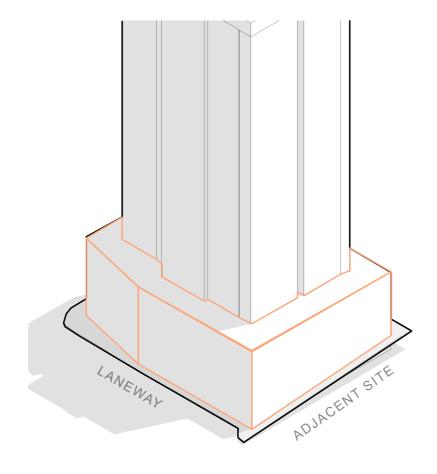

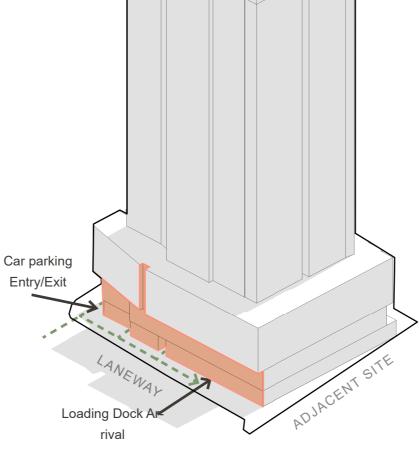

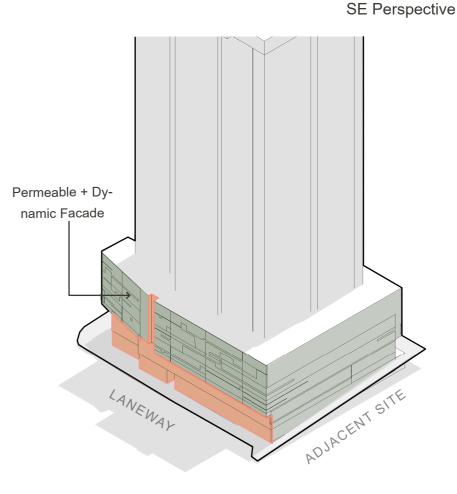

1. BUILDING MASS





2. ARRIVAL SEQUENCE





3. COMMUNAL AREA + STREET ACTIVATION





The fall of the land north to south of over 3 meters, enabled an additional basement level to be added, accessed at grade from the service laneway, resulting in a 5 level podium. A right of way volumetric easement along the length of the laneway provides a break with the built to boundary podium levels over. A triangular truncation at the intersection of Hurworth st and the laneway, created the opportunity to express this corner as an object that cantilevers over the main car park entry off Hurworth street.

I his corner


object is accentuated with recessed slots that interface with planters, that further breaks up the mass of the podium and references similar details of the tower over. These elements along with the easement setback enables the various base building services and vehicular access points that address the street to be less visually prominent, being in the shadow of the cantilevering podium feature masses over. The geometric and layered organic attributes of the podium design continue to suit the service orientated laneway streetscape interface.

The permeability of the built to boundary podium masses has been

carefully curated to provide openings for recessed or expressed planter boxes that screen the car park / plant spaces behind. This is juxtaposed against a solid wall backdrop that is layered with vertical and predominantly horizontal recesses intended to accommodate green wall planting. The podium is capped by landscaped features of the private / communal spaces over. The composition of all these elements creates a fluid, textured facade featuring landscape features that enhances the biophilic / subtropical attributes of the project to0 the benefit of the laneway + adjacent residents.

#### **GROUND LEVEL DESIGN**

Ground Floor Plan 1:100 @A1

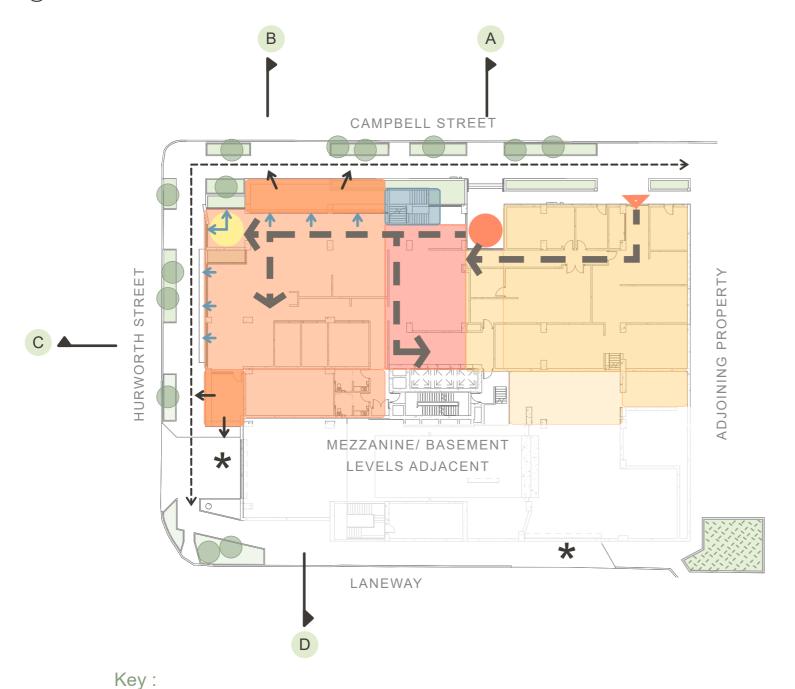

Landscaped foothpath 'Boulevard' streetscpae uplift

← Pedestrian circulation path


Main entry feature

Resident Bicycle entry

Main Entry / Central meeting points

Numerous strategies have been employed to accommodate efficient, dynamic communal facilities with unique spatial qualities that encourage resident engagement, social interactions and sense of community. The transition from public zones and streetscape interfaces to the projects communal spaces and progression to other buildings facilities has been carefully curated to ensure that the opportunities for optimal street activation and maximised legibility of key entry / building features are achieved.

Please refer to the adjacent diagram + key.

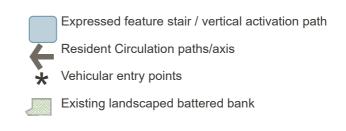

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Communal Outdoor Terrace

Expressed corner activation

Internal communal spaces

Less active communal spaces

Active frontage / passive surveillance

**Direct Street Activation** 

#### TYPICAL PODIUM LEVEL

Typical Floor Plan 1:100 @A1



The composition and layered detail of the geometric, landscape + screening facade features, carefully transition between high quality communal spaces that encourage social engagement and visual connections prioritising the activation of Campbell street, to less visually permeable features that screen car parking and base building service / plant spaces that address Hurworth Street and the laneway, relying on biophilic attributes to optimise the amenity of these frontages.

Please refer to the adjacent diagram + key.

#### PROPOSED CAMPBELL STREET INTERFACE

The legibility of the buildings main entry off Campbell street is increased by numerous design attributes:

- Hierarchy / intensity of articulation / detail + transparency increases towards the entry features, naturally drawing the eye / user to this space.
- Creation of a full height entry feature with deconstructed edges and volumes creating depth and variety, likened to a 'fissure' within the podium mass.
- geometric elements / faces / frames created to suit the adjoining communal spaces / landscape features.
- higher footpath entry awning + building id signage addressing the entry threshold.
- Activation of the entry volume by the co-location of a feature stair + circulation spaces providing movement and interest in the facade.













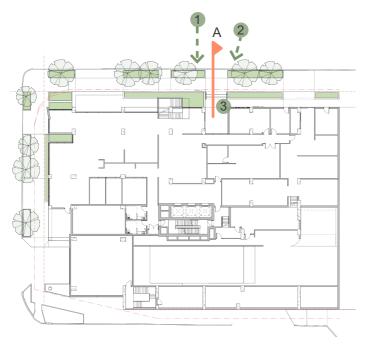



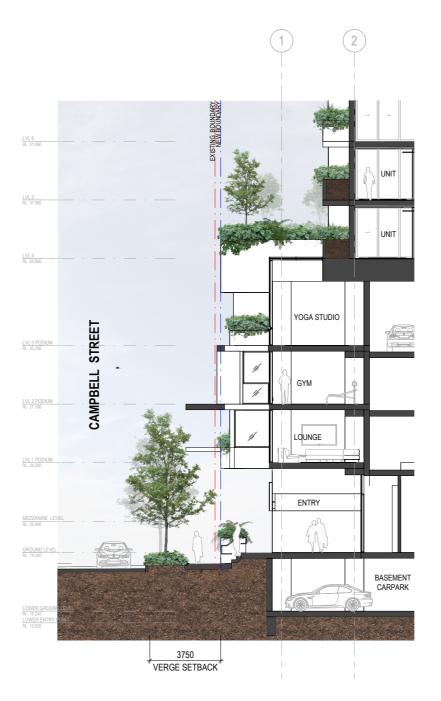







Section A

#### PROPOSED CAMPBELL STREET INTERFACE

The Campbell street frontage activation to all levels is further maximised by locating all socially orientated / active communal uses along this frontage, with the glazing elements designed to provide visual connections both in and out - including:

- · Various settings of flexible cafe style co-work spaces on the ground, include elevated external terraces that maximise potential engagement + passive surveillance with the street.
- Level 1 communal games, lounge + karaoke spaces
- Level 2 communal gym spaces including cardio + weights settings
- Level 3 wellness space/ yoga studio, and dog play areas.

The corner to Hurworth street is expressed architecturally, with increased transparency to themed active uses behind screening features to suit the north western orientations. Footpath awnings and landscaping / trees and street furniture optimise the boulevard / promenade attributes of this












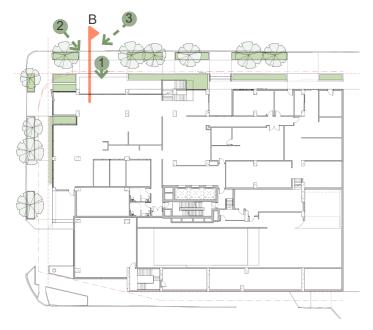

Key plan - Ground Level - N.T.S















10 - 16 Campbell Street, Bowen Hills CFMFU Rev H Design Report March 2025 **nettleton**tribe

#### PROPOSED HURWORTH STREET INTERFACE

Hurworth streets activation transitions from the highly activated Campbell street frontage and corner to the enclosure / screening of the utilitarian base building functionalities.

The direct activation is prioritised to the ground level with the co-work spaces addressing the street with an elevated terrace providing views down Hurworth street to the south and visa versa. These fully glazed spaces are protected from the western orientation by footpath awnings and trees as a continuation of the Campbell st promenade.

The footpath awnings provide a natural break with the podium levels over accommodating the projects resident car parking with natural ventilation sourced along this frontage. The composition of the podium facade design attributes / themes transition to integrate vertical screens, extended slab edges, expressed planters and green wall recesses / layering, providing a dynamic facade that disguises the car parking behind.













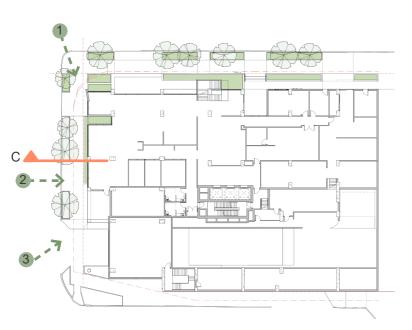

Key plan - Ground Level - N.T.S

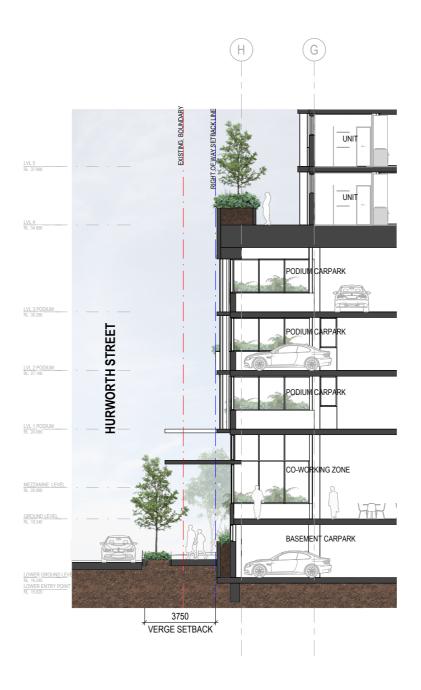










#### PROPOSED LANEWAY STREET INTERFACE


Although the laneway is predominantly base building service / vehicle orientated, features a well landscaped / treed battered bank at its eastern end that extends to Markwell street beyond.

- The naturalistic, biophillic attributes of this laneway are enhanced by focusing the articulation of the podium facade with a composition of landscape features of planter boxes + select openings connected by layered / textured vertical and horizontal recesses that accommodate green wall plantings.
- The relative impervious facade that disguises car parking and base building plant spaces, provides a feature landscaped outlook from the street and adjacent properties.
- The vehicular / service entries setback to accommodate a volumetric right of way easement along the length of the laneway, become secondary to the cantilevering landscaped podium over.

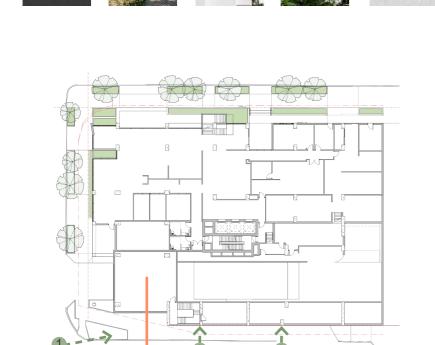


Key plan - Ground Level - N.T.S



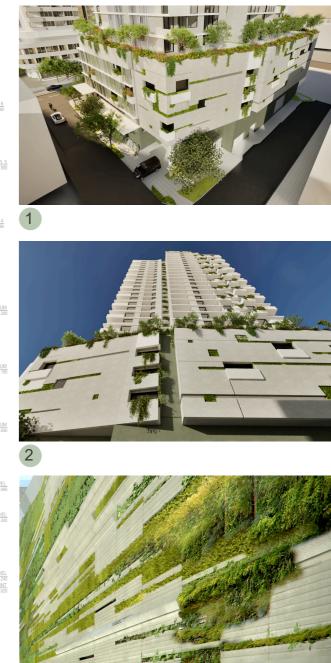

## **DESIGN PRECEDENTS - TOWER ARCHITECTURE**

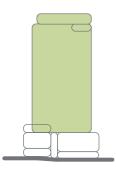

The tower composition has unifying horizontal elements of expressed slab edges that provide horizontal shading, support for vertical screen blades protecting the east and west building faces, and deep breakout balcony spaces of the units. The fluidity and geometry of the podium design is referenced with a regular pattern of expressed planter boxes that run the full length of the tower, that link and break up the horizontal projections with layered texture, variety and shading. The composition and biophilic attributes of the tower are further enhanced by recesses that accommodate planters at the end of circulation corridors of each level, which orientate users with natural light and framed views of Newstead and the Brisbane river to the east, and City views to the south.



Planted Edges

Harnessing views





Variety of communal facilities / spaces







Local sub-tropical planting

Vertical green corridors











Horizontal and vertical shading

The top of the tower is capped with landscaped features juxtaposed with an expressed frame / arbour that integrate with a variety of internal and external communal spaces providing a subtle sense of enclosure whilst framing the significant views.

## **BUILT FORM AND SCALE -**

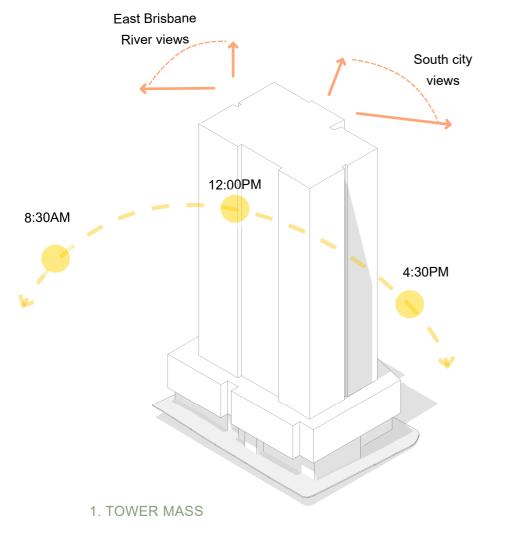

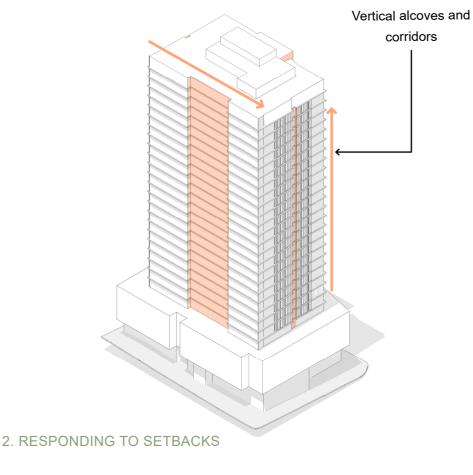















The tower form closely aligns with the boundary and associated setback lines established for the project, and the 13 unit / floor configuration contained therein. The majority of units address the favourable northern orientations and the continuing significant panoramic view opportunities of the river / bay + city to the east and southern orientations respectively.

The primary circulation corridors around the core provide user orientating + framed outlook opportunities to these views and are expressed as full height planted recesses in the facade - breaking up the mass of the tower form.

Residual area in the setback zones enable necessary protection of the similarly detailed east + western facades, utilising horizontal + vertical sun shading devices. The residual north and south areas are populated with planter boxes in a regular pattern of varying positions and depths, providing a dynamic / fluid green corridor linking the landscaped zones of the podium and roof, referencing the highly articulated organic / geometric attributes of the podium facade.

These biophilic attributes in consideration of Brisbane's sub-tropical climate and improved environmental outcomes, significantly improves the amenity of the residents and the wider local communities.

The interplay of predominant horizontal edges with the articulation of walls, glazing and balcony recesses / edges / vertical screening, broken up by the aforementioned green facade features provides a unique addition to the skyline.

To the roof, the enclosed communal and well disguised base building plant spaces are setback to reduce the apparent bulk and height of the building. However, an expressed frame / arbour has been introduced around the perimeter to visually crown the tower, along with the aforementioned benefits of providing a subtle sense of enclosure and framed views to the communal facilities and landscape features accommodated on the roof levels.

# TOWER TYPICAL FLOOR LEVEL





User circulation corridor axis / view outlook
Panoramic view / outlook

#### RESPONSE TO SITE CONDITIONS

This Build To Rent (BTR) project typology responds to Brisbane's sub-tropical climate and outdoor lifestyle opportunities to the benefit of residents, the wider community and built environment. This is clearly evident in the unique biophilic attributes in the articulation of the projects built form, space planning and connectivity with the exernal spaces/ communal facility feature



#### 1 Orientate Yourself

Located in Bowen Hills - Campbell Street is a busy connector between ICB / Gympie Road and Newstead / Fortitude Valley.

The builind addresses Campbell Street with a highly noticeable, dynamic entry + facade features that integrates with a high quality activated ground plane that becomes a catalyst in the progression of this street to a pedestrian friendly landscaped 'boulevard'. The building massing & program optimises street activation and outlook potential to suit the orientation of the building. This includes circulation paths within the podium and towerm similarly highly noticeable with circulation axis' connecting to natural light, ventilation, views and/ or created outlook opportunities.

#### 2 Occupy Outdoor Spaces

A variety of outdoor spaces are incorporated into the design:

Ground level elevated terraces with fully operable connectivity to adjoining communal spaces provide opportunities to engage and activate the streetscape.

The podium roof deck provides a heavily landscaped cap to the podium featuring private and communal outdoor spaces. Communal lounge spaces interface with external BBQ & picnic spaces and an edible garden invites hands-on interaction with nature. All units have generous balconies as a private external extension to open planned living spaces.


The lower roof levels provide enclosed / semi-enclosed sky lounge and BBQ / dining spaces, leveraging significant city views, along with a roof deck level featuring a 25m main pool with wet edges. In addition, plunge pools all fully integrate into the landscaping/ arbour framing that provide a high level of amenity for the residents with 360 degree panormaic views.

#### 3 Illuminate with Daylight

Considered building setbacks ensure daylight penetration is maximised into the tower and the public realm below. The core is located centrally, this enables positive daylight and expansive views from units. The use of high-quality façade systems and a combination of glazing, solid cladding, sun-shading devices, insulation and deep recesses are proposed to create an efficient response to Brisbane's subtropical climate. All apartments have access to natural light as well as opportunities for deep shade responding to Brisbane's subtropical environment.

#### 4 Natural Air and Ventilation

Communal spaces, city rooms, apartment lobbies and public/ private balcony spaces have options to be openable, maximising indoor/ outdoor engagement and natural ventilation opportunities supplemented by mixed mode mechanical ventilation systems. Outdoor breakout spaces are arranged in appropriate locations to take advantage of the subtropical climate and outlook opportunities whilst overcoming environmental challenges.

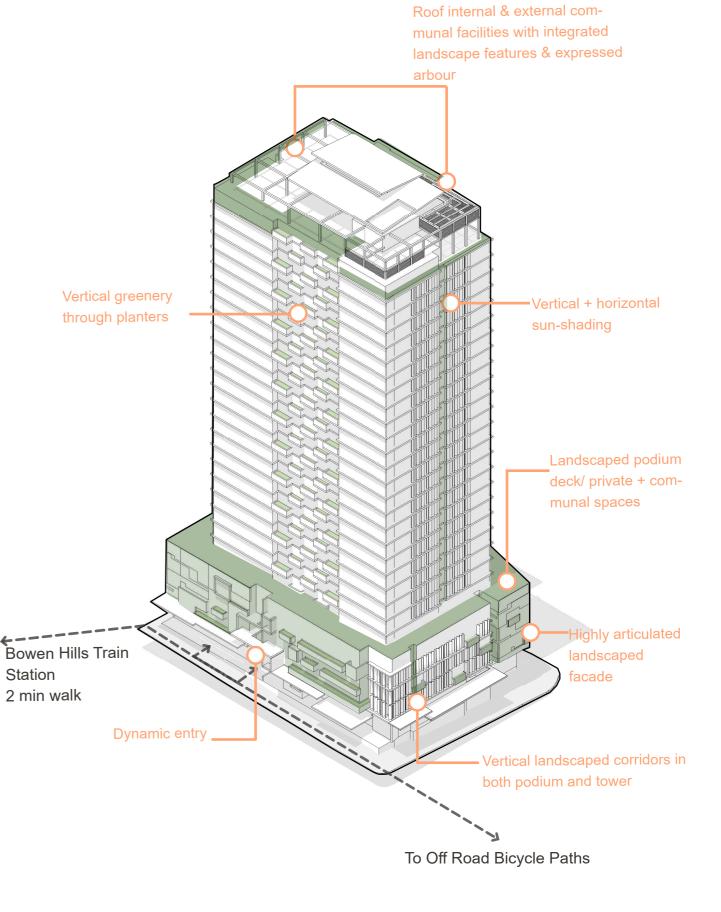



#### 5 Shade and Protect

The ground level boundary setbacks integrated with footpath awnings, street trees and landscape features, provide a high amenity shaded promenade to the street frontages. The design and unique composition of architectural sunshade and platner/ landscape and balcony features to suit the various orientations and functionalities, provide a high degree of articulation and shade with subsequent liveability benefits to all occupied spaces of the podium and tower.

#### 6 Living Greenery


Landscaping elements feature heavily in the composition and articulation of the design, promoting SE QLD's subtropical lifestyle and biodiversity whilst enriching the public domain and various external space interfaces within the project. Organic, geometric attributes are integrated into the facade design with the extensive use of planters (expressed or recessed), green walls - expressed vertically and horizontally, and elevated gardens integrated into the tower facade and the podium/ tower roof levels.

#### Identity Matters

The architectural language featuring layered organic, geometric forms and complimentary materiality, with significant integration of landscape features highlighted with discrete lighting, will provide a unique exemplary addition to Brisbanes' subtropical urban/ built environment landscape.


#### 8 Reduce Energy and Water

The building is in close proximity to the CBD/ public transport options with highly accessible active transport (bicycle facilities) provided, reducing the reliance on cars. Electric/ share car provisions will further negate this need. The building build to rent - developer/ owner long term hold project vs developer short term hold/ sell model, results in an interest in integrating environmental initiatives that have longer term payback/ value add benefits. Water/ energy efficiencies + harvesting have well known short and long term benefits. Optimally designed building services and robust materiality/ detailing reduces ongoing running and maintenance costs. Improved environmental outcomes and high quality communal facilities improves tenant amenity/ churn rates + sustain property values over the long term.

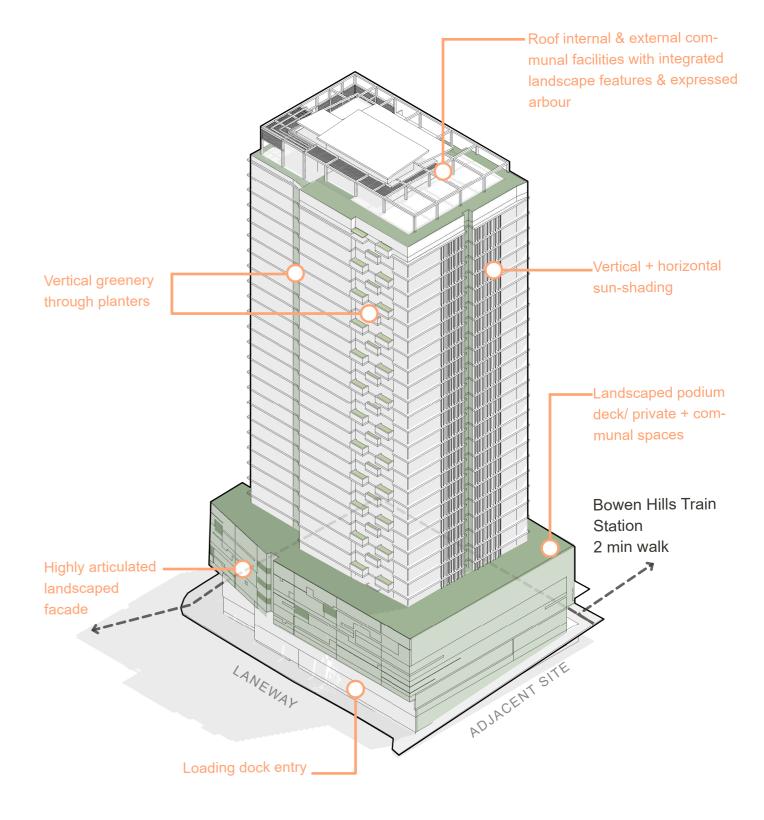

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#### BUILD TO RENT - COMMUNITY WITHIN THE WIDER COMMUNITY

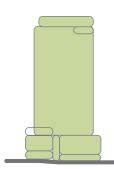

Large high density residential projects are typically designed, constructed and managed usually as individual single unit assets of various typologies for long term ownership and short / longer term rental. Build-to-rent (BTR) is aimed at a growing rental market seeking long term rentals, community identity, with the whole development owned / managed by a specialist investment entity.



1 FLEXIBLE LEASING

Residents will have options to relocate into different apartments without breaking their lease, depending on their needs. Residents will also have flexible carparking and storage options at any time during their lease, resulting in savings to the tenant



2 VALUE ADDED SERVICES

Wide range of non-tenured services can be offered to residents by BTR management. This includes dry cleaning, dog walking, house cleaning, furniture, and appliance packaging. Thus, resulting in a high standard of convenience suitable for urban living styles.



3 COMMUNAL AREAS

The concept design for the BTR project has been designed to maximise amenities available to the residents. The design proposes 2885.14m2\* of common areas located on ground, podium and deck levels as well as dynamic roof level recreation spaces. All the common spaces provide unimpeded views of the Brisbane River to maximise the livability of the project with common areas equating to over 9.7m2 per unit.

\*Note: Includes indoor and outdoor areas. Refer to 14284\_SK41



4 TECHNOLOGY

The development will be provisioned for the latest in technology for all residents including self-management of leases, subscriptions and booking for communal areas. Electric car/bicycle share and automated parcel storage are available additions to technology orientated living style.




5 WELLNESS AND PET FRIENDLY

Classes range from gym to yoga and wellness, and are available to all residents, lifting the standard of apartment living alongside resident's lounges.

The development will be pet friendly for resident's animals, who will have access to a ground level pet washing facility. Surfaces are specified for high wearing to minimise the wear and tear from pets.

#### **BUILD TO RENT - PRECEDENTS**

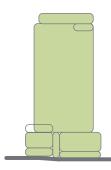



1 LOBBY

Opportunities for casual/ shorter term engagement occupation, chance social interactions + meet and greet points



2 CO-WORKING

Co-working spaces are located on the ground level that facilitates various levels of resident/ external visitor engagement within various settings including:

- cafe style internal/ external social spaces
- Individual, small group and larger group settings
- Various scaled multi-purpose meeting rooms
- Hospitality provisioning bar/ cafe/ kitchenette/ short term storage



3 GAMES + RECREATIONAL

More socially orientated games and recreational spaces, with the potential resident, guest interaction is located on the 1<sup>st</sup> level with direct connection to the ground level entry/ co-working spaces. Includes:

Pool table, table tennis, card areas, large screen settings for TV events, gaming and sound proof music room spaces.



4 GYM + YOGA SPACES


The 2<sup>nd</sup> podium level transitions into gym facilities including bike/ cardio machines and weight training spaces that encourage the potential social interactions between residents. Quieter, more contemplative yoga and wellness spaces are on the 3<sup>rd</sup> podium level.



5 BIKE STORAGE

Inner city urban lifestyles are less dependent on cars due to the close proximity to public transport, work and shopping precincts. This is supplemented with personal bicycles for quicker work commuting times + fitness. The BTR project is located close to this extensive network of cycling paths.

## **BUILD TO RENT - PRECEDENTS**

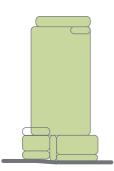



6 COMMUNAL LOUNGES

Various lounge areas are dispersed throughout the communal areas to suit the various social settings including: ground level co-work/ lobby spaces, TV event spaces up to the potential of more sophisticated sky lounge spaces that have the potential for events and leverage the panoramic city skyline views.



7 PRIVATE DINING

Private dining spaces are disbursed throughout the communal areas including the ground level co-working spaces, more casual podium roof deck BBQ spaces to the potentially more sophisticated roof top levels with the panoramic views.



8 ROOFTOP BBQ FACILITIES

the podium rooftop and tower rooftop dining spaces contain BBQ facilities to aid with real time catering to suit the various types of social interactions that occur in these spaces.



9 ROOF TERRACE


Well landscaped private and communal roof terraces provide opportunities for residents to engage with outdoor spaces - fresh air and nature. Communal edible gardens on the podium roof level provide opportunities for hands on interaction with nature.



10 ROOFTOP POOLS

The roof top 25m lap pool and hot and cold plunge pools are integrated into the landscaping and terraces spaces that harness the panormaic views is a fundamental requrement for all larger scale residential developments.

## **COMMUNAL AREAS**

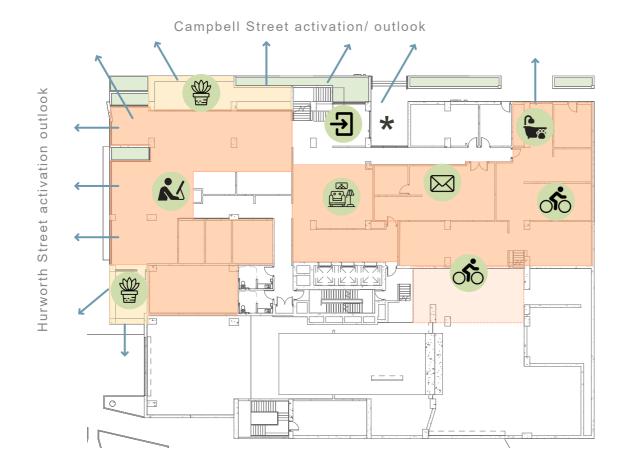

Ground Floor Plan 1:100 @A1

## Campbell Street activation/ outlook Podium Podium Podium Podium Level 1 Level 2 Level 3 Level 1 লি 回

Typical Podium (1) Plan 1:100 @A1

#### 1. Ground Communal Spaces







Co-work settings



Bike Lobby Lounge



parking



Dog wash

Mail parcel/ locker/

delivery



Outdoor Entry Terrace



Street activation/ Passive surveillance

#### 2. Podium Communal Spaces

Lounge

Setting







Cardio/











Arrival Street Point

Weights gym

Storage

Parking

Activation/ Outlook

#### 03 DESIGN RESPONSE

## **COMMUNAL AREAS**

#### 3. Podium Deck Communal Spaces













Podium lounge

Outdoor Recreatio

Communal Gardens

Outdoor BBQ

Arrival Point

\*

View/ Outlook

4. Lower roof-deck Communal Spaces



BBQ

Sky



Arrival Point

\*

View/ Outlook

5. Roof-deck Communal Spaces



lawn

Lap +

Plunge



Poolside

lounge/


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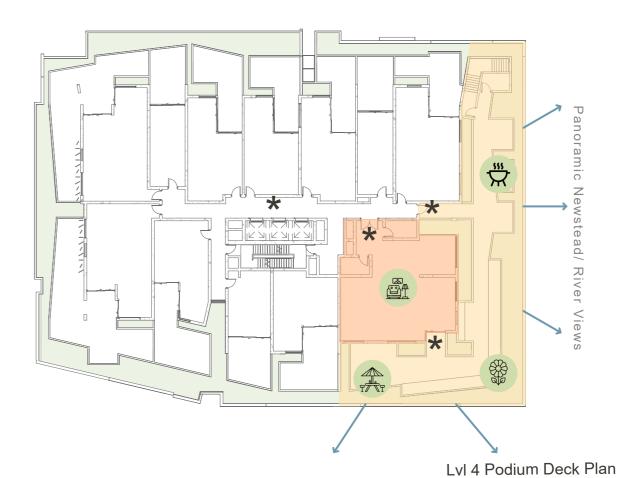
\*

Arrival Point

Panorami c Views



Lower roof level 1:100 @A1

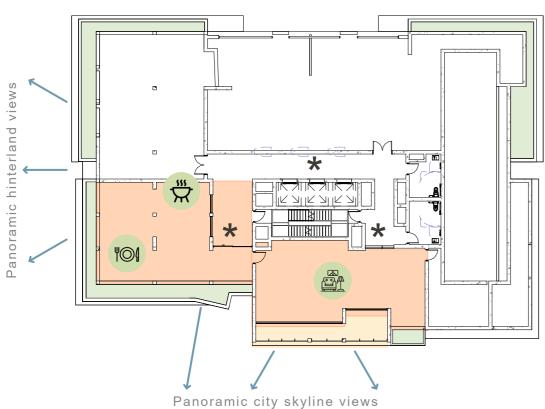

Panoramic Newstead/ River Views

Panoramic city skyline views

Roof deck level 1:100 @A1

1:100 @A1

Panoramic hinterland views

## 04 Visualisation





Corner of Campbell and Hurworth Street











10-16 Campbell Street, Bowen Hills Architectural Design Report 21 February 2025 Rev H

# O5 Architectural Drawings

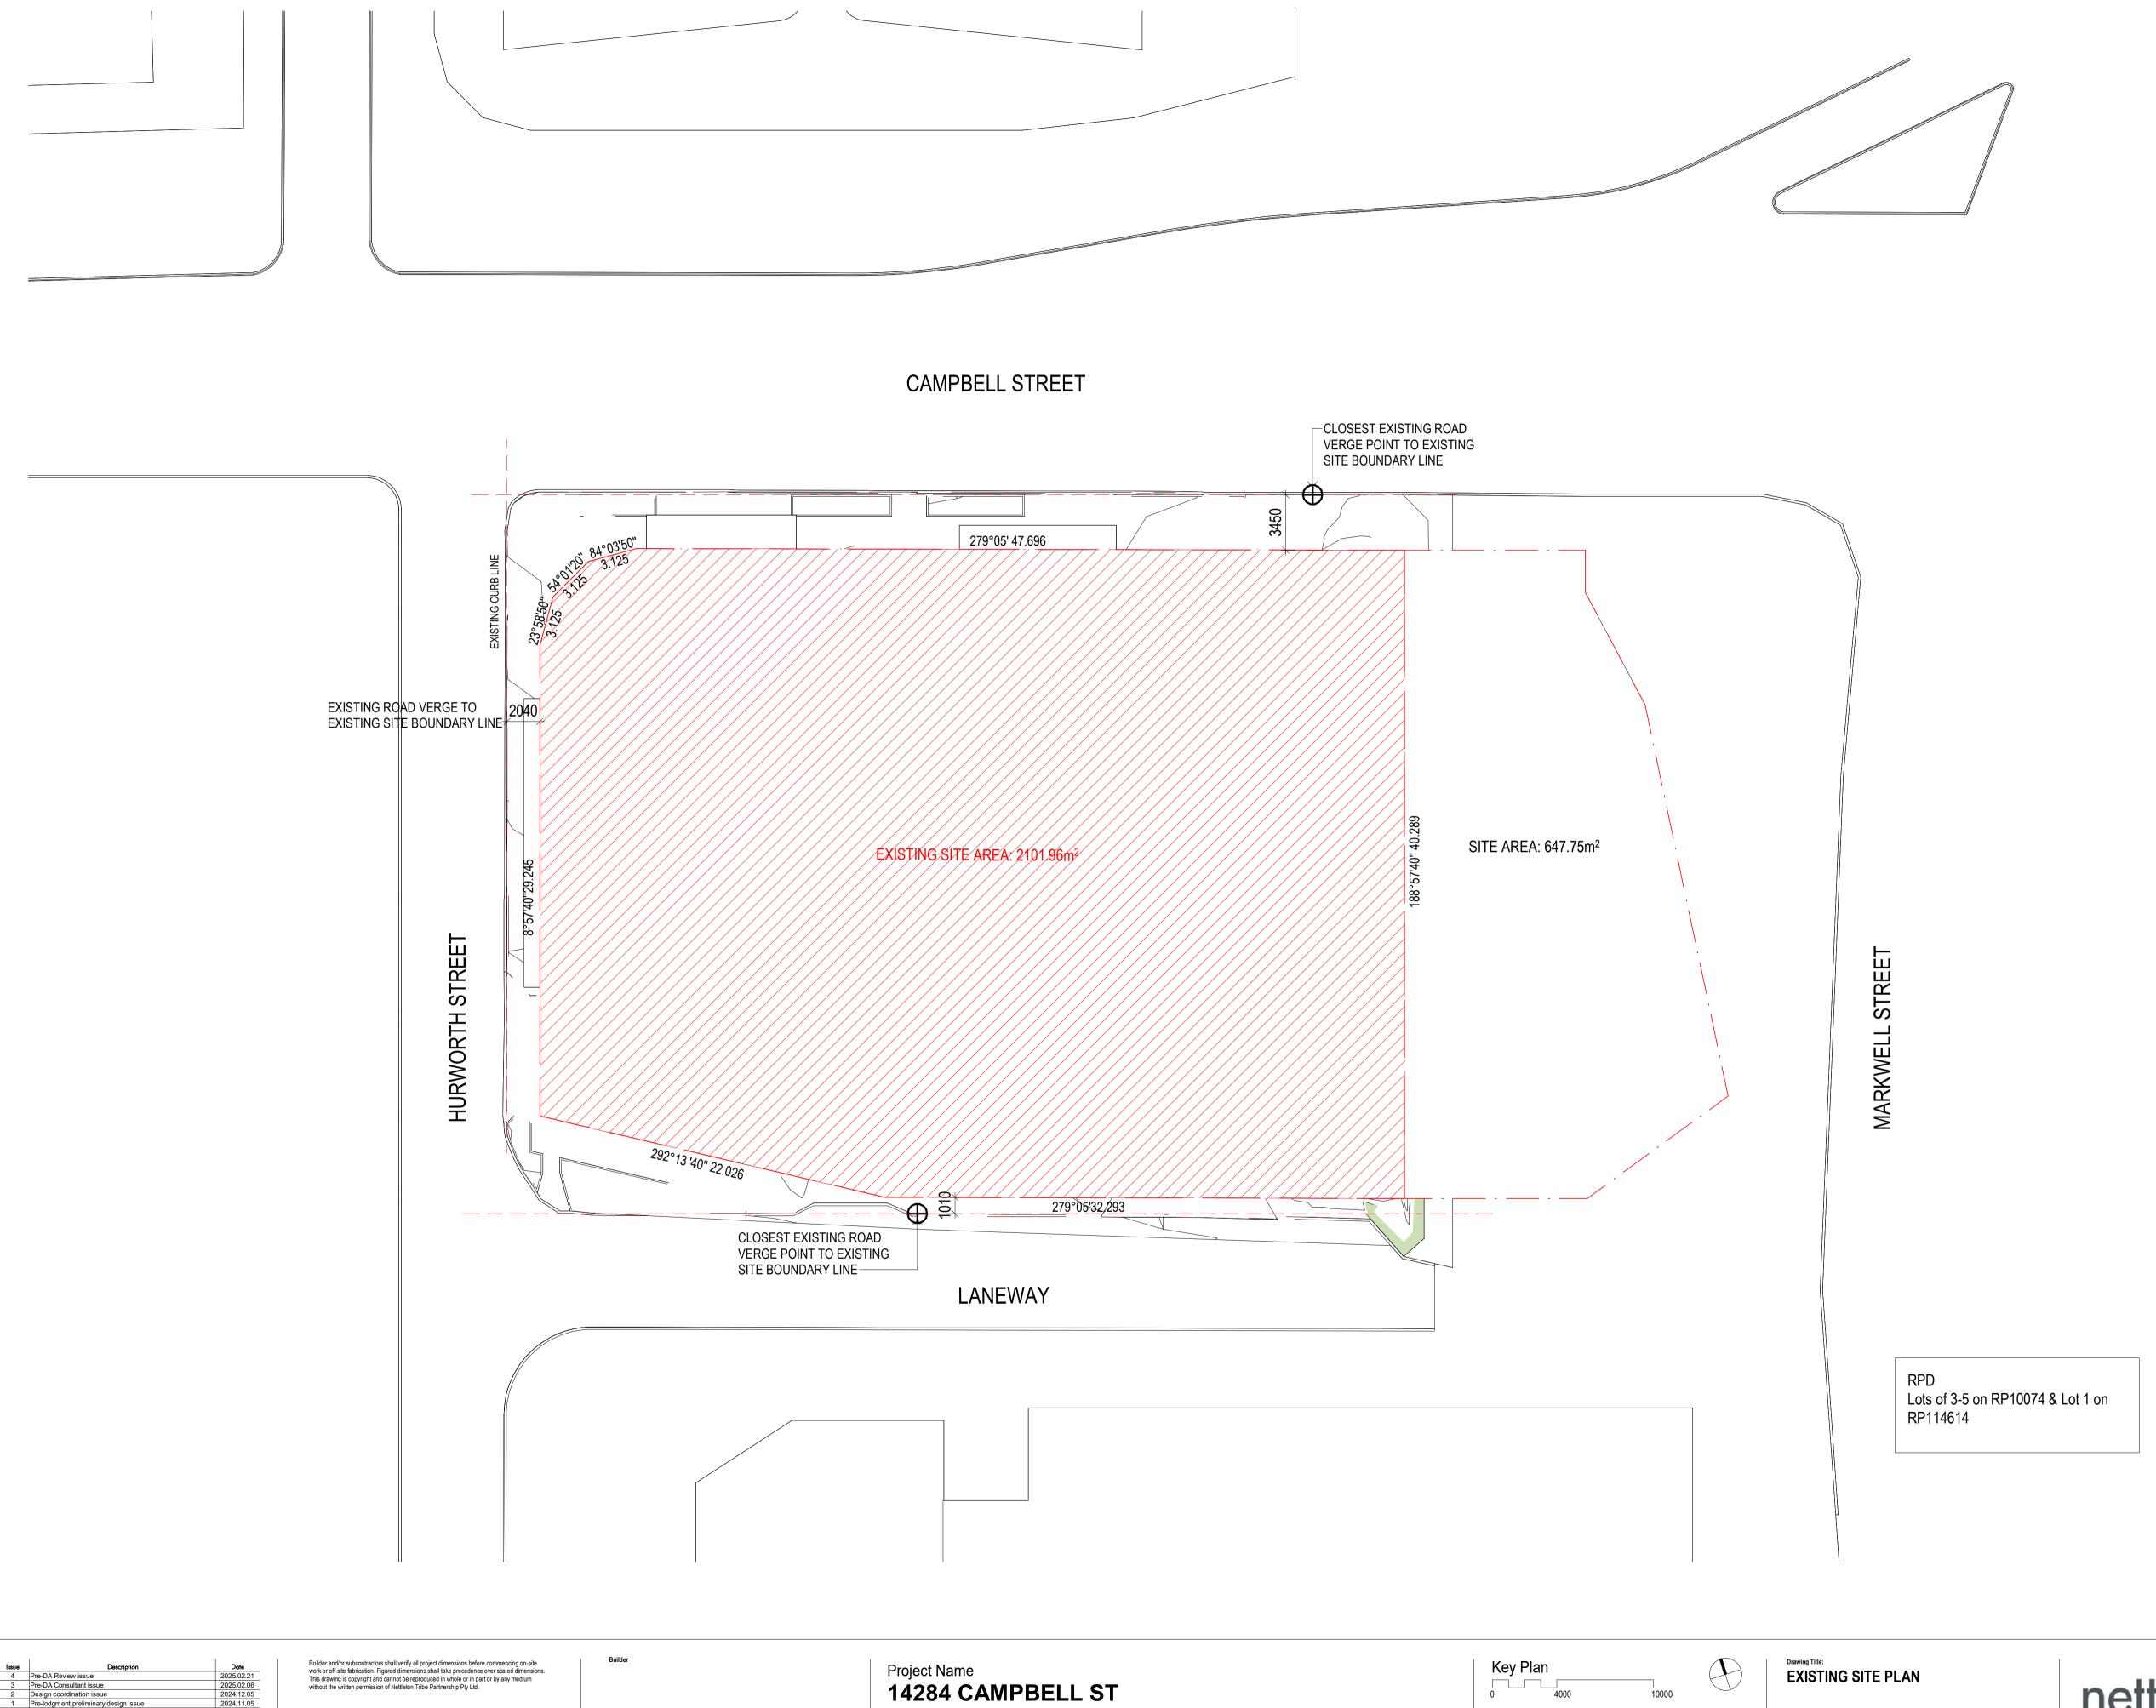



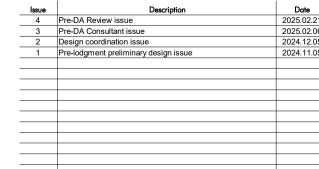

Project Address

10-16 Campbell Street, Bowen Hills







**A**1 Drawing Number: 14284\_SK01

1:200

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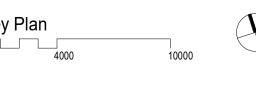


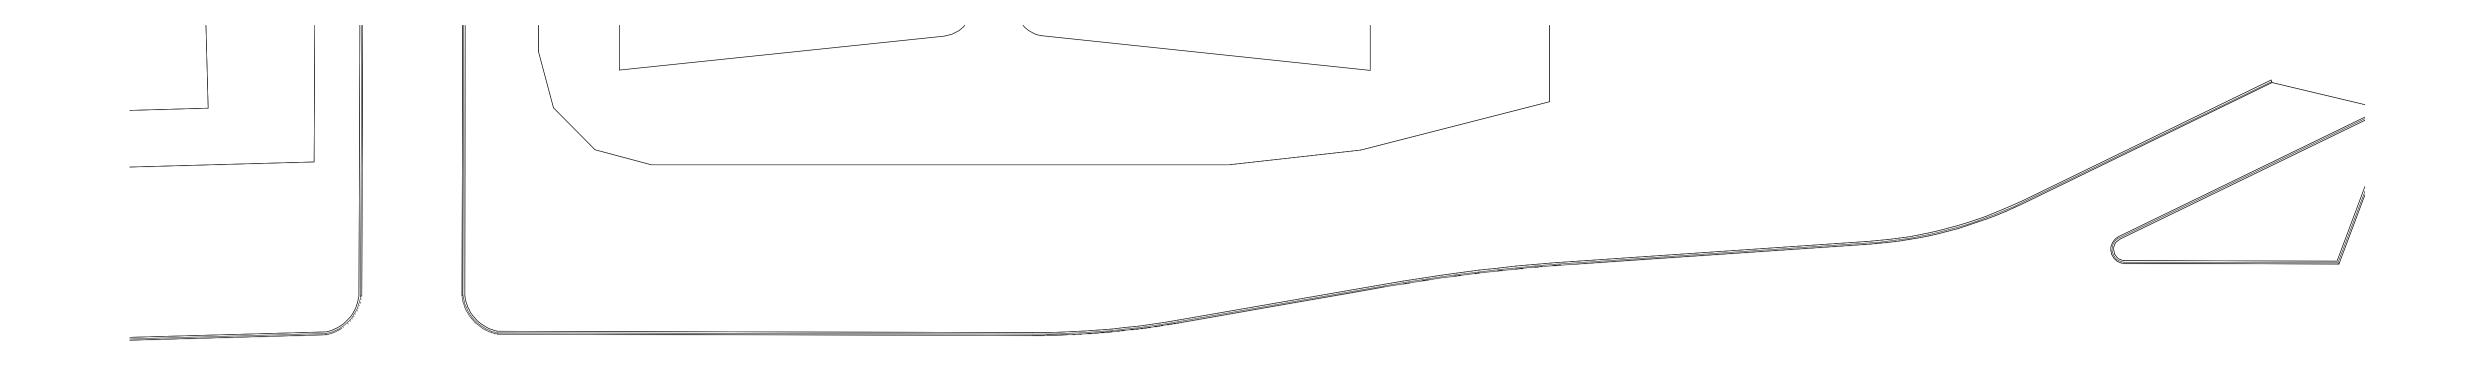

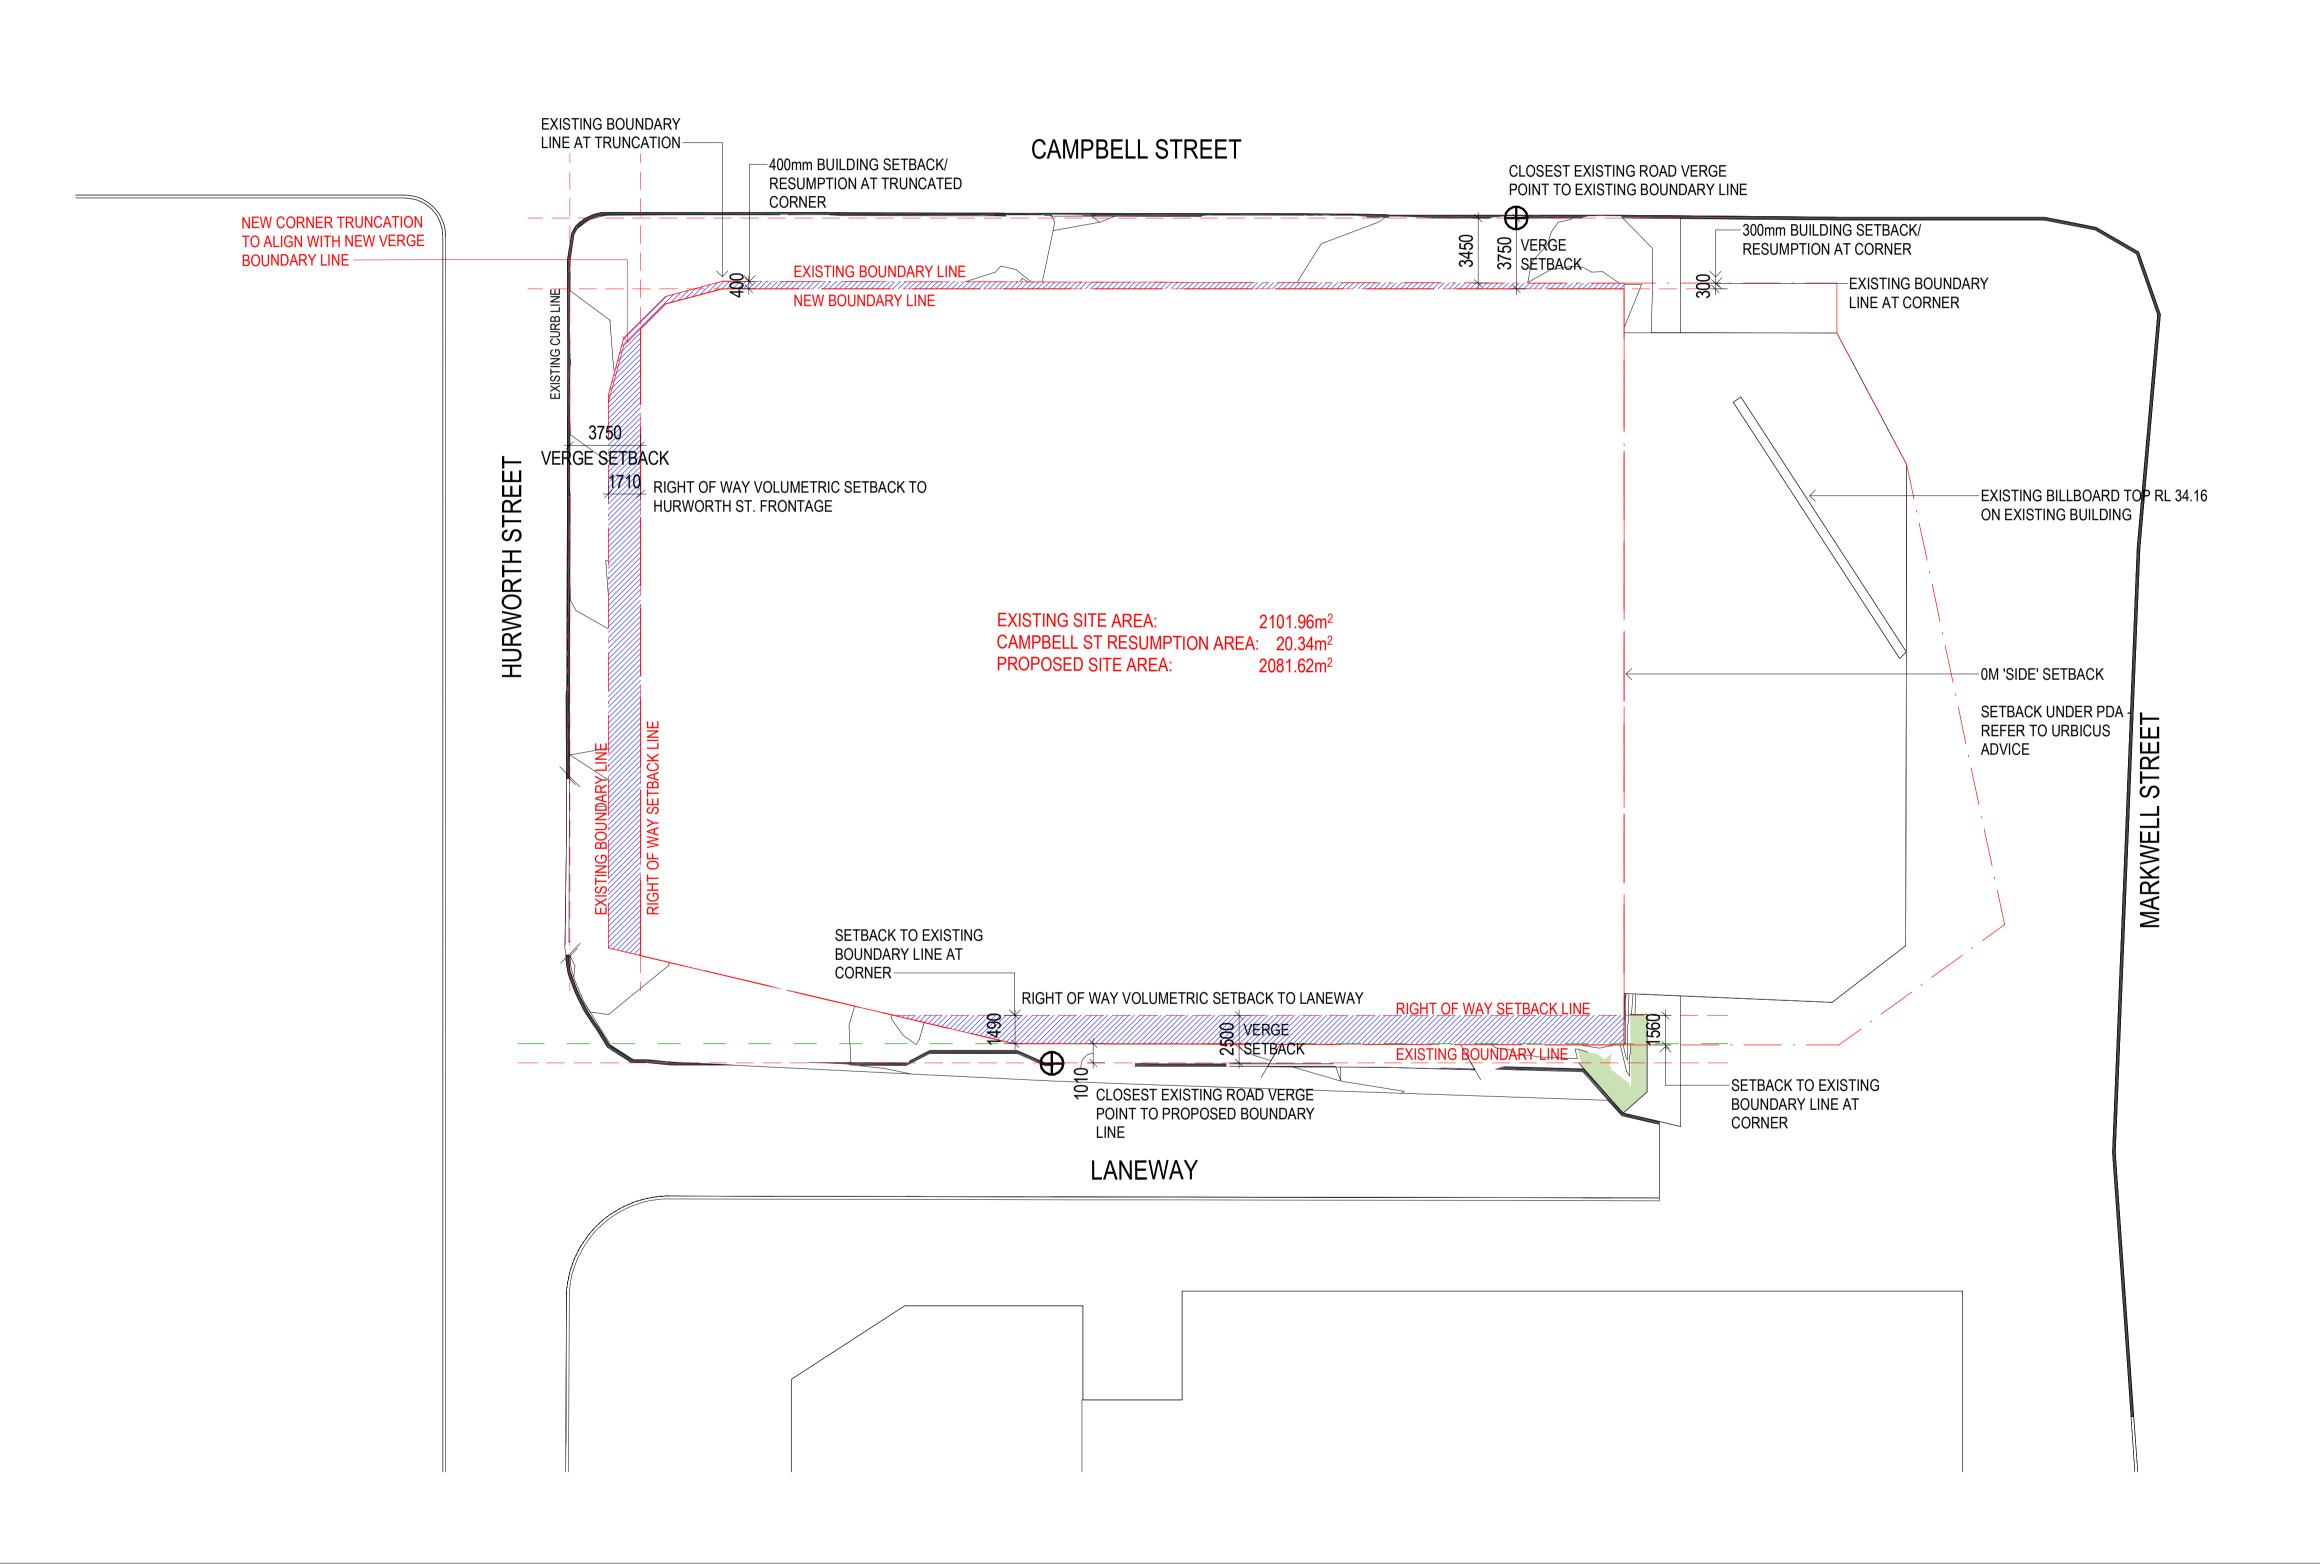

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Project Name
14284 CAMPBELL ST Project Address
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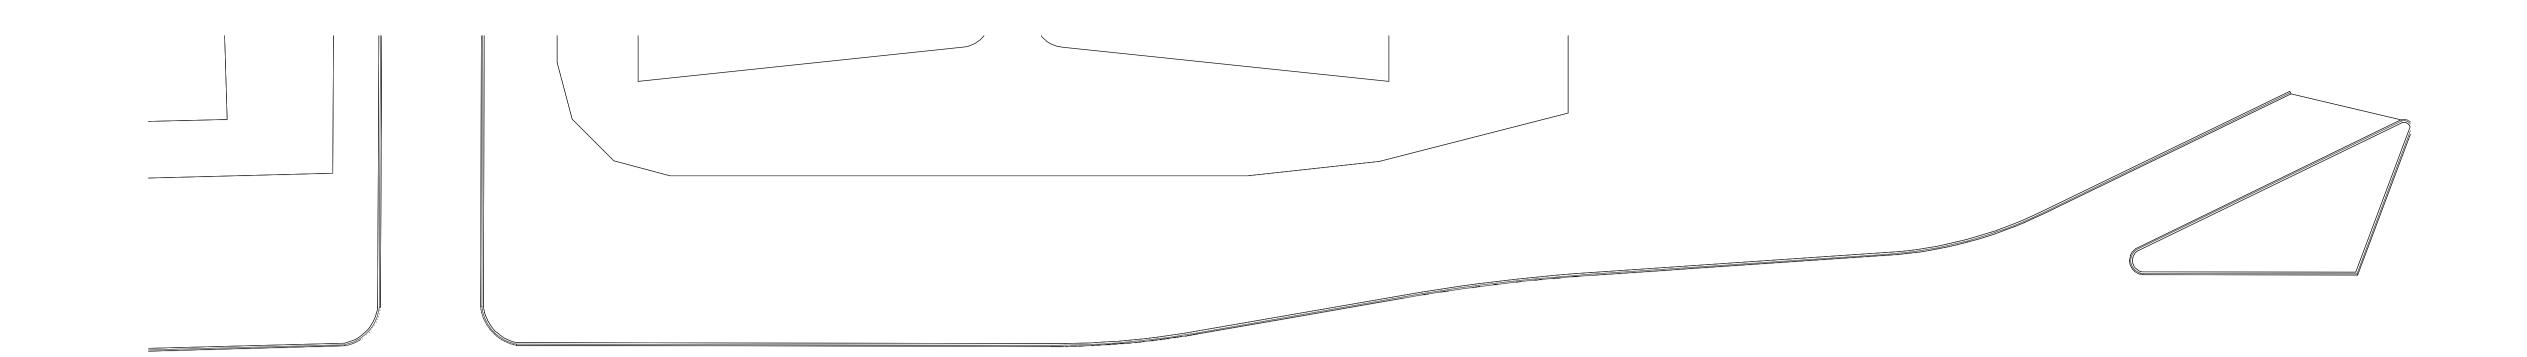



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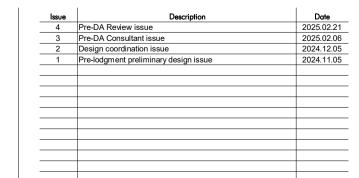
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Project Name
14284 CAMPBELL ST Project Address

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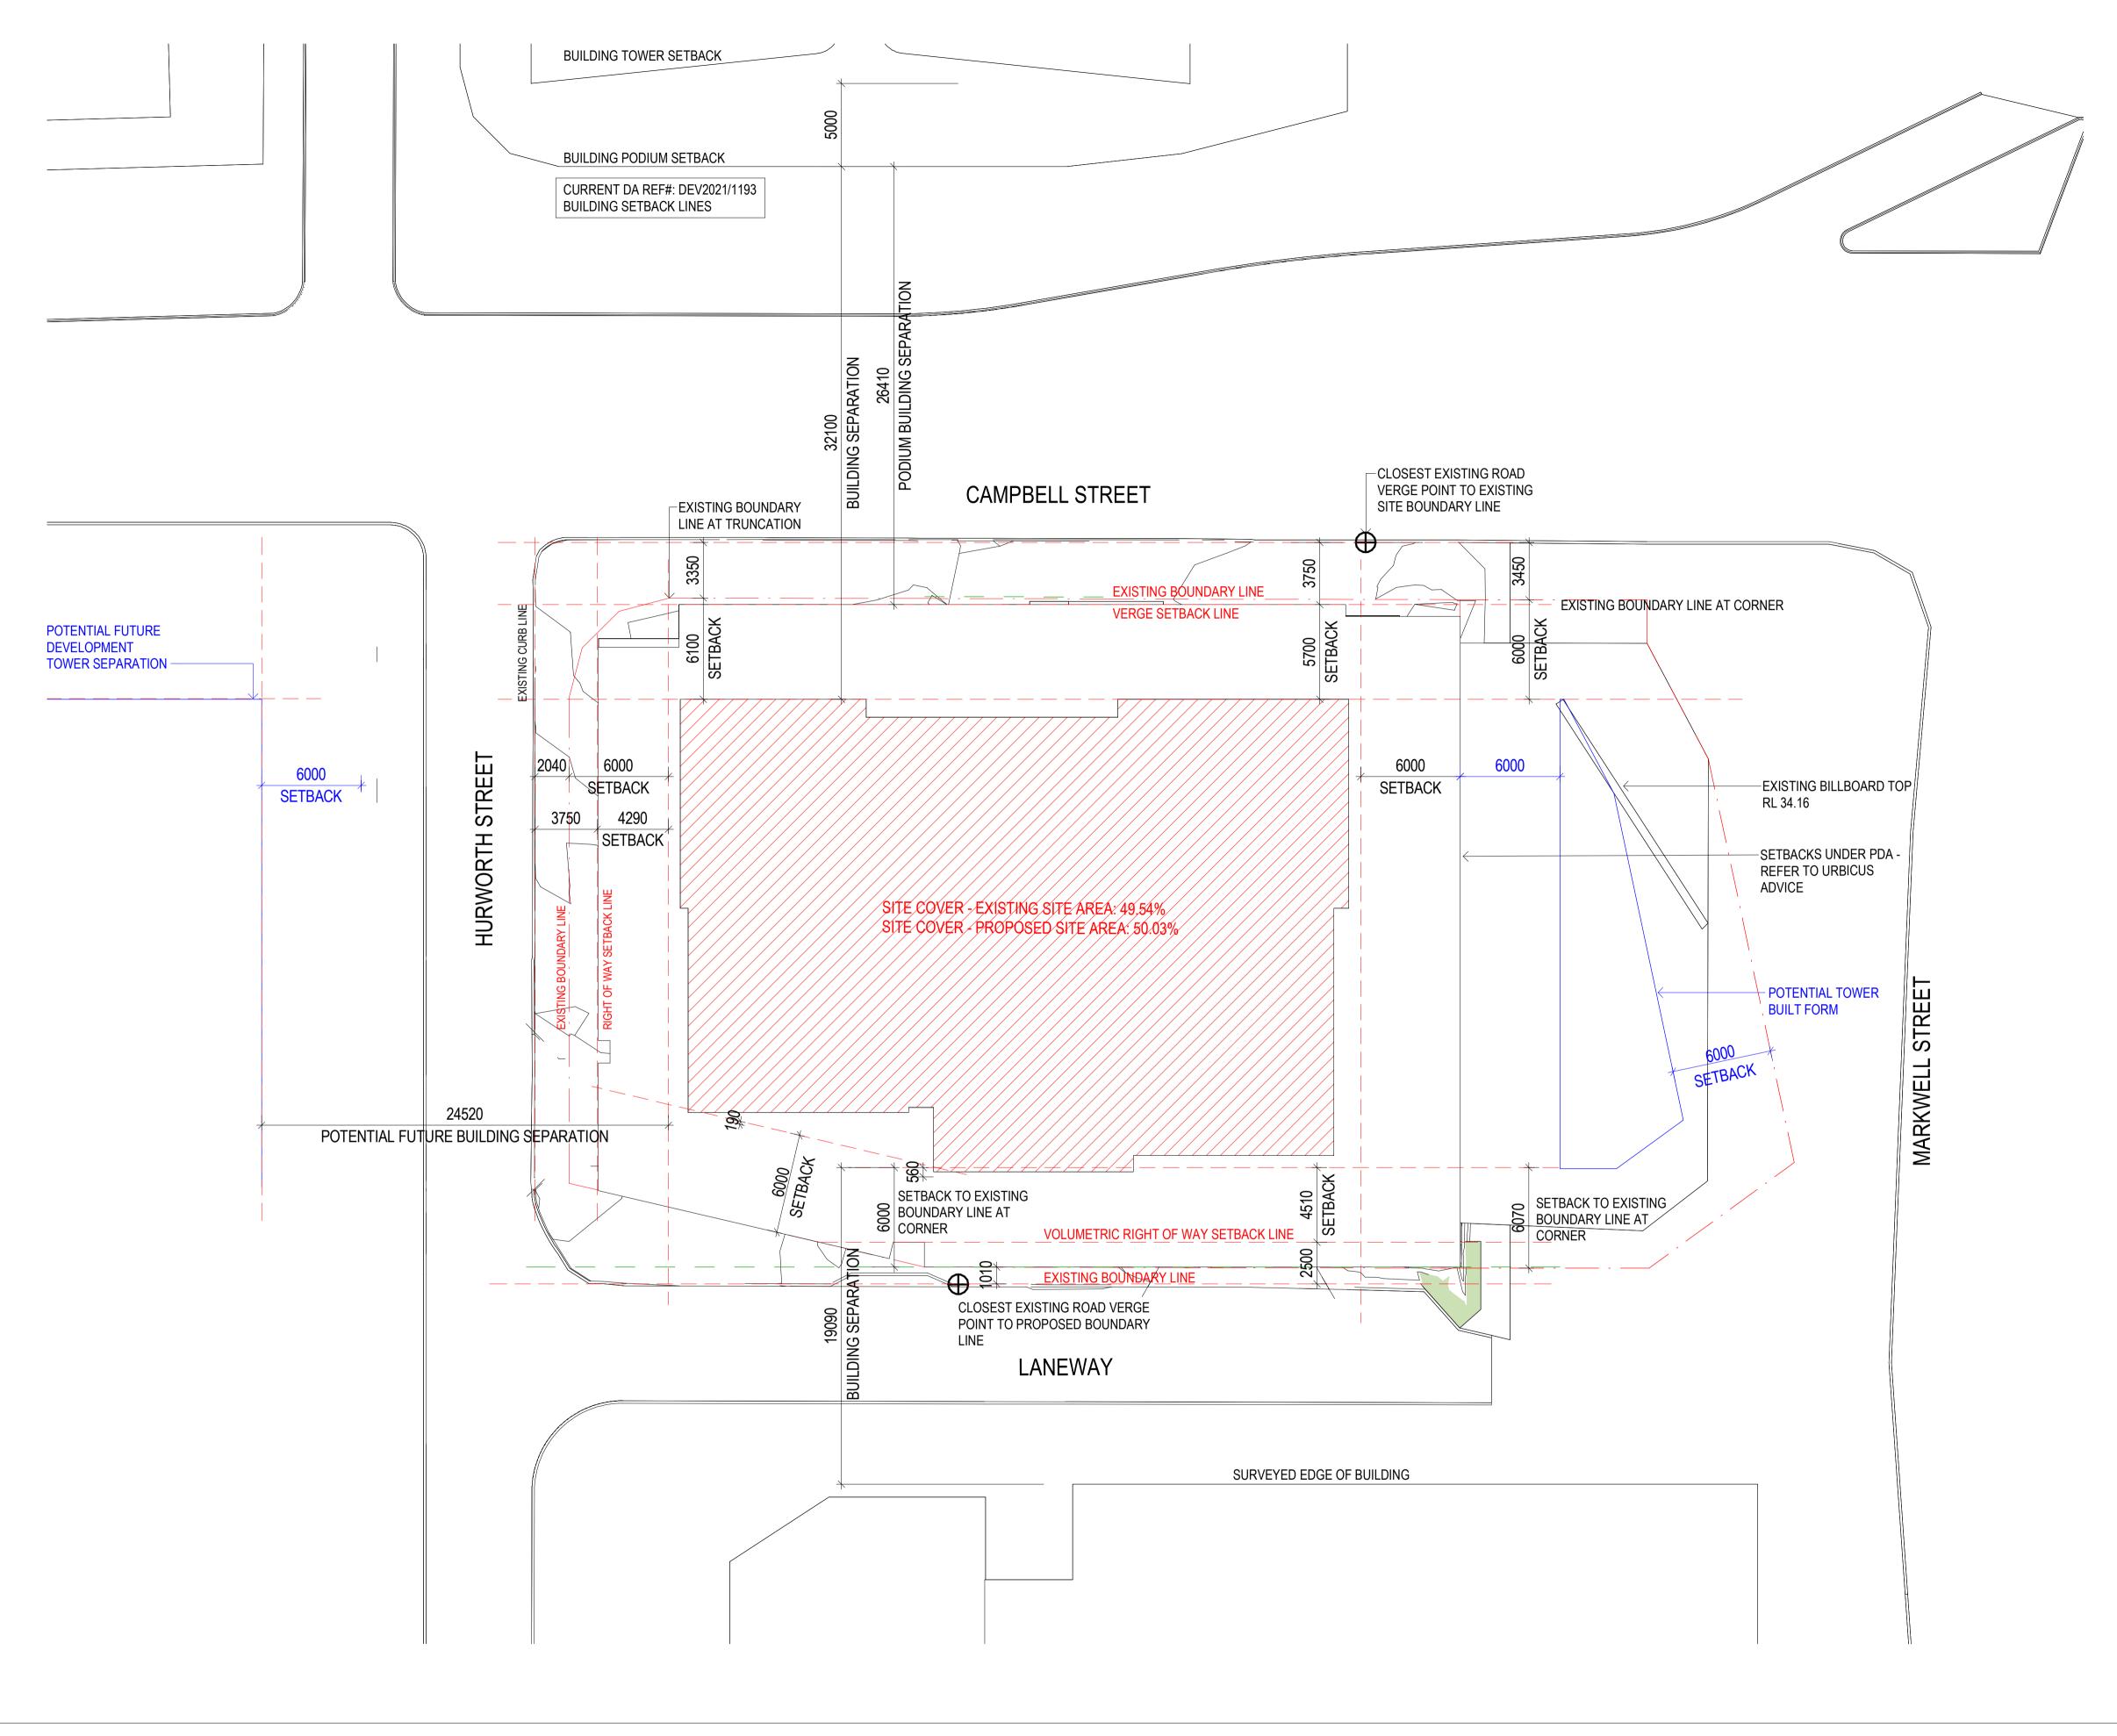
PROPOSED SITE PLAN - PROPOSED BOUNDARY PLAN (PODIUM LVLS 1-3)

NETTER OF THE PLAN - PROPOSED BOUNDARY PLAN (PODIUM LVLS 1-3)


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e: brisbane@nettletontribe.com.au w: nettletontribe.com.au



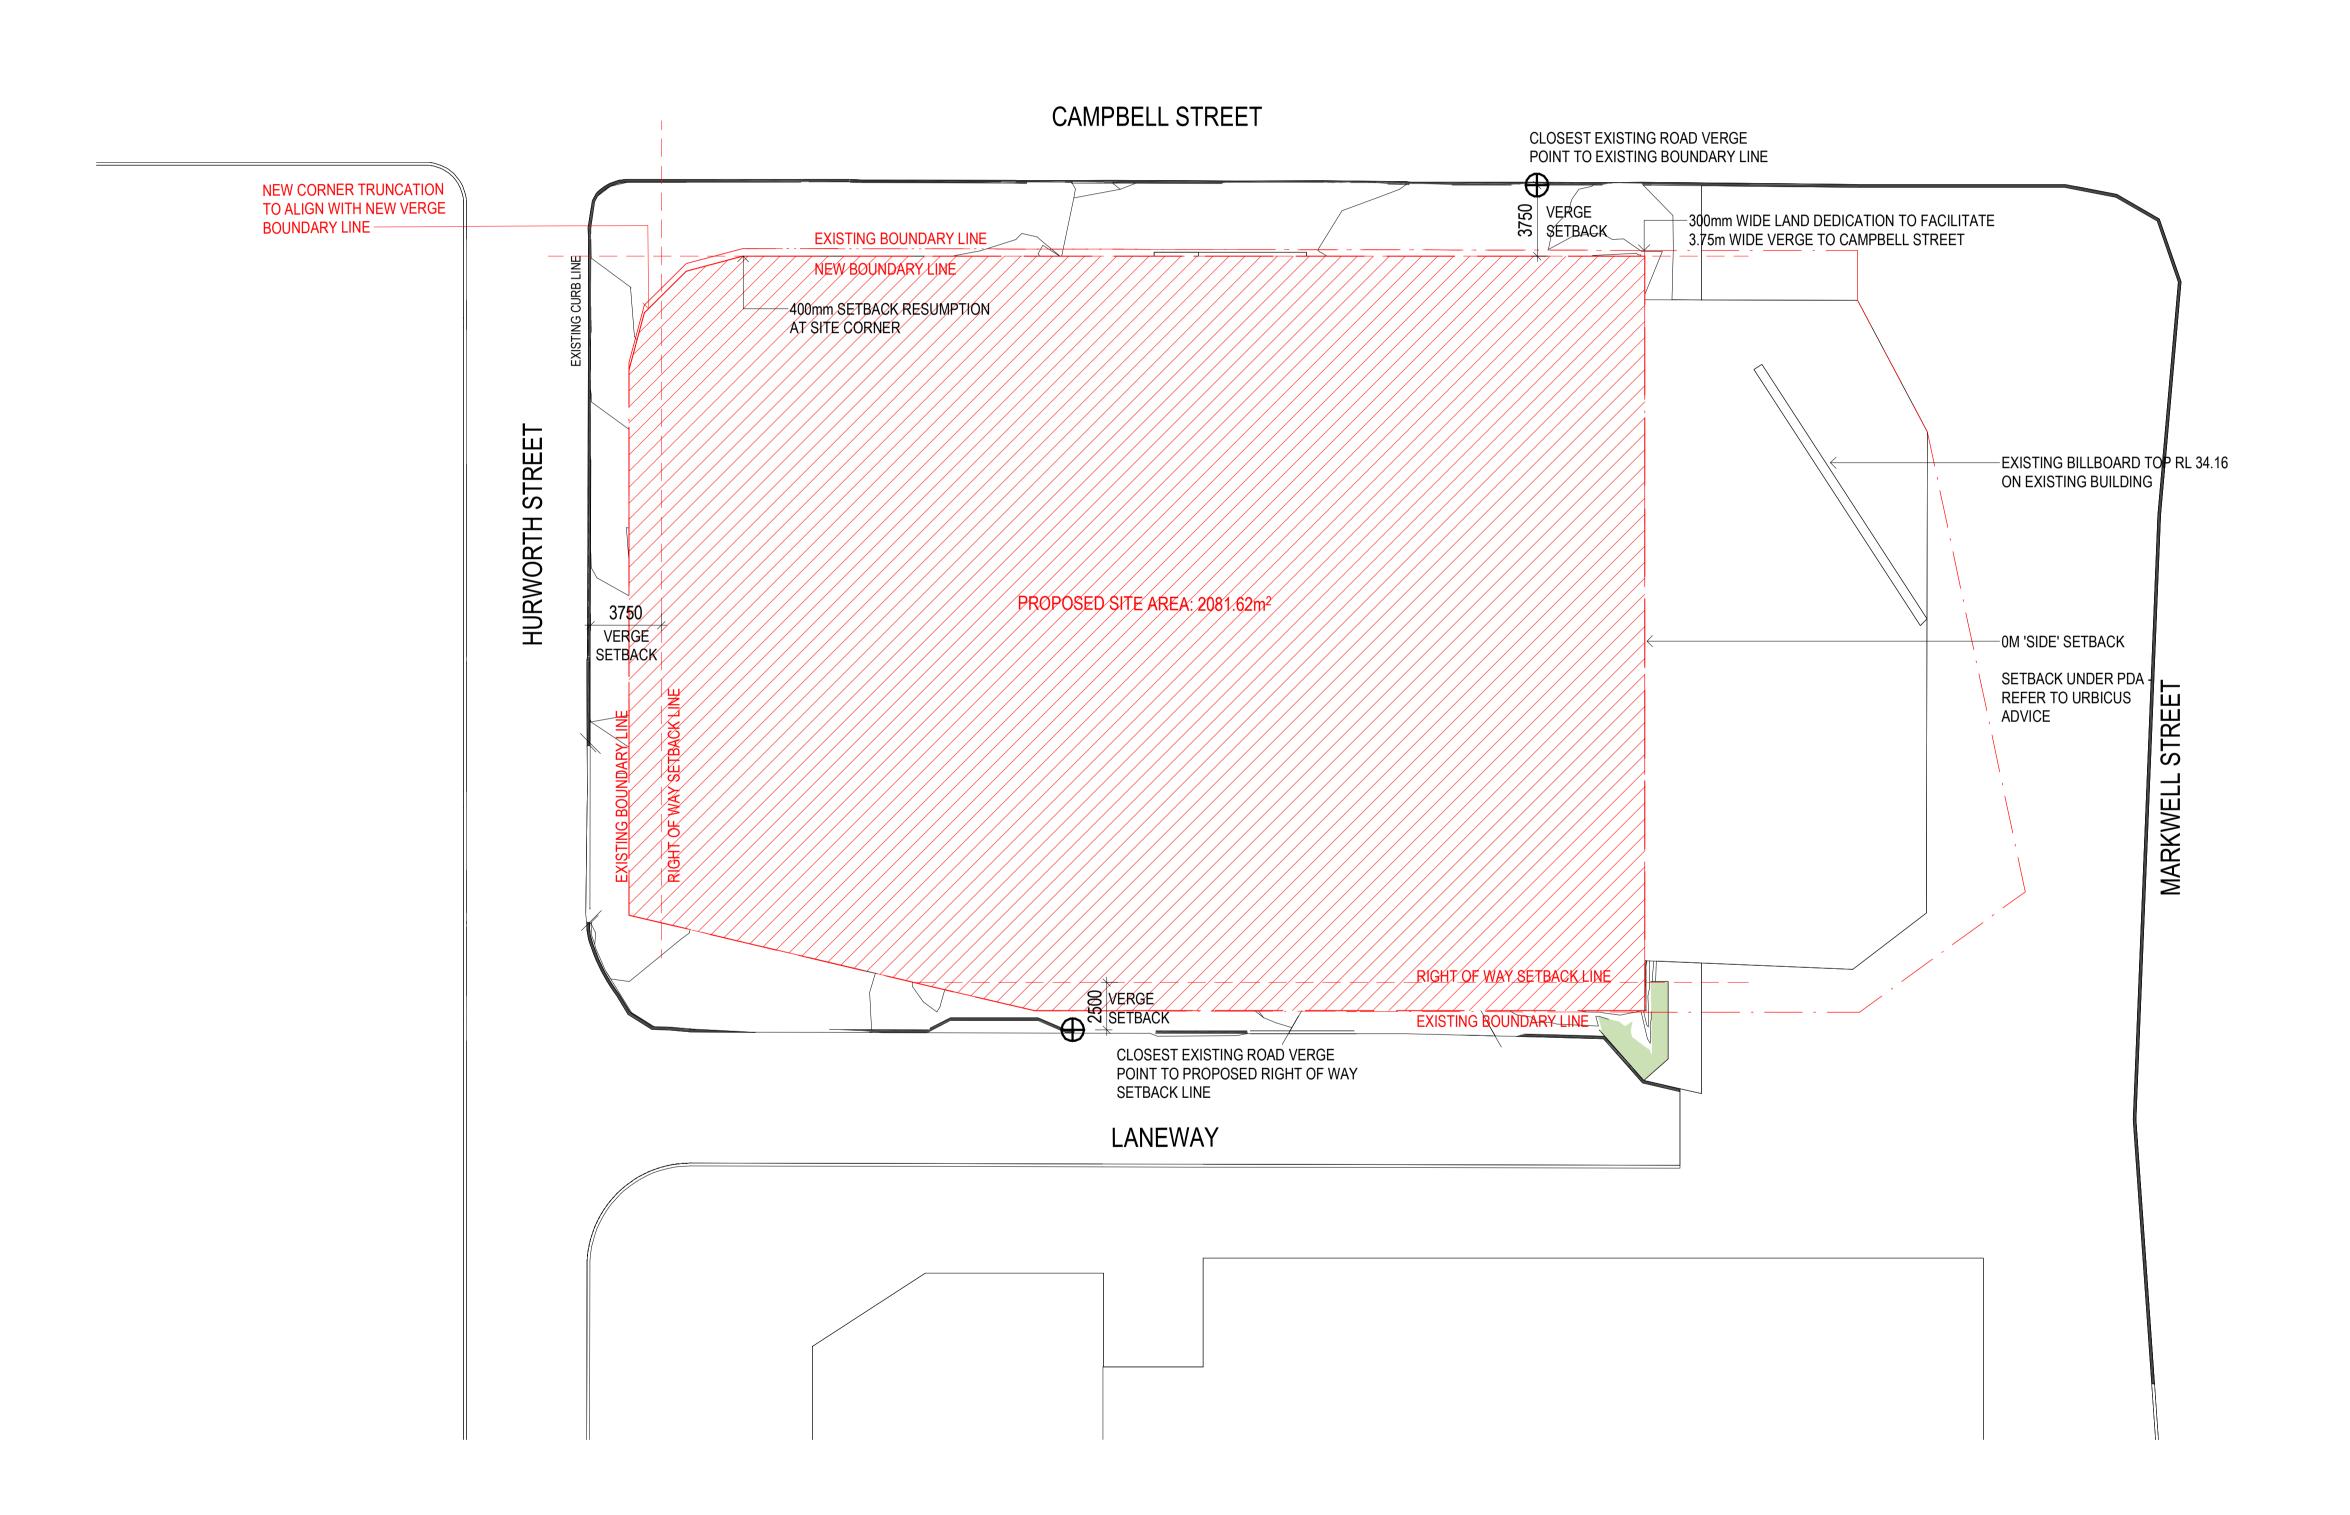



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SITE CONSTRAINTS PLAN - PROPOSED TO WER LEVELS (LEVELS 4-26)

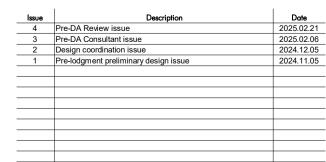
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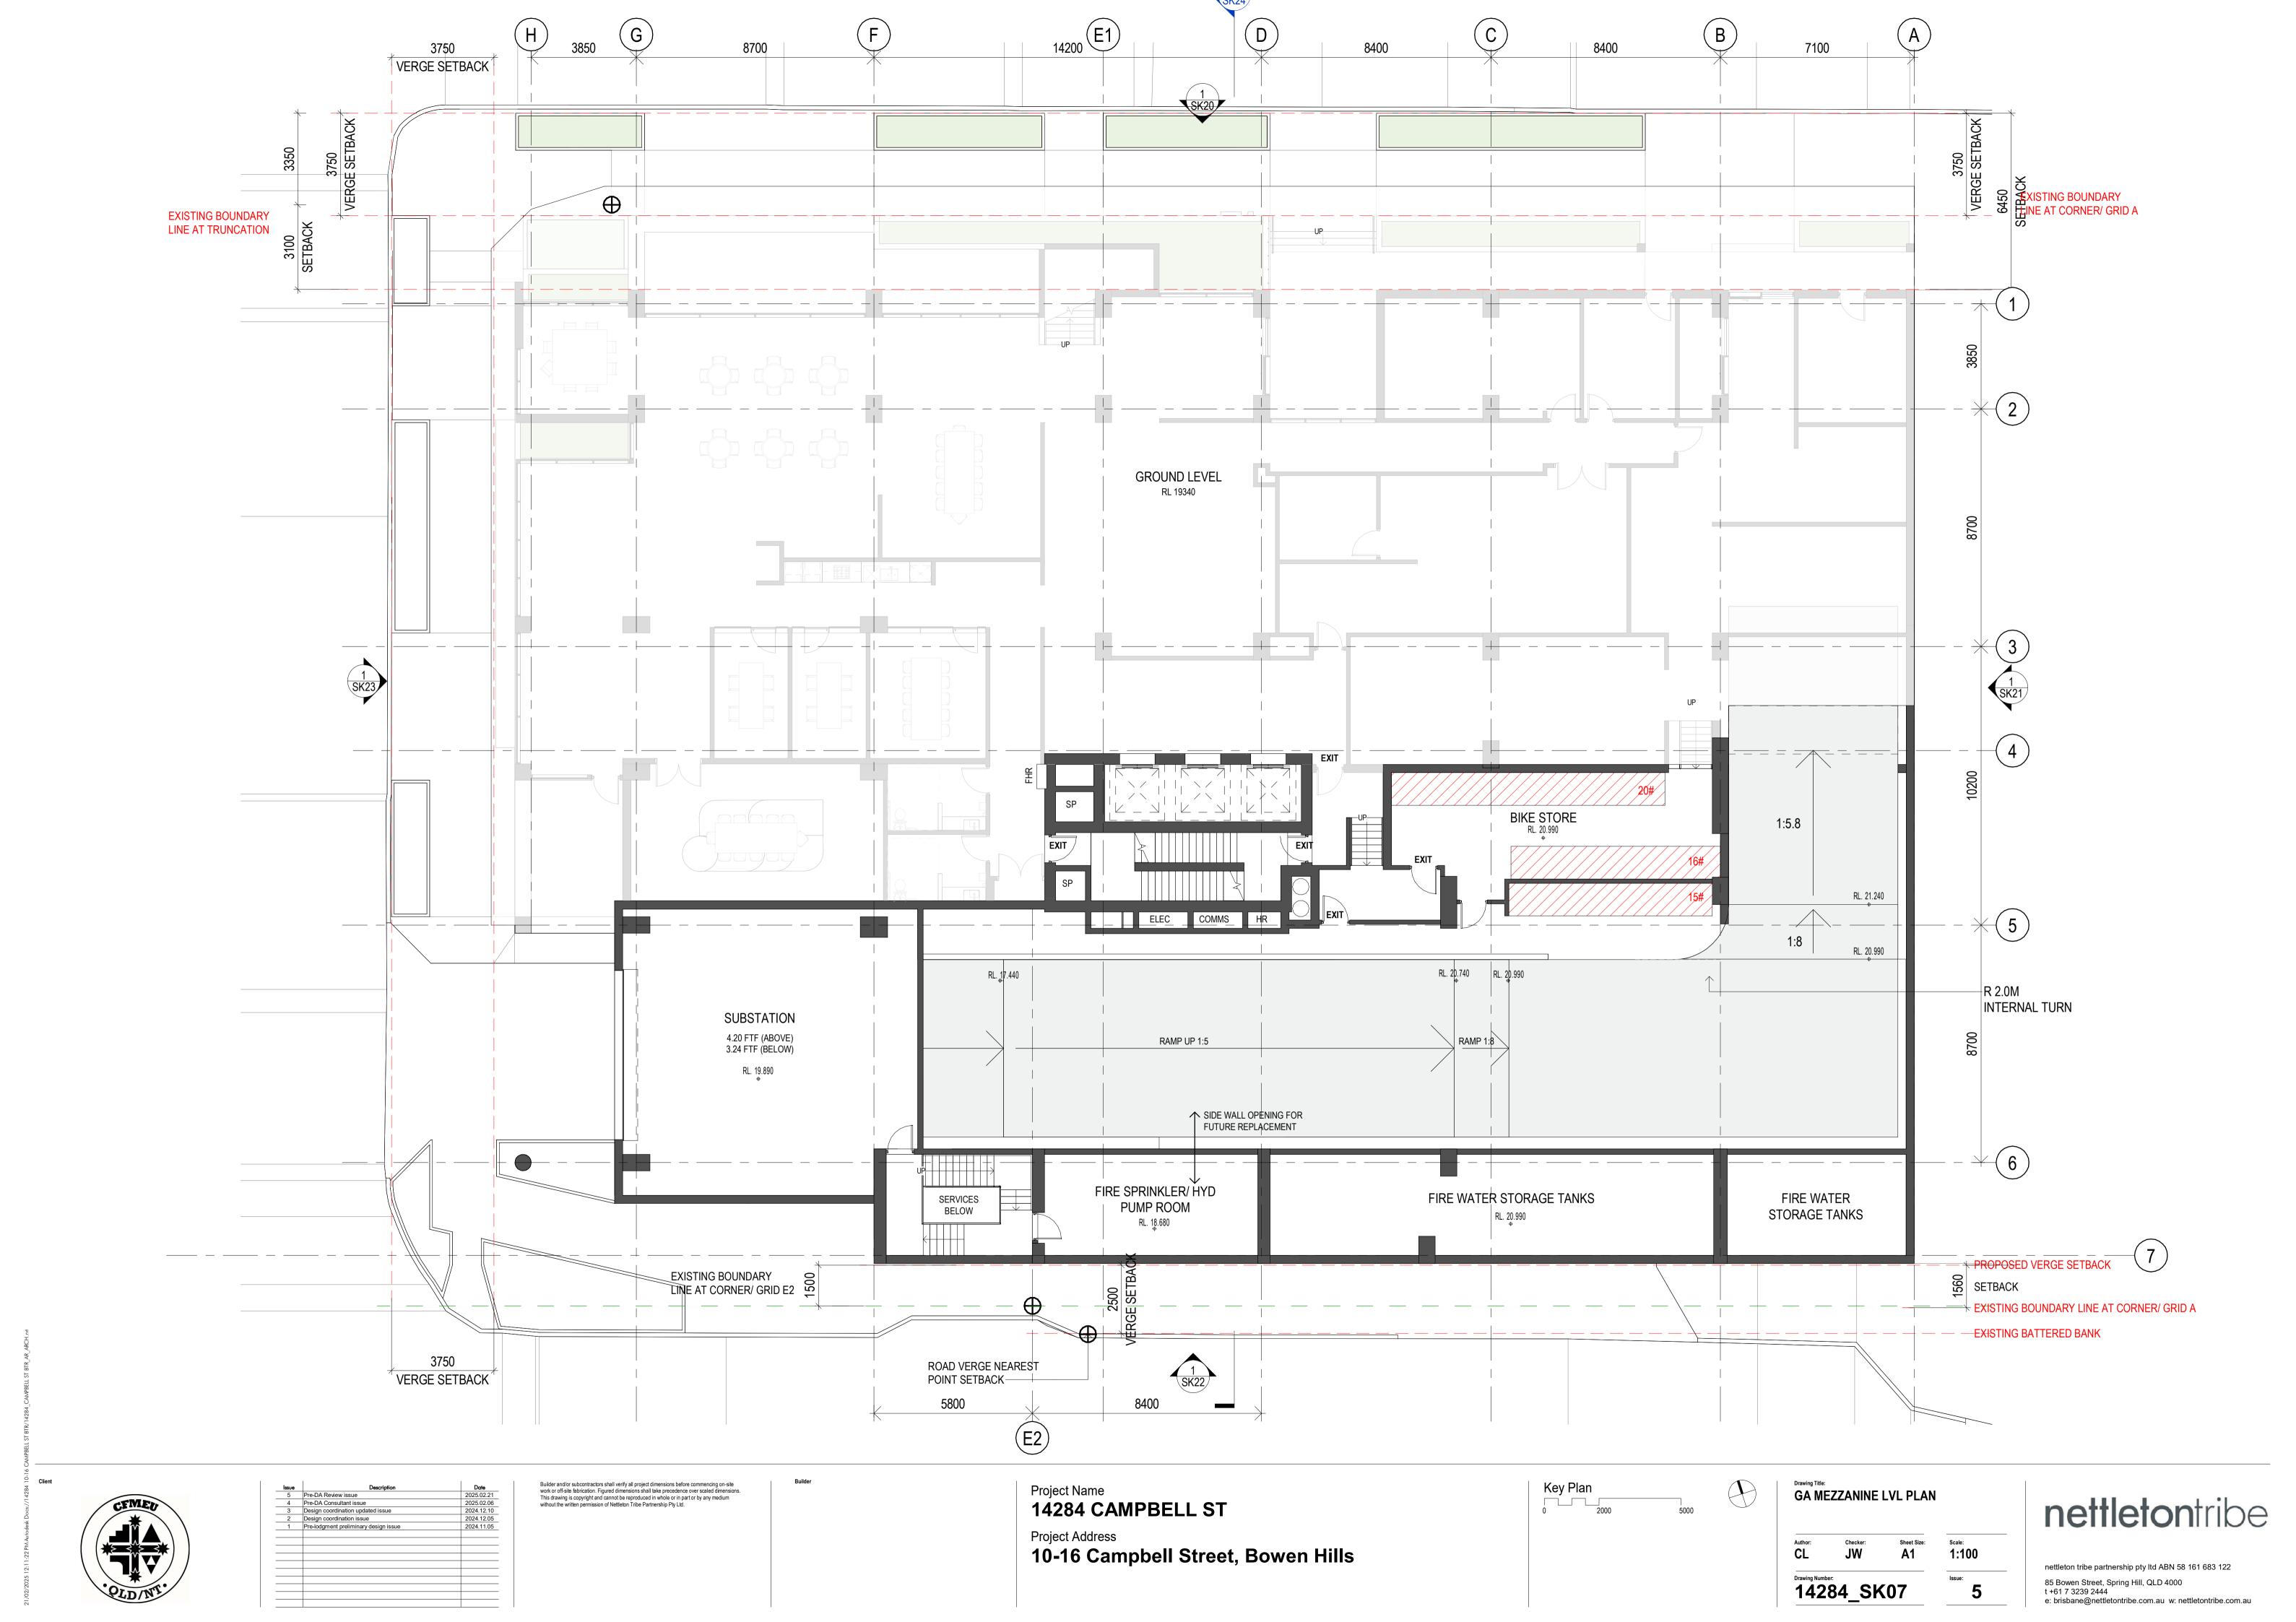
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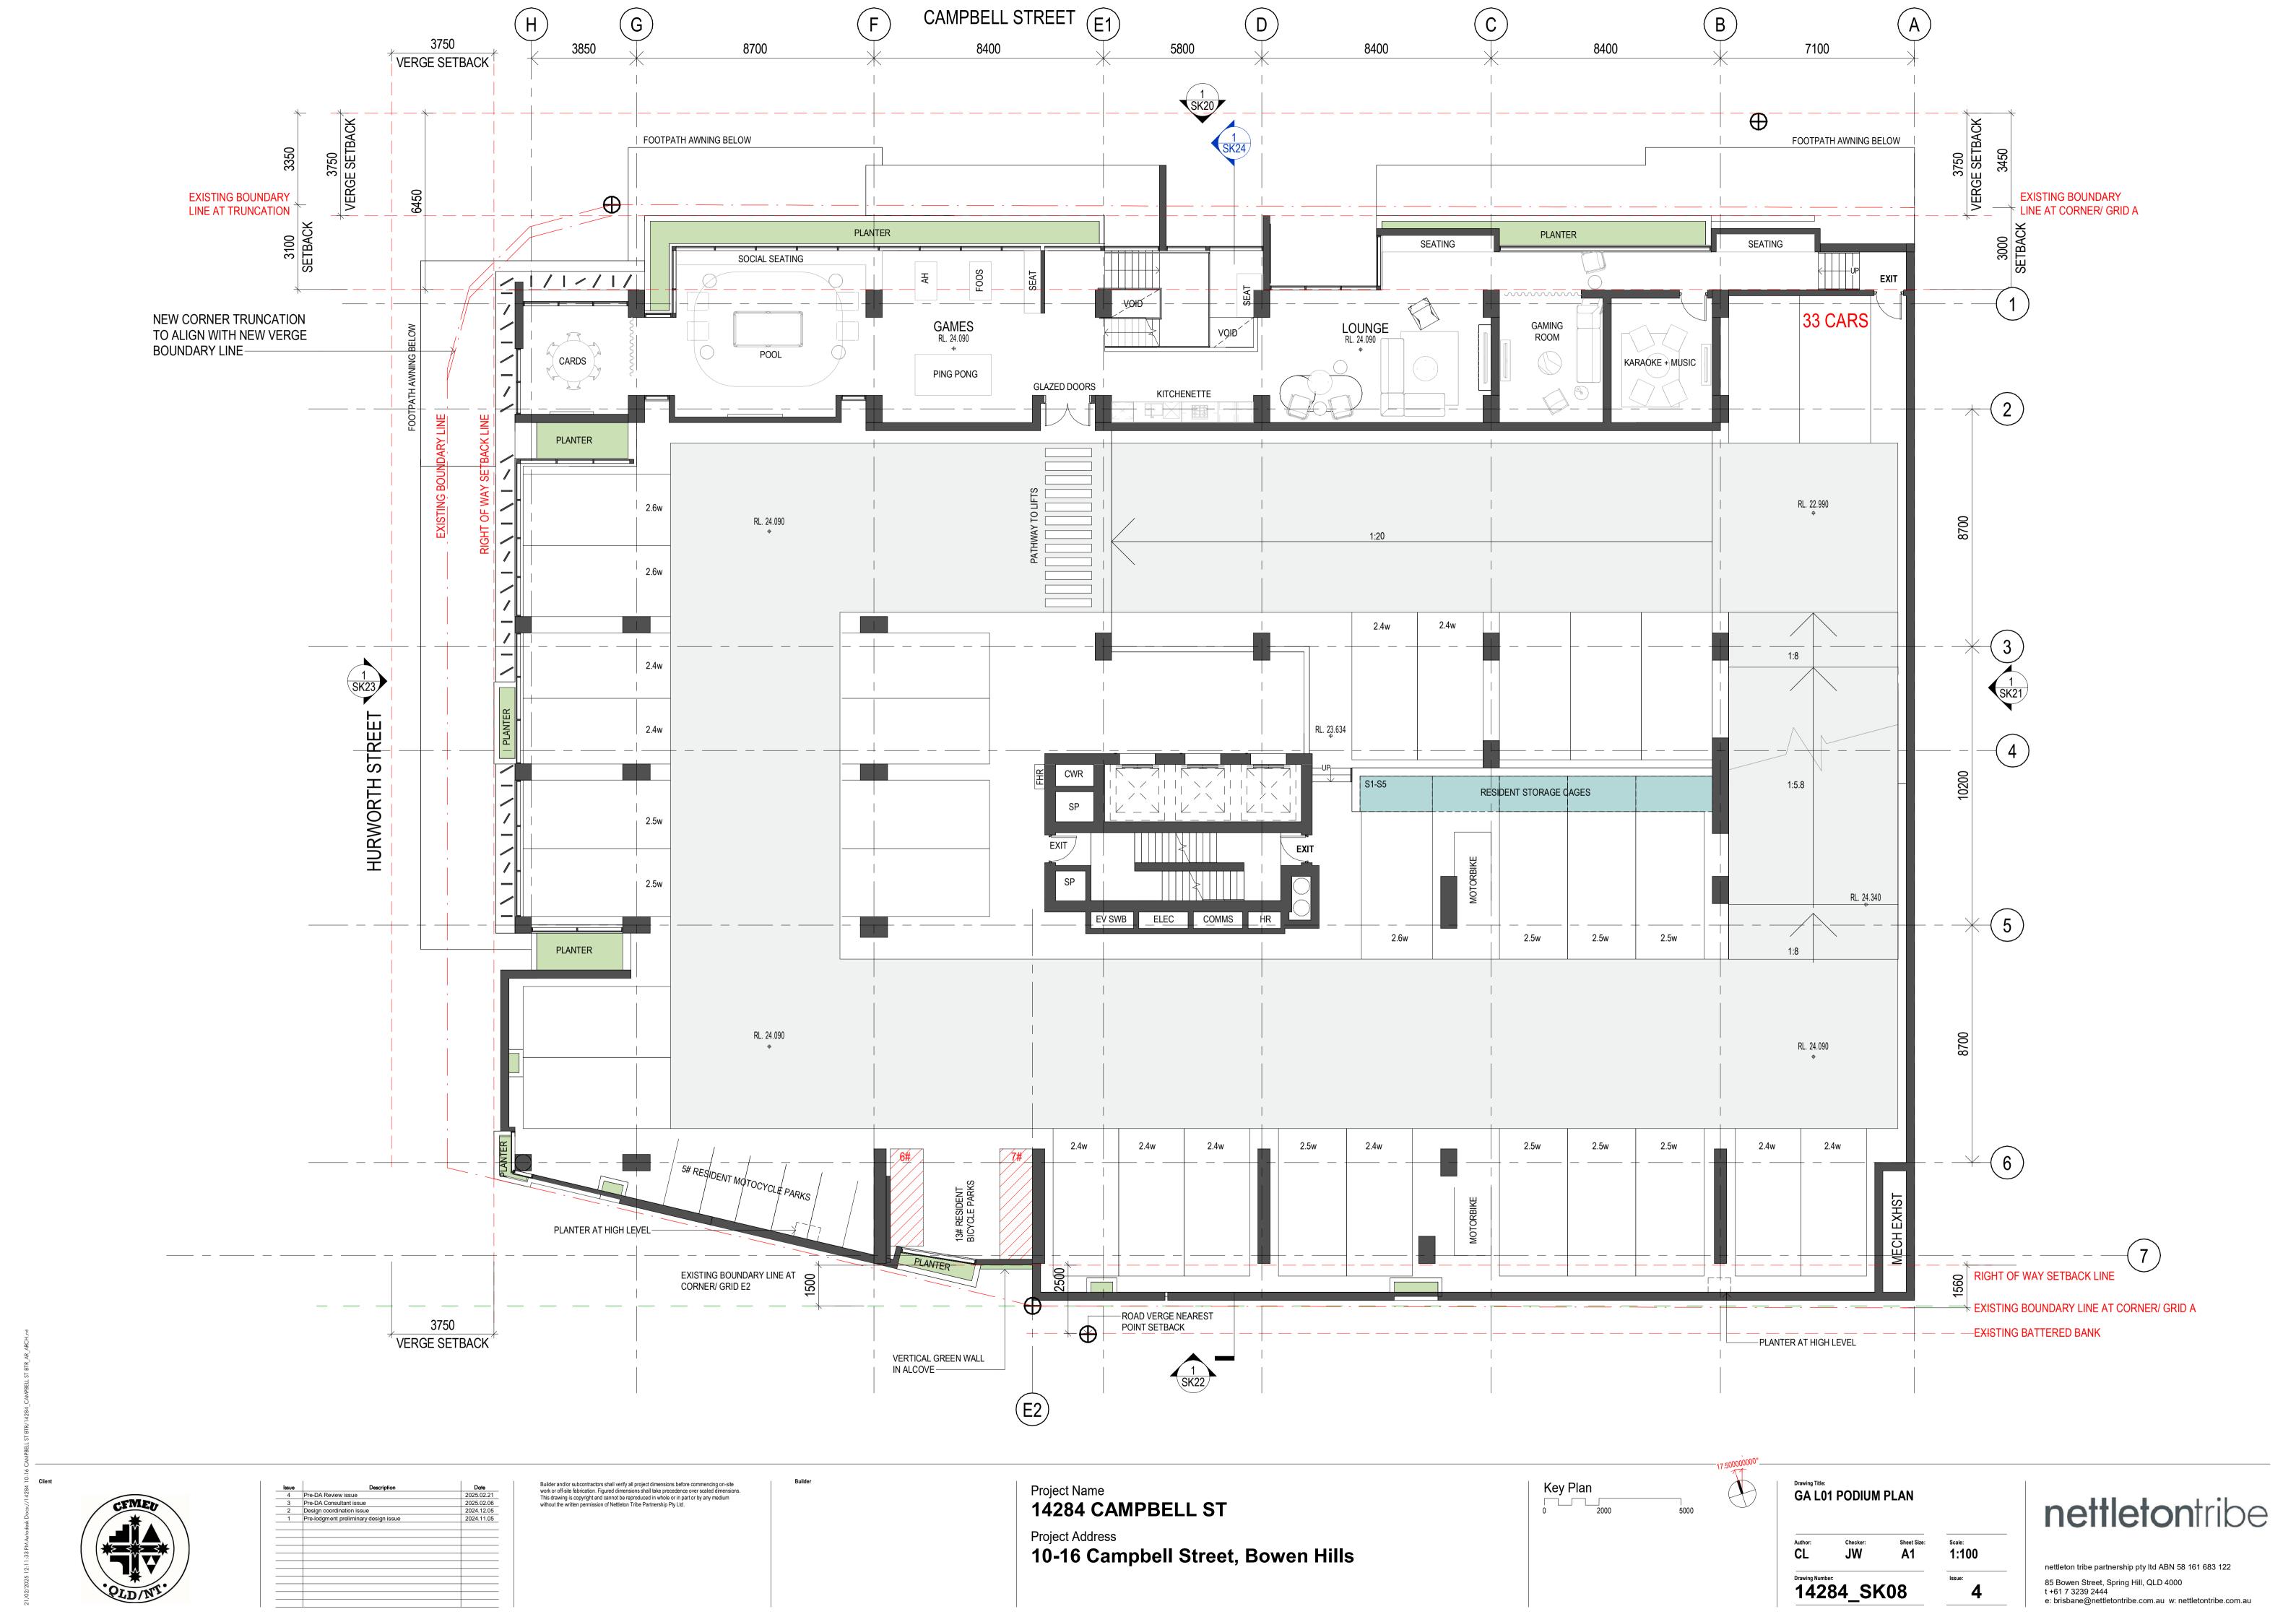
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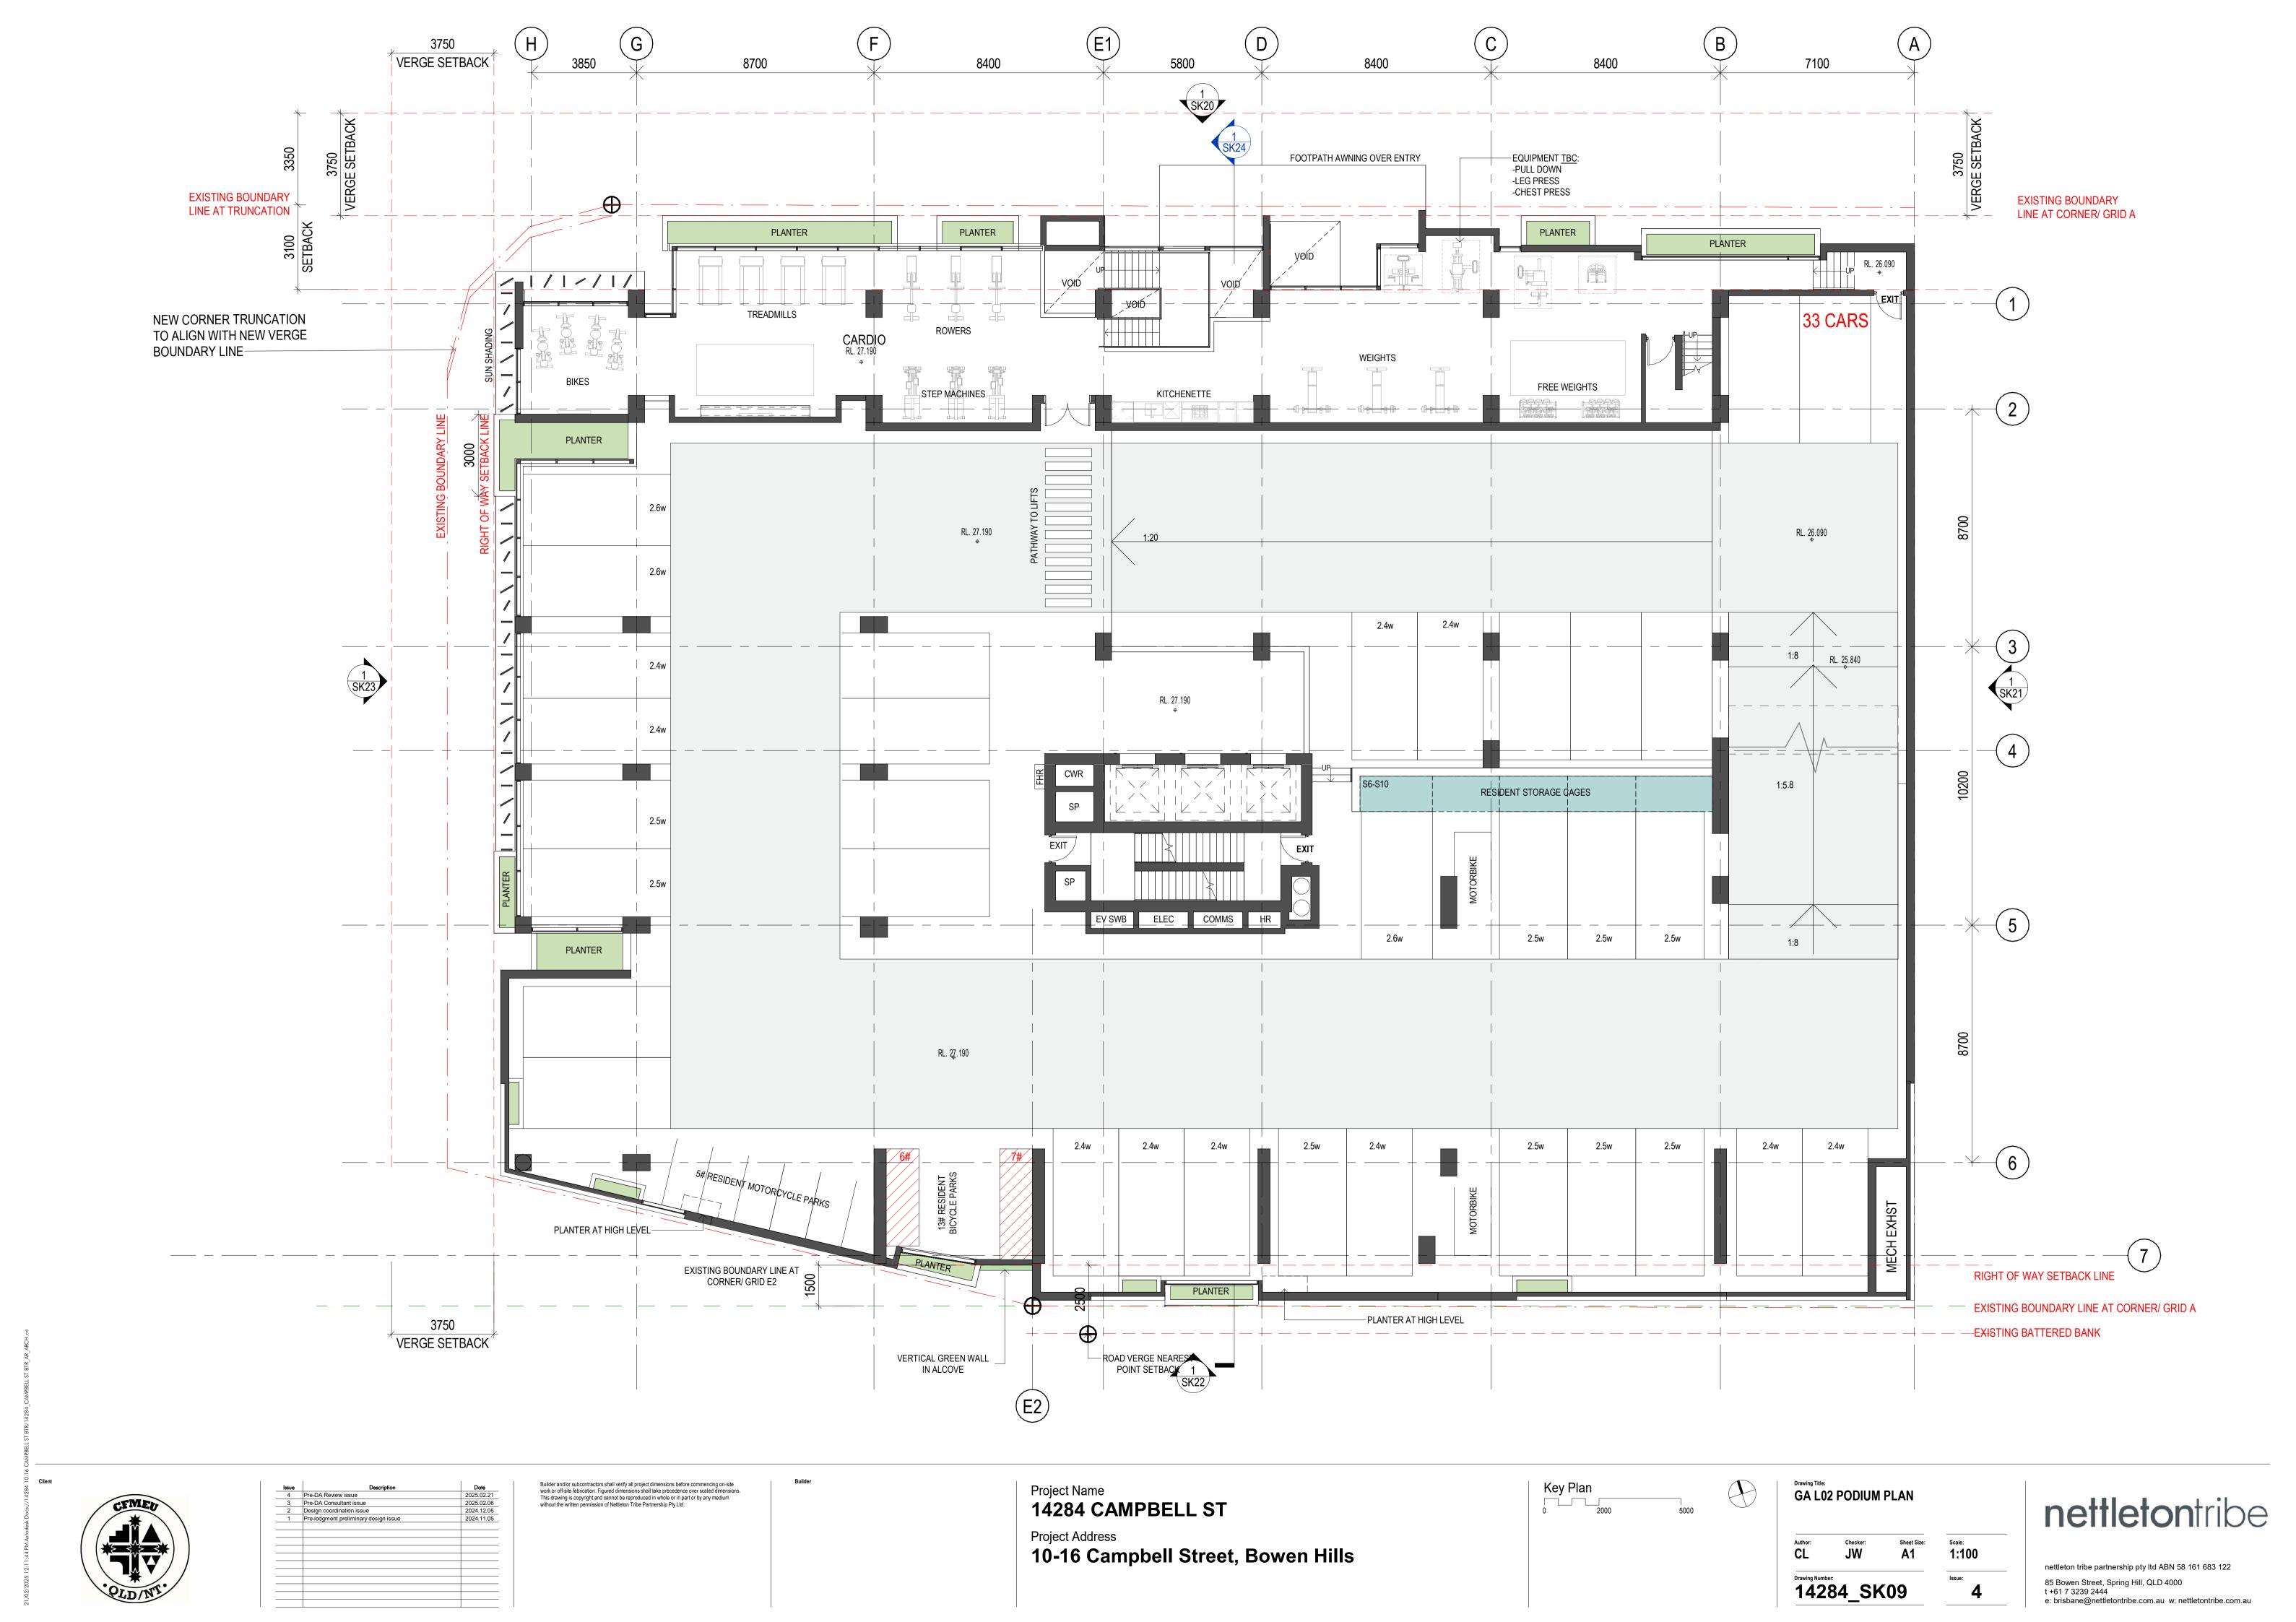
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14284\_SK10





 Issue
 Description

 5
 DA Issue

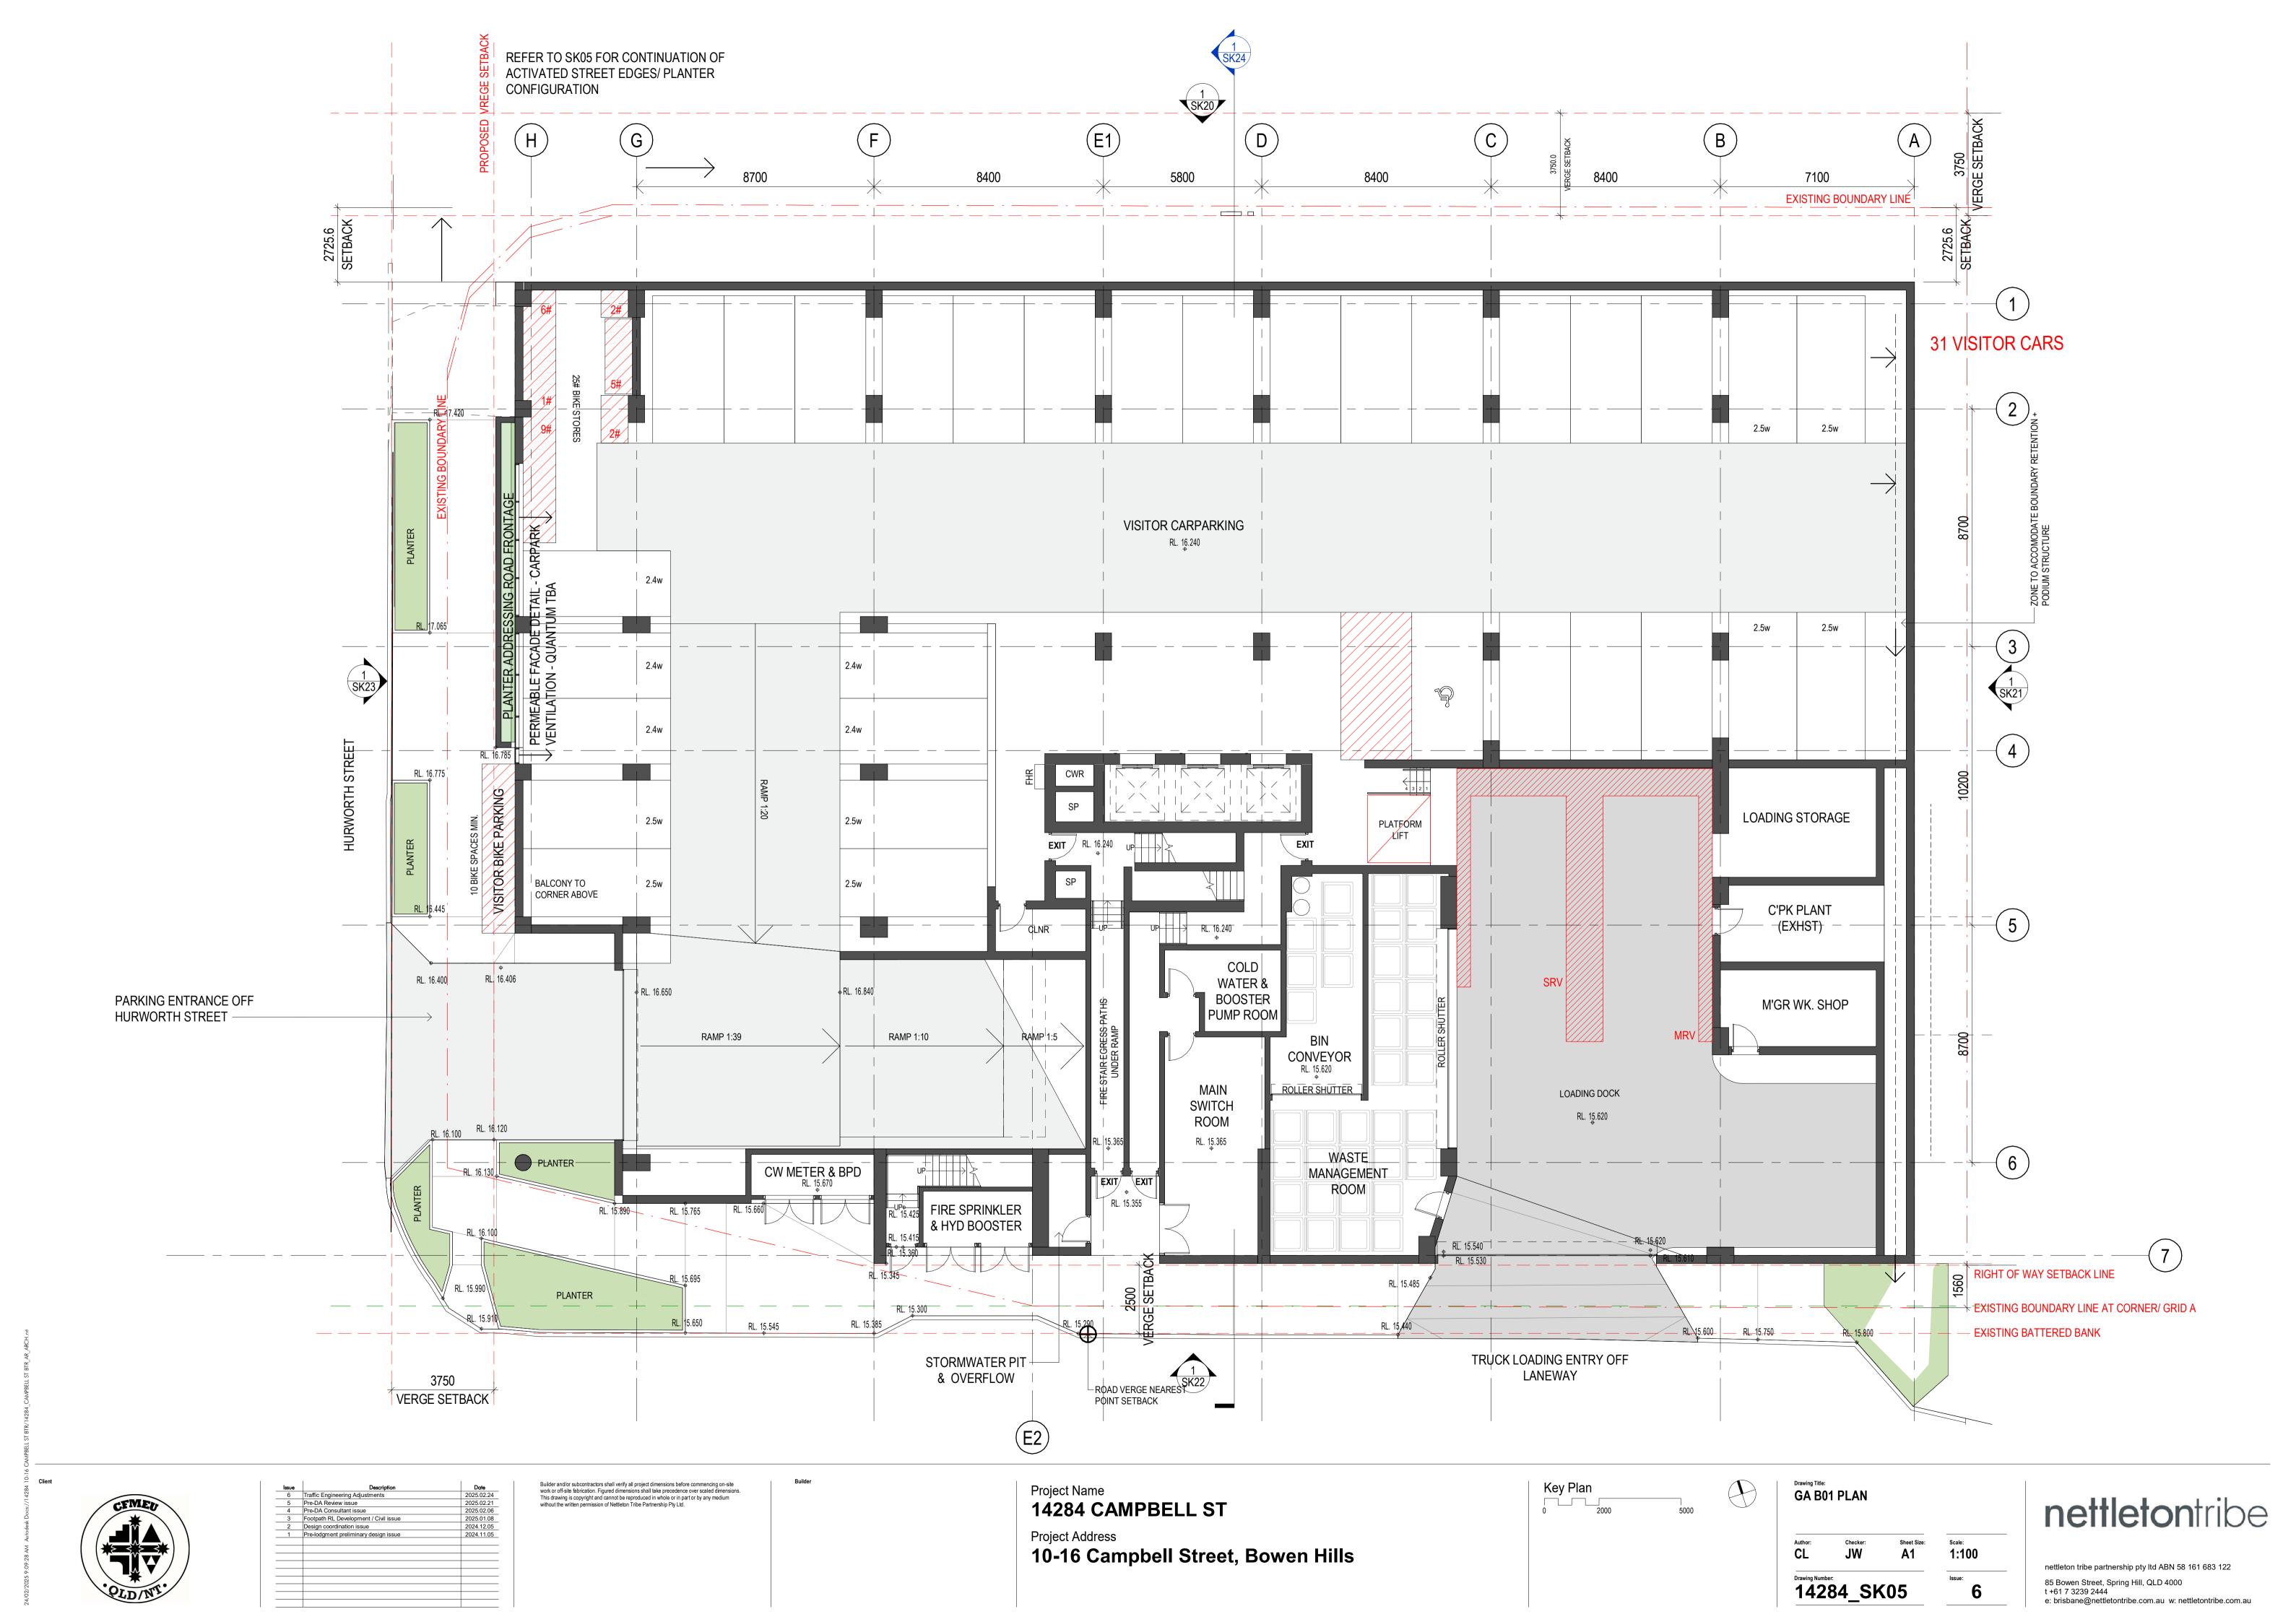 4
 Pre-DA Review issue

 3
 Pre-DA Consultant issue

 2
 Design coordination issue

 1
 Pre-lodgment preliminary design issue

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Drawing Title:
GA L04 PODIUM DECK PLAN

1:100 **A**1 14284\_SK11

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 Issue
 Description
 Date

 4
 Pre-DA Review issue
 2025.02.21

 3
 Pre-DA Consultant issue
 2025.02.06

 2
 Design coordination issue
 2024.12.05

 1
 Pre-lodgment preliminary design issue
 2024.11.05

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y Plan 2000 5000 TYPICAL (ODD) UNIT LEVEL(5,7,9,1,13,15,17,19,21,23,25) GAPLAN


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Project Name
14284 CAMPBELL ST Project Address
10-16 Campbell Street, Bowen Hills




TYPICAL (EVEN) UNIT LEVEL 4,10,14,18,22,26) GA PLAN

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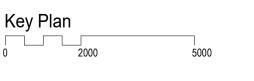
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Project Name
14284 CAMPBELL ST
Project Address
10-16 Campbell Street, Bowen Hills

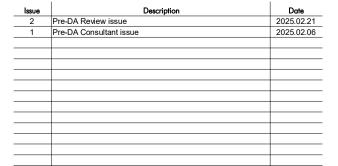

ATYPICAL UNIT (EVERY 4TH) LEVEL (8,12, 16,20,24) GAPLAN NETTICE


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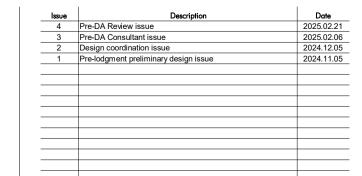


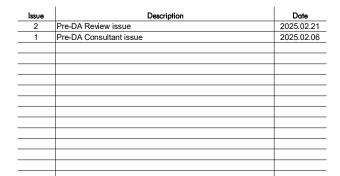







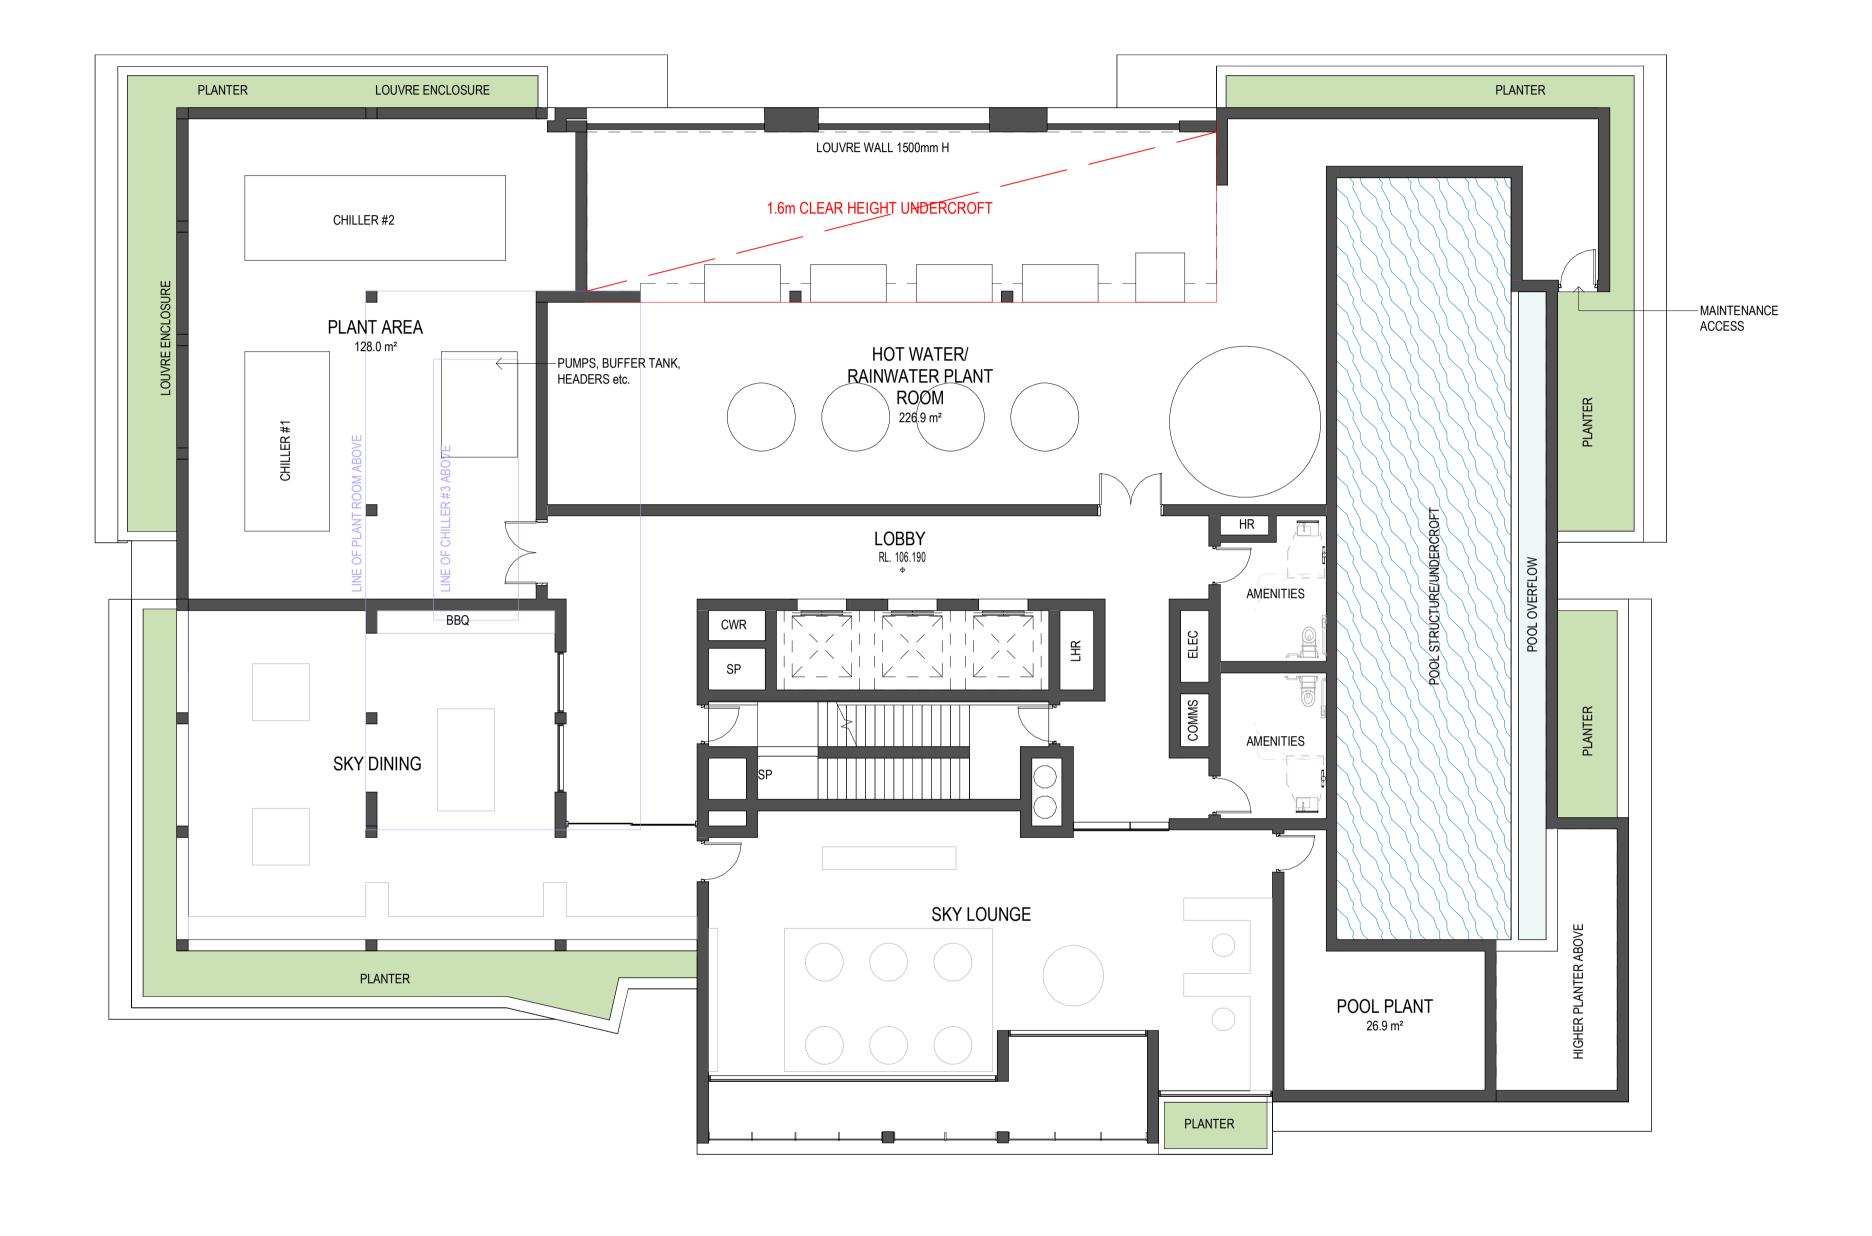

Project Name
14284 CAMPBELL ST

Project Address
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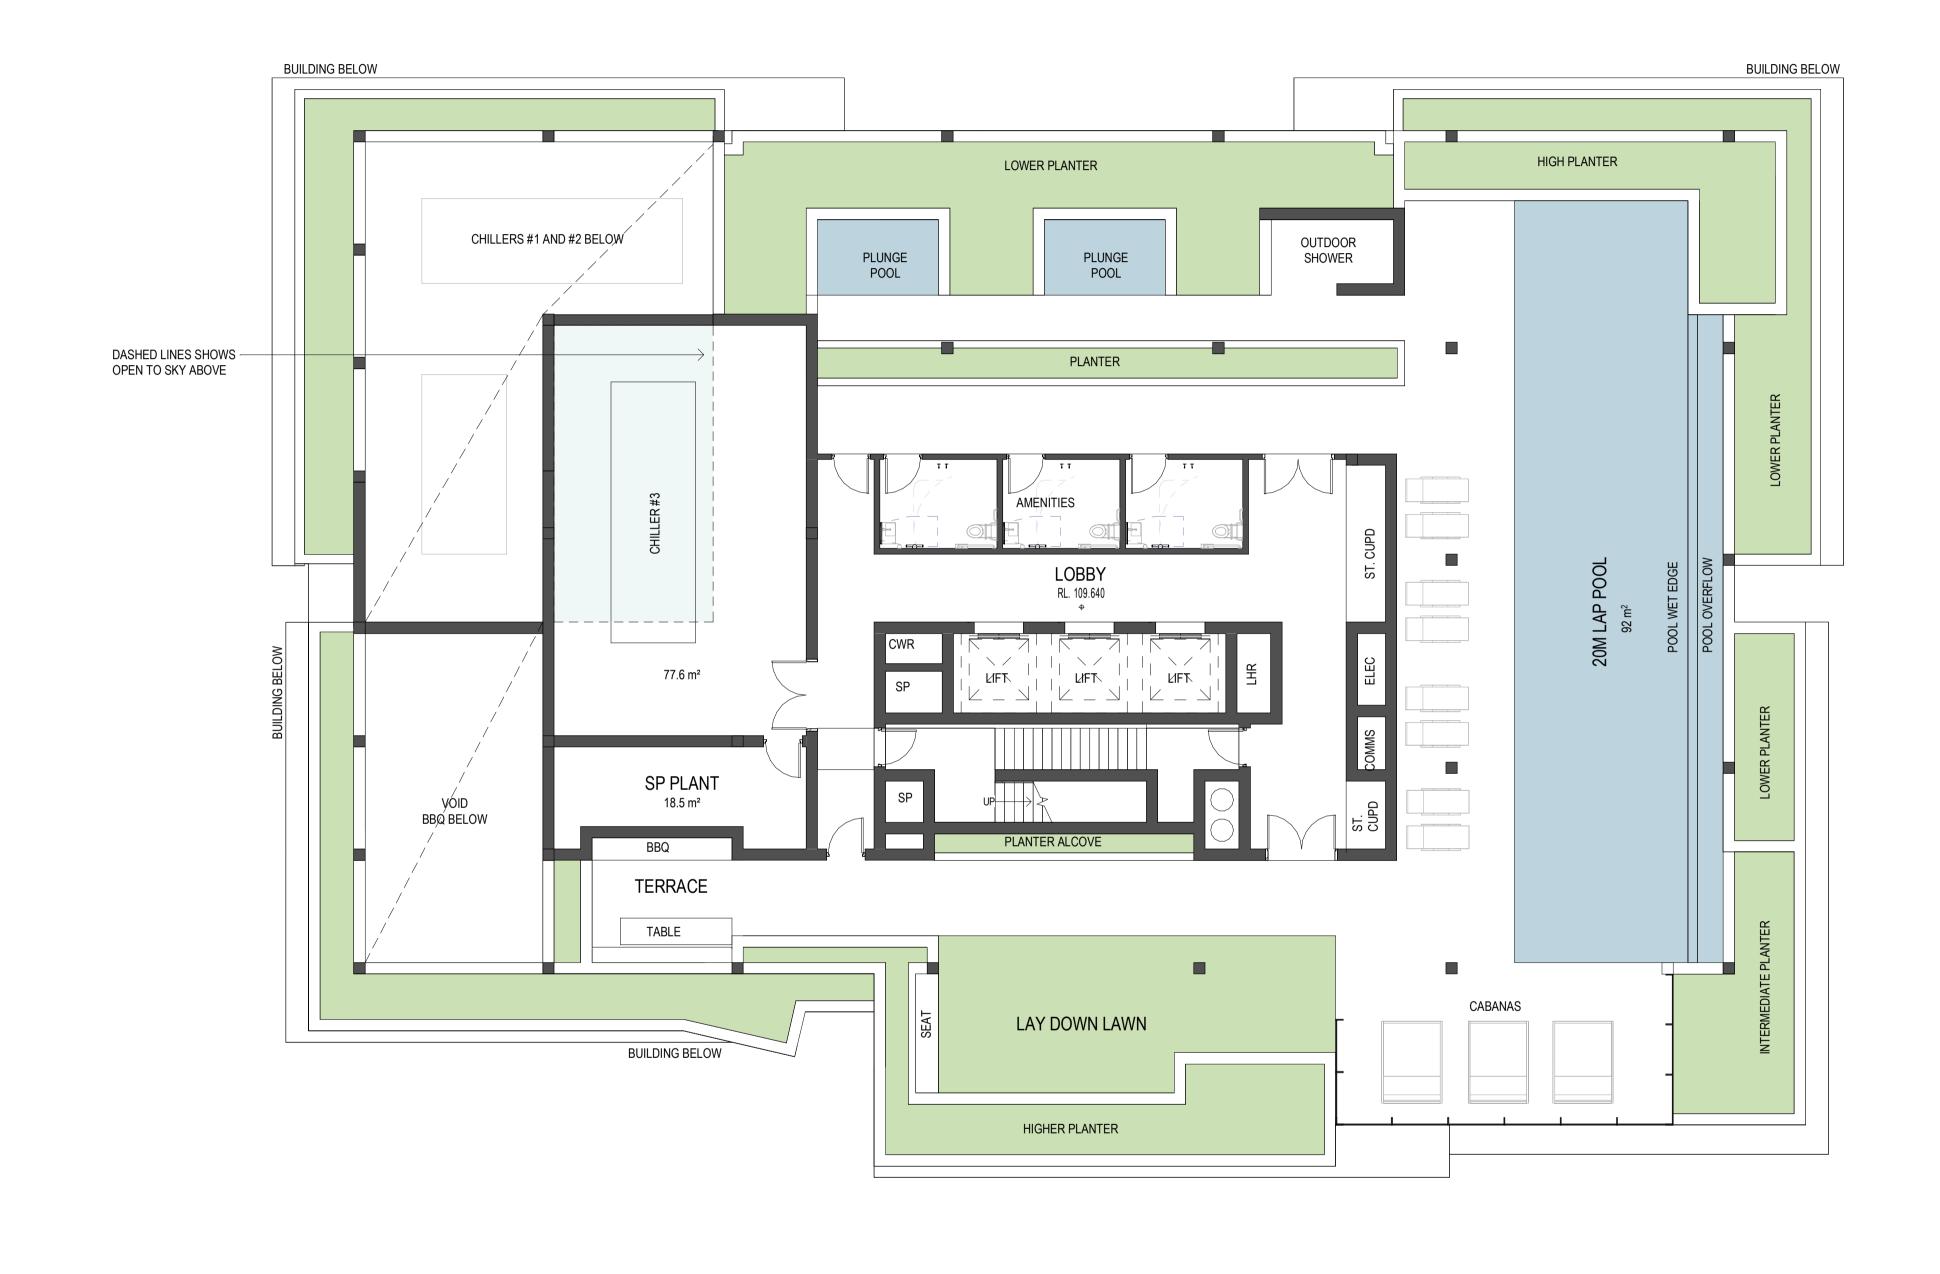
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LEVEL 27 LOWER ROOF PLAN

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 Pre-DA Review issue
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 Pre-DA Consultant issue
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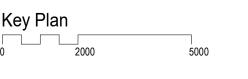
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 Pre-lodgment preliminary design issue
 2024.11.0

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Project Name
14284 CAMPBELL ST

Project Address
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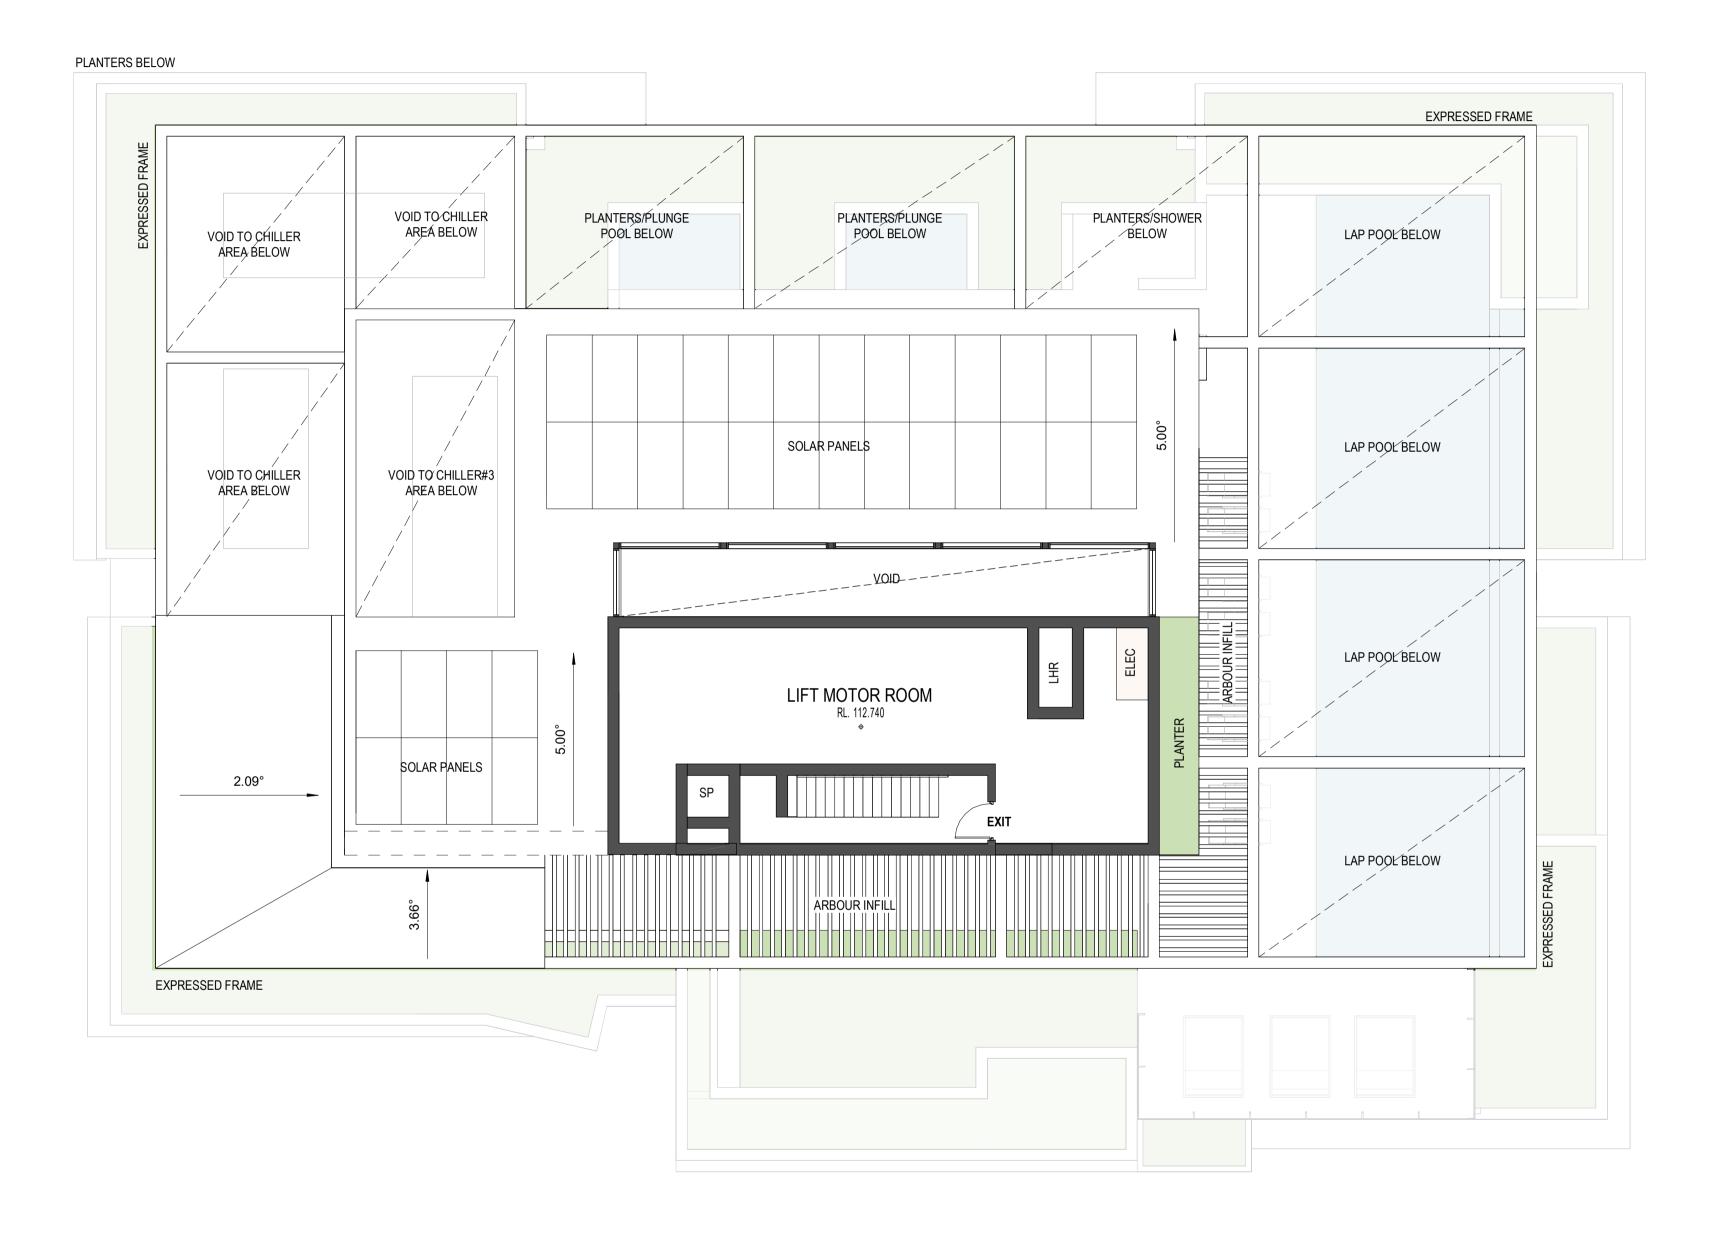


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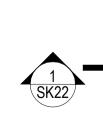
LEVEL 28 ROOF DECK PLAN















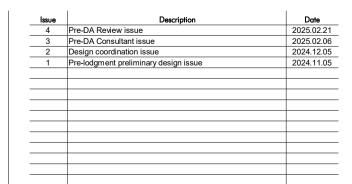

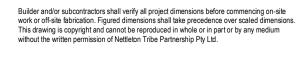












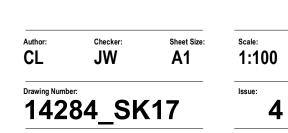




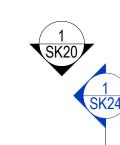


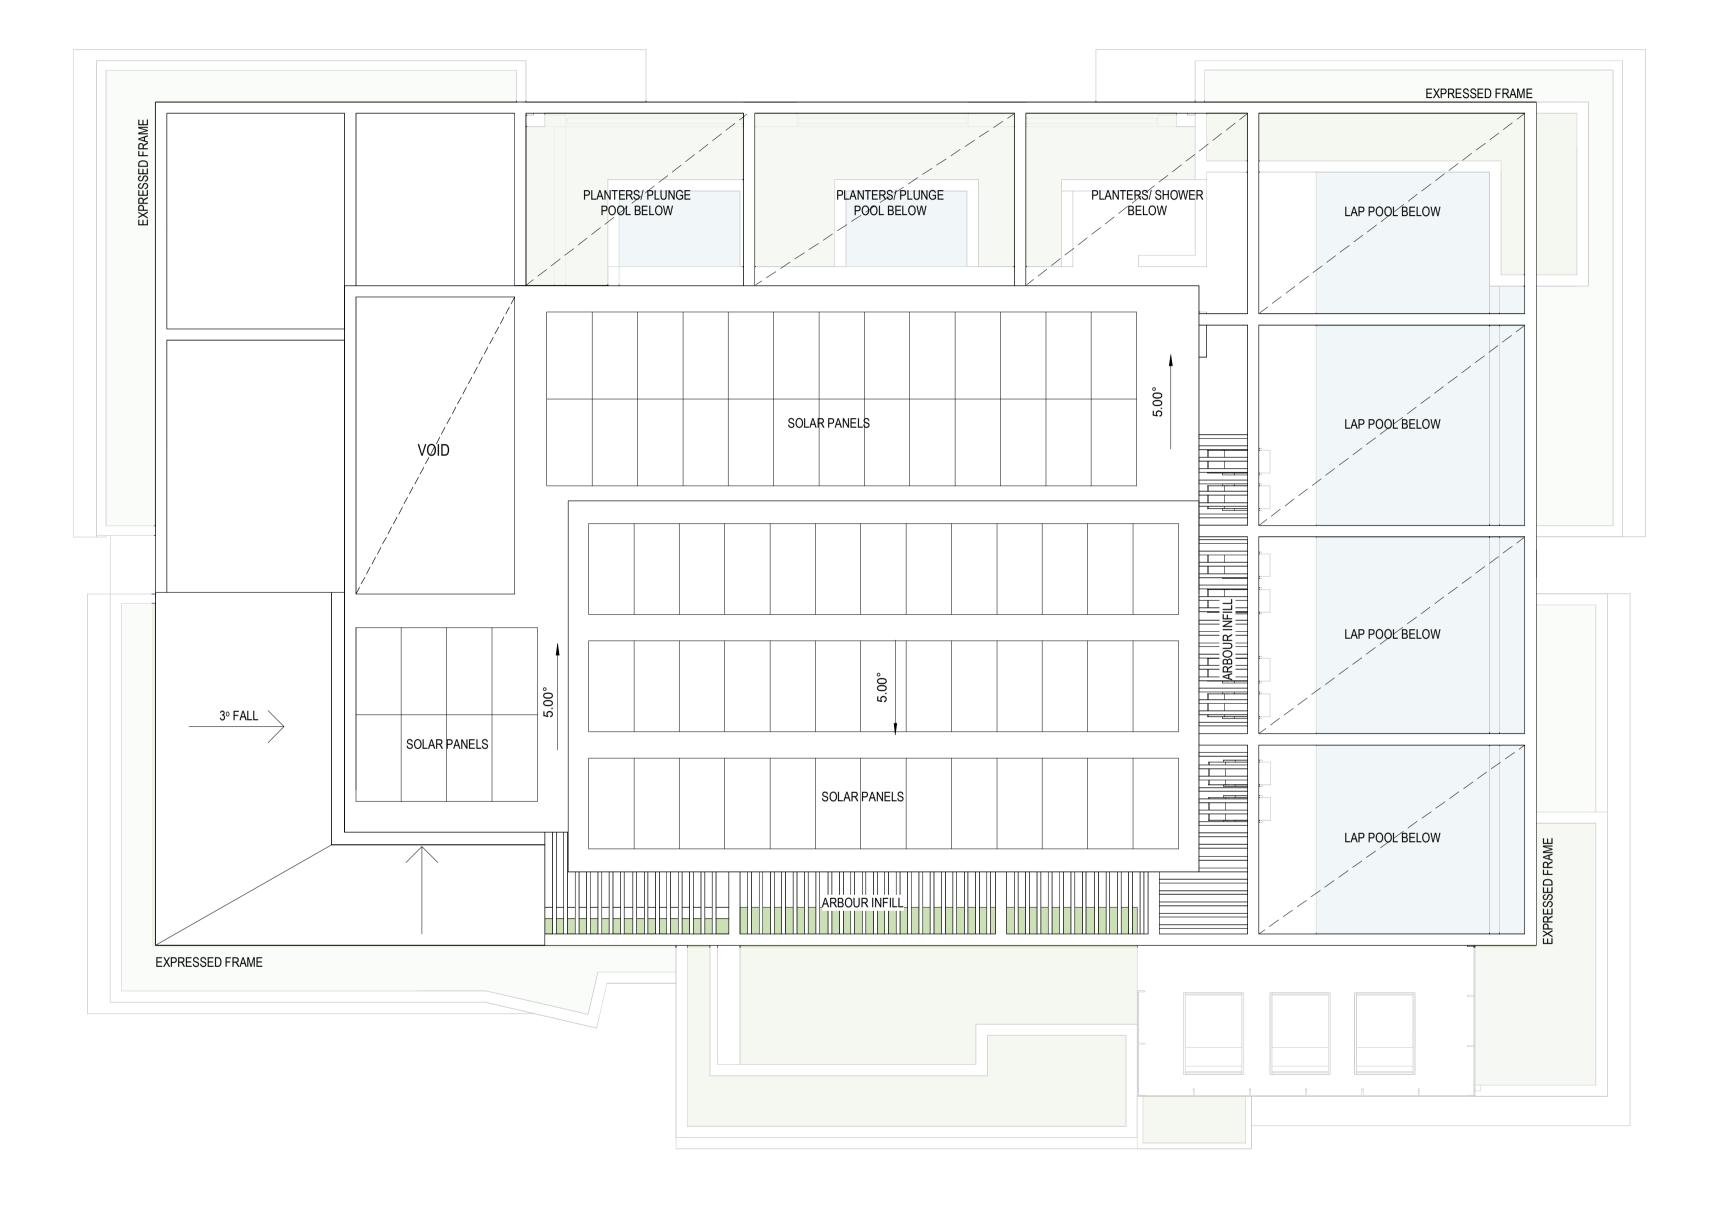



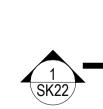



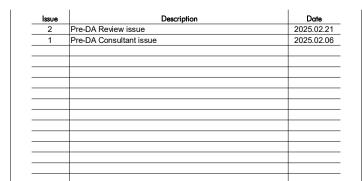

Project Name
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Project Address
10-16 Campbell Street, Bowen Hills





Drawing Title:
ROOF PLAN

Author: Checker: Sheet Size: Scale:
CL JW A1 1:100

Drawing Number: Issue: 2

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FULL HEIGHT GLAZING SYSTEM DARK TINT GLAZING MONUMENT FRAMING

SEMI-FRAMELESS GLASS BALUSTRADE DARK TINT GLAZING STANCHION TO BE MONUMENT POWDERCOAT

FULL-HEIGHT SEMI-FRAMELESS GLASS BALUSTRADE DARK TINT GLAZING STANCHION TO BE MONUMENT POWDERCOAT

PRECAST CONCRETE PANEL - MINERAL STAIN GREY

PRECAST CONCRETE PANEL - MINERAL PAINT BRILLIANT WHITE

BLOCK WALL; RENDERED AND PAINTED - MINERAL PAINT GREEN-GREY

PRECAST CONCRETE PLANTER BOXES

PERFORATED POWDERCOAT VERTICAL BLADES WITH VARYING ORIENTATION AND COLOUR

POWDERCOAT VERTICAL BLADES WITH VARYING ORIENTATION

AND COLOUR

LOUVRE SCREEN TO PLANT - MONUMENT

FRAMED MESH INFILL SCREEN - MONUMENT

SOLID ALUMINIUM CLADDING - BRILLIANT WHITE, TO AWNINGS AND WINDOW BOX FRAMES

METAL ROOF TYPE 1 --WHITE CONCRETE TEXTURE PARAPET, BOX GUTTER AND METAL ROOF

SHEET

METAL ROOF TYPE 2 --

PERGOLA, MONUMENT POWDERCOATED FINISH




| Issue | Description                           | Date     |
|-------|---------------------------------------|----------|
| 4     | Pre-DA Review issue                   | 2025.02. |
| 3     | Pre-DA Consultant issue               | 2025.02. |
| 2     | Design coordination issue             | 2024.12. |
| 1     | Pre-lodgment preliminary design issue | 2024.11. |
|       |                                       |          |
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Project Address 10-16 Campbell Street, Bowen Hills





Drawing Title:
NORTH ELEVATION

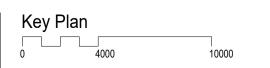1:200 **A1** 14284\_SK20



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L01 FULL HEIGHT GLAZING SYSTEM DARK TINT GLAZING MONUMENT FRAMING

BAL01 SEMI-FRAMELESS GLASS BALUSTRADE DARK TINT GLAZING STANCHION TO BE MONUMENT POWDERCOAT

FULL-HEIGHT SEMI-FRAMELESS GLASS BALUSTRADE DARK TINT GLAZING STANCHION TO BE MONUMENT POWDERCOAT

**VF01** PRECAST CONCRETE PANEL - MINERAL STAIN GREY

F02 PRECAST CONCRETE PANEL - MINERAL PAINT BRILLIANT WHITE

BLOCK WALL; RENDERED AND PAINTED - MINERAL PAINT GREEN-GREY

WF04 PRECAST CONCRETE PLANTER BOXES

01 PERFORATED POWDERCOAT VERTICAL BLADES WITH VARYING ORIENTATION AND COLOUR

POWDERCOAT VERTICAL BLADES WITH VARYING ORIENTATION

R03 LOUVRE SCREEN TO PLANT - MONUMENT

FRAMED MESH INFILL SCREEN - MONUMENT

CLA01 SOLID ALUMINIUM CLADDING - BRILLIANT WHITE, TO AWNINGS AND WINDOW BOX FRAMES

FOA METAL DOOF TYPE A

METAL ROOF TYPE 1 -WHITE CONCRETE TEXTURE PARAPET, BOX GUTTER AND METAL ROOF
SHEET

02 METAL ROOF TYPE 2 --PERGOLA, MONUMENT POWDERCOATED FINISH



| I .   |                                       | l .        |
|-------|---------------------------------------|------------|
| Issue | Description                           | Date       |
| 4     | Pre-DA Review issue                   | 2025.02.21 |
| 3     | Pre-DA Consultant issue               | 2025.02.06 |
| 2     | Design coordination issue             | 2024.12.05 |
| 1     | Pre-lodgment preliminary design issue | 2024.11.05 |
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Project Name

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Drawing Title:
EAST ELEVATION

Checker: Sheet Size:

14284\_SK21







- GL01 FULL HEIGHT GLAZING SYSTEM DARK TINT GLAZING MONUMENT FRAMING
- BAL01 SEMI-FRAMELESS GLASS BALUSTRADE DARK TINT GLAZING STANCHION TO BE MONUMENT POWDERCOAT
- FULL-HEIGHT SEMI-FRAMELESS GLASS BALUSTRADE DARK TINT GLAZING STANCHION TO BE MONUMENT POWDERCOAT
- WF01 PRECAST CONCRETE PANEL MINERAL STAIN GREY
- NF02 PRECAST CONCRETE PANEL MINERAL PAINT BRILLIANT WHITE
- BLOCK WALL; RENDERED AND PAINTED MINERAL PAINT GREEN-GREY
- WF04 PRECAST CONCRETE PLANTER BOXES
- R01 PERFORATED POWDERCOAT VERTICAL BLADES WITH VARYING ORIENTATION AND COLOUR
- SCR02 POWDERCOAT VERTICAL BLADES WITH VARYING ORIENTATION
- R03 LOUVRE SCREEN TO PLANT MONUMENT
- **SCR04** FRAMED MESH INFILL SCREEN MONUMENT
- CLA01 SOLID ALUMINIUM CLADDING BRILLIANT WHITE, TO AWNINGS AND WINDOW BOX FRAMES
- RF01 METAL ROOF TYPE 1 -WHITE CONCRETE TEXTURE PARAPET, BOX GUTTER AND METAL ROOF
  SHEET
- RF02 METAL ROOF TYPE 2 --PERGOLA, MONUMENT POWDERCOATED FINISH




| Issue | Description                           | Date     |
|-------|---------------------------------------|----------|
| 4     | Pre-DA Review issue                   | 2025.02. |
| 3     | Pre-DA Consultant issue               | 2025.02. |
| 2     | Design coordination issue             | 2024.12. |
| 1     | Pre-lodgment preliminary design issue | 2024.11. |
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14284 CAMPBELL ST

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Author: Checker: Sheet Size:
CL JW A1


14284\_SK22

Scale: 1:200

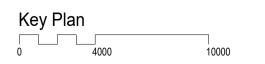

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91 FULL HEIGHT GLAZING SYSTEM DARK TINT GLAZING MONUMENT FRAMING

BAL01 SEMI-FRAMELESS GLASS BALUSTRADE DARK TINT GLAZING STANCHION TO BE MONUMENT POWDERCOAT

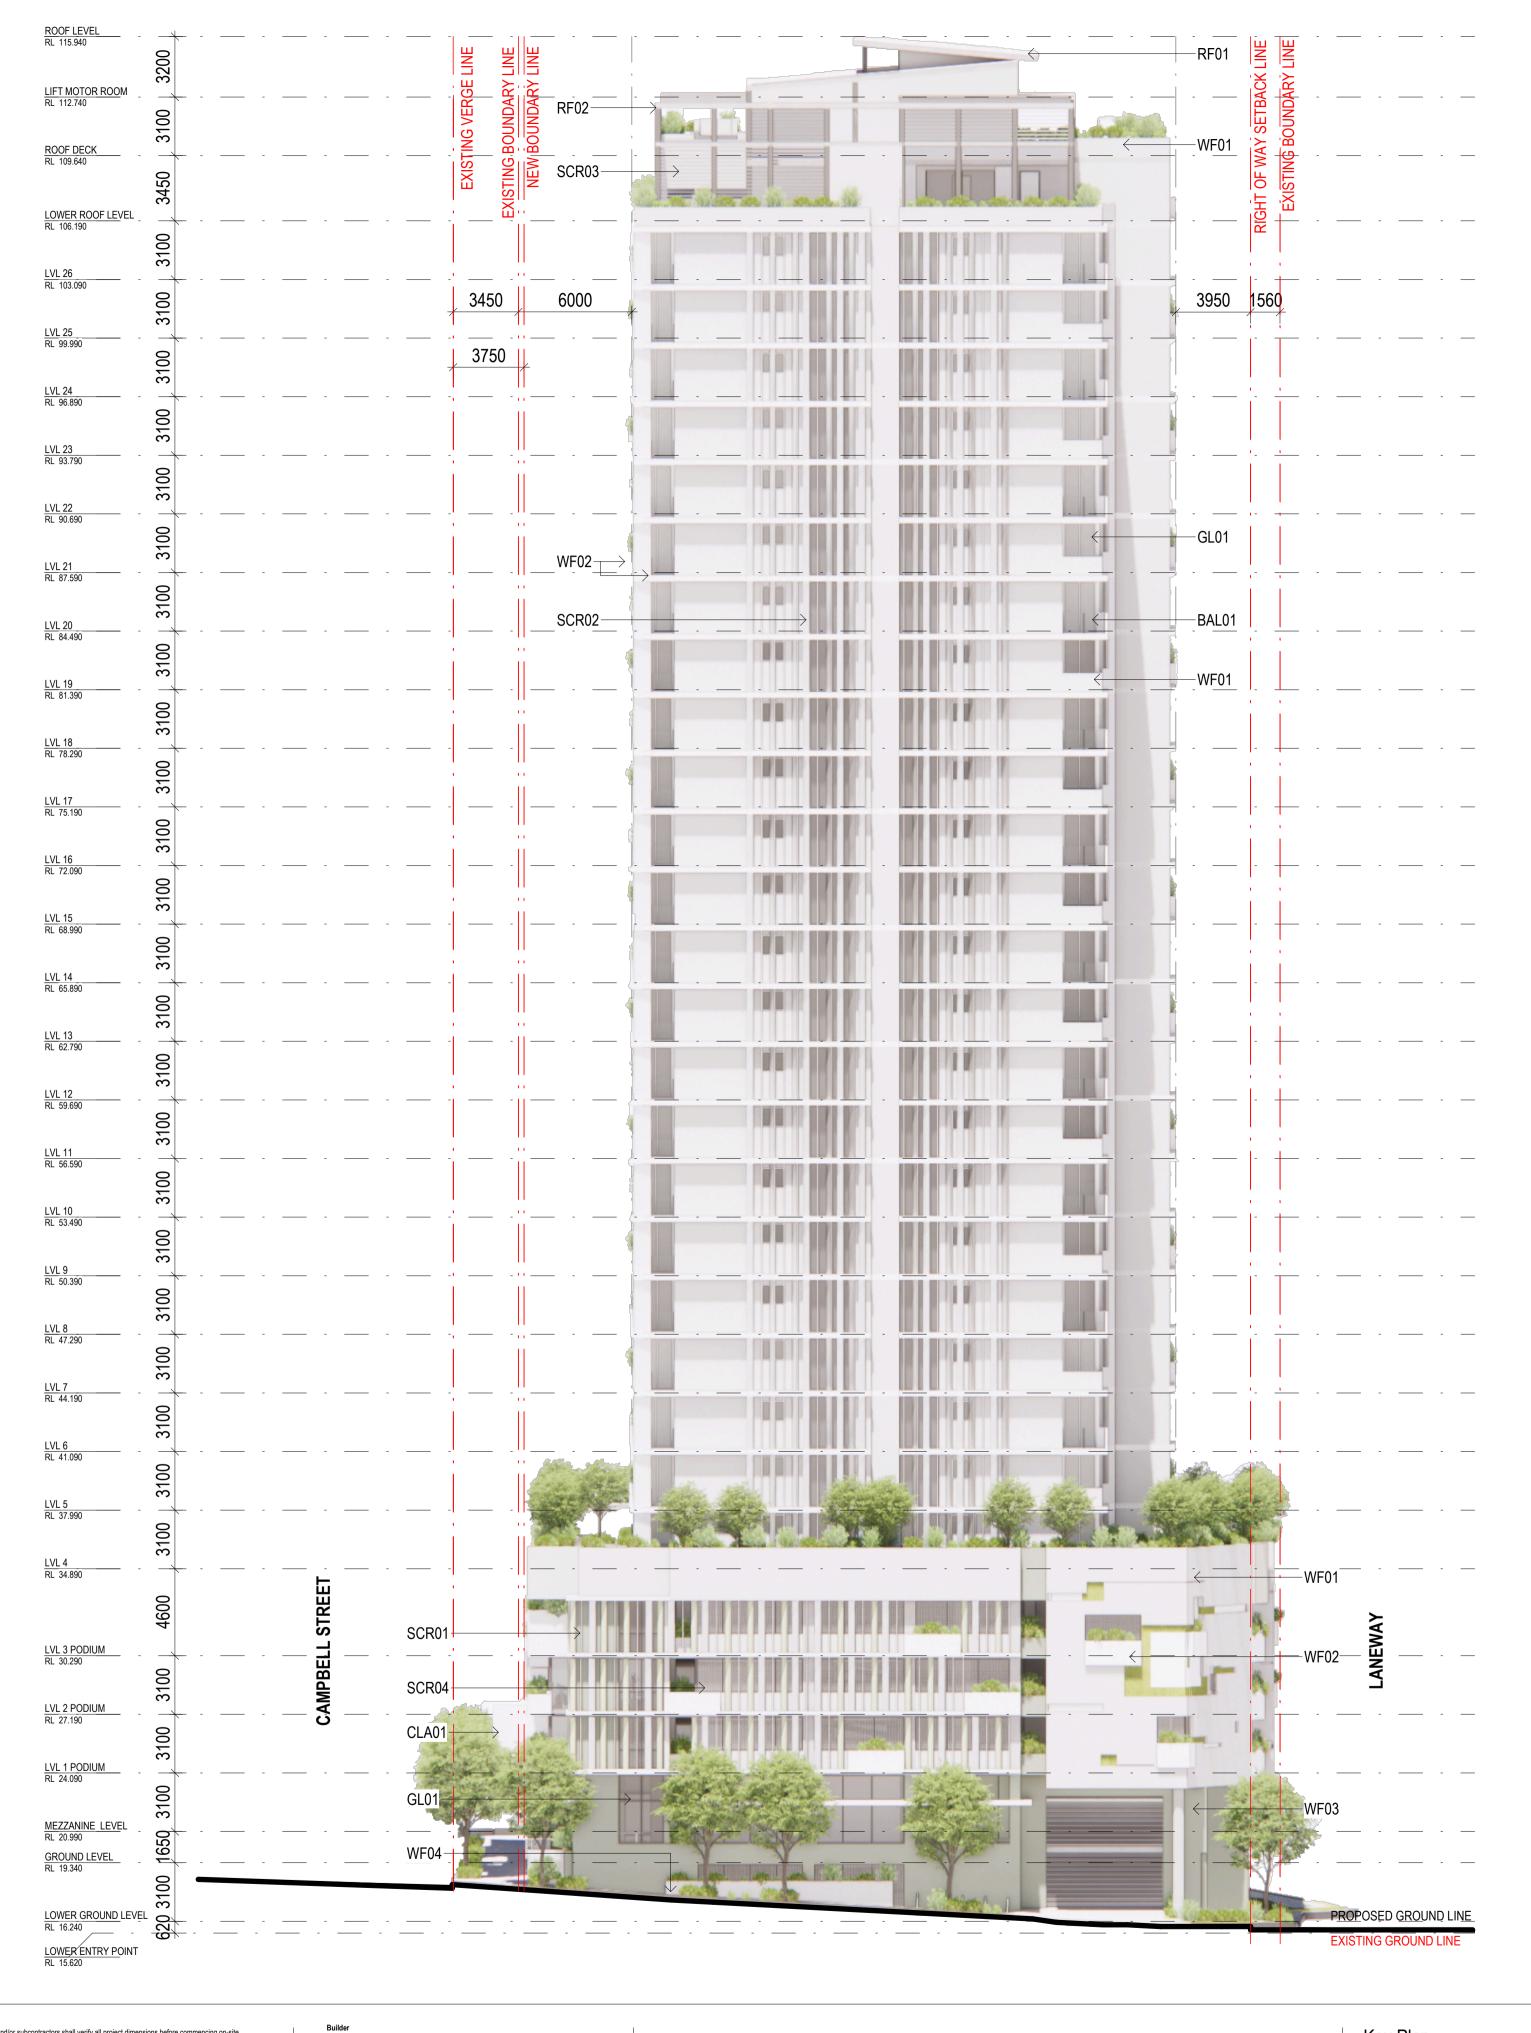**BAL02** FULL-HEIGHT SEMI-FRAMELESS GLASS BALUSTRADE DARK TINT GLAZING STANCHION TO BE MONUMENT POWDERCOAT

WF01 PRECAST CONCRETE PANEL - MINERAL STAIN GREY

PRECAST CONCRETE PANEL - MINERAL PAINT BRILLIANT WHITE

#F03 BLOCK WALL; RENDERED AND PAINTED - MINERAL PAINT GREEN-GREY

WF04 PRECAST CONCRETE PLANTER BOXES

CR01 PERFORATED POWDERCOAT VERTICAL BLADES WITH VARYING ORIENTATION AND COLOUR

POWDERCOAT VERTICAL BLADES WITH VARYING ORIENTATION

AND COLOUR

CR03 LOUVRE SCREEN TO PLANT - MONUMENT

SCR04 FRAMED MESH INFILL SCREEN - MONUMENT

CLA01 SOLID ALUMINIUM CLADDING - BRILLIANT WHITE, TO AWNINGS AND WINDOW BOX FRAMES

RF01 METAL ROOF TYPE 1 -WHITE CONCRETE TEXTURE PARAPET BOX GUTTER AND METAL BO

WHITE CONCRETE TEXTURE PARAPET, BOX GUTTER AND METAL ROOF SHEET


METAL ROOF TYPE 2 -PERGOLA, MONUMENT POWDERCOATED FINISH

CEMEN \*\*\*

| Issue | Description                           | Date      |
|-------|---------------------------------------|-----------|
| 4     | Pre-DA Review issue                   | 2025.02.2 |
| 3     | Pre-DA Consultant issue               | 2025.02.0 |
| 2     | Design coordination issue             | 2024.12.0 |
| 1     | Pre-lodgment preliminary design issue | 2024.11.0 |
|       |                                       |           |
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Project Name
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Project Address
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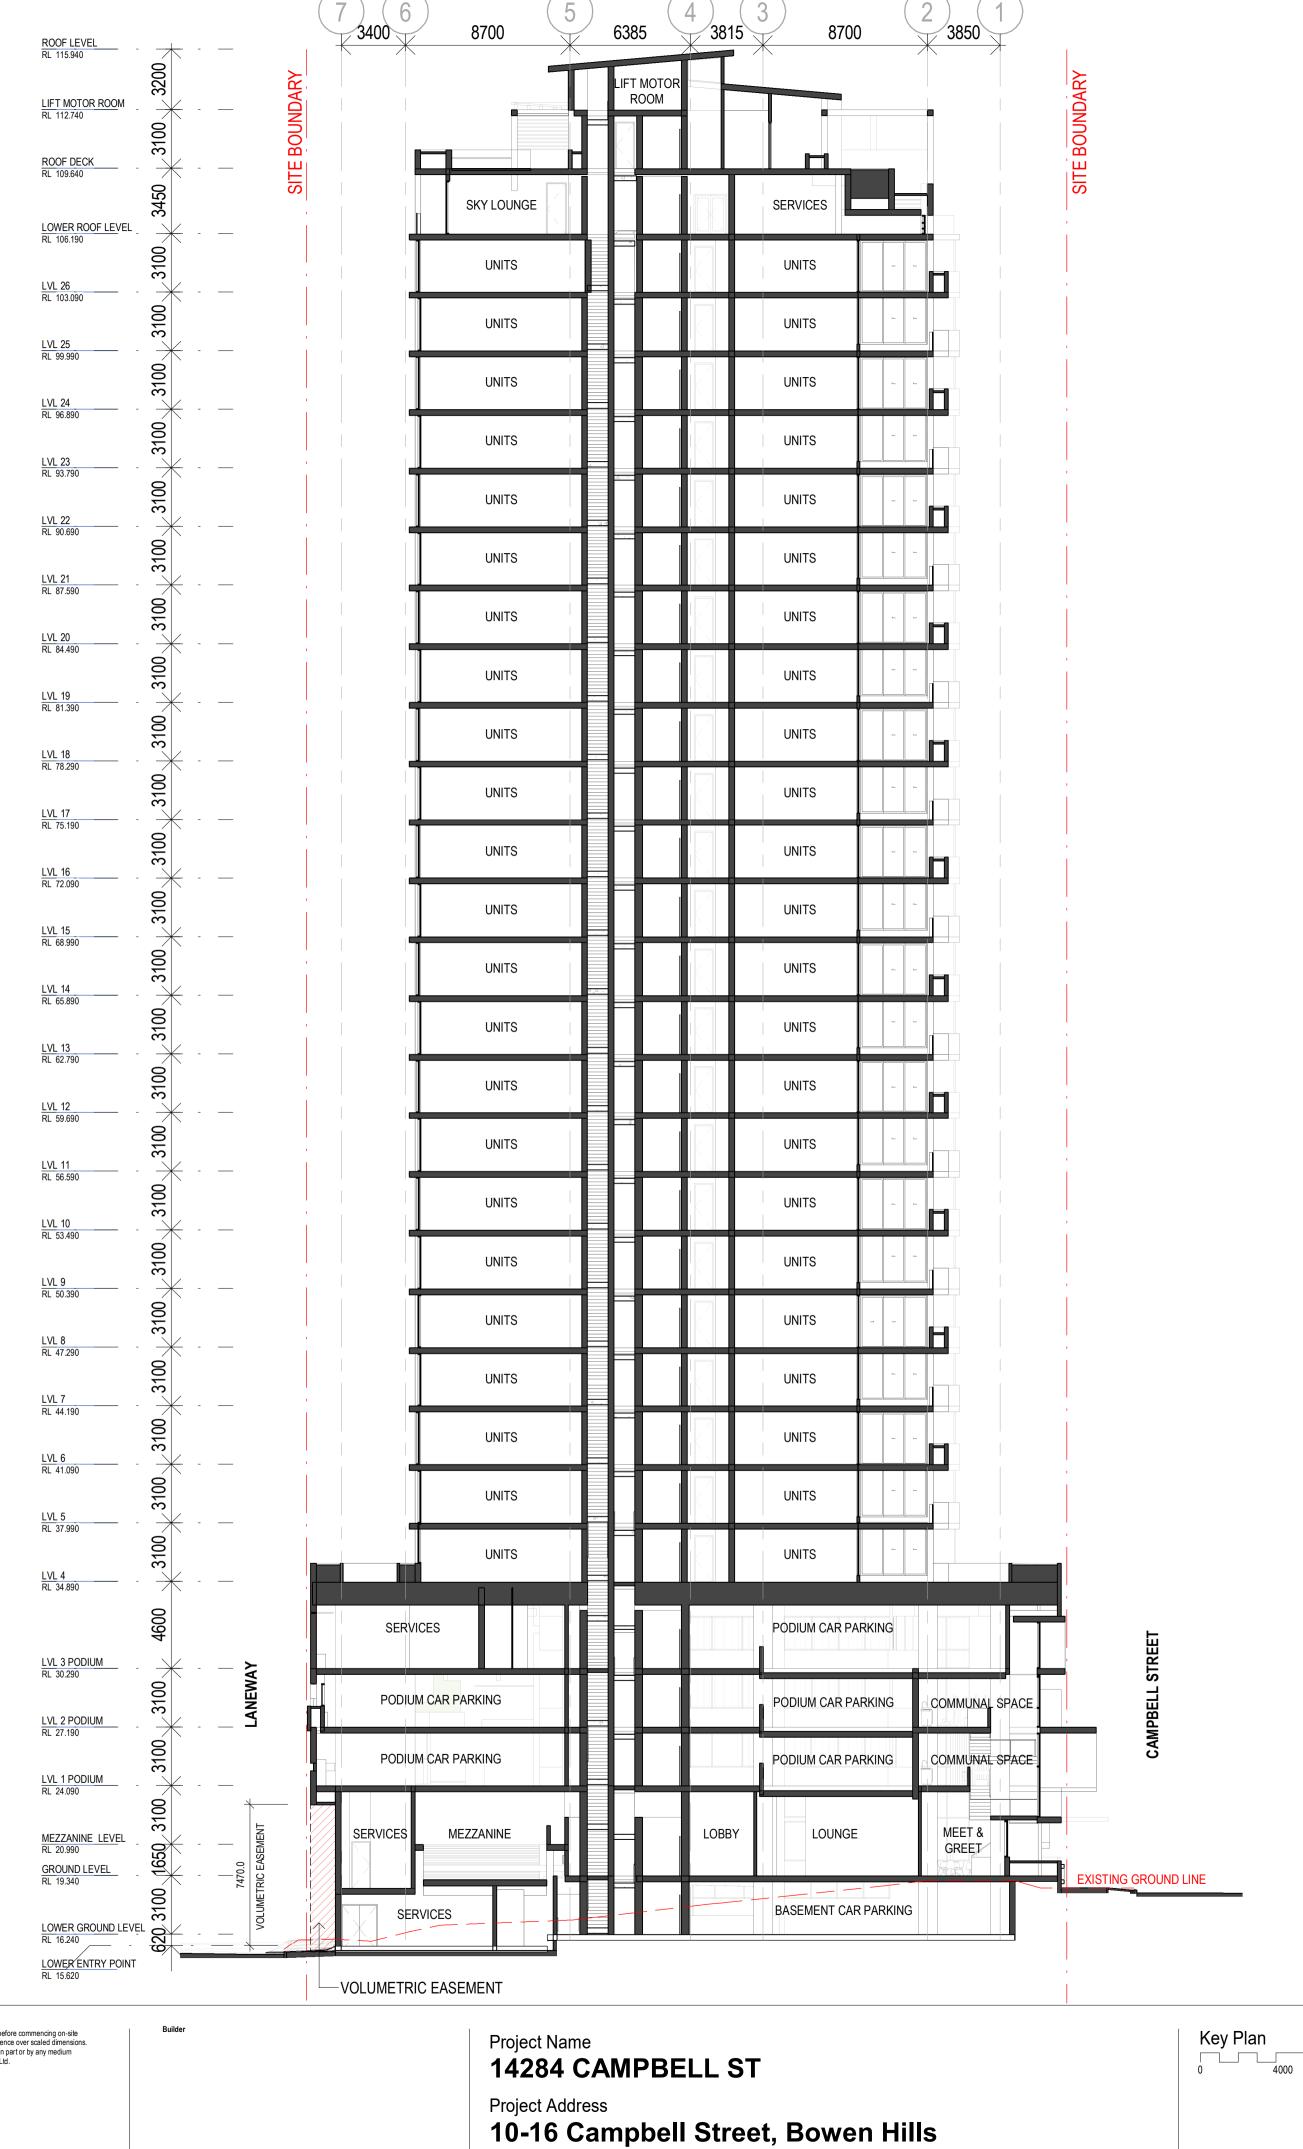
Drawing Title:
WEST ELEVATION

Author: Checker: Sheet Size: CL JW A1

Drawing Number: 14284\_SK23

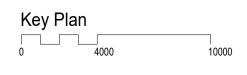

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 Issue
 Description
 Date

 3
 Pre-DA Review issue
 2025.02.21

 2
 Pre-DA Consultant issue
 2025.02.06

 1
 Design coordination issue
 2024.12.05

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SECTION A


Author: Checker: Sheet Size: Scale: CL JW A1 1:200

Drawing Number: I4284\_SK24 3

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 Issue
 Description
 Date

 4
 Pre-DA Review issue
 2025.02.2

 3
 Pre-DA Consultant issue
 2025.02.0

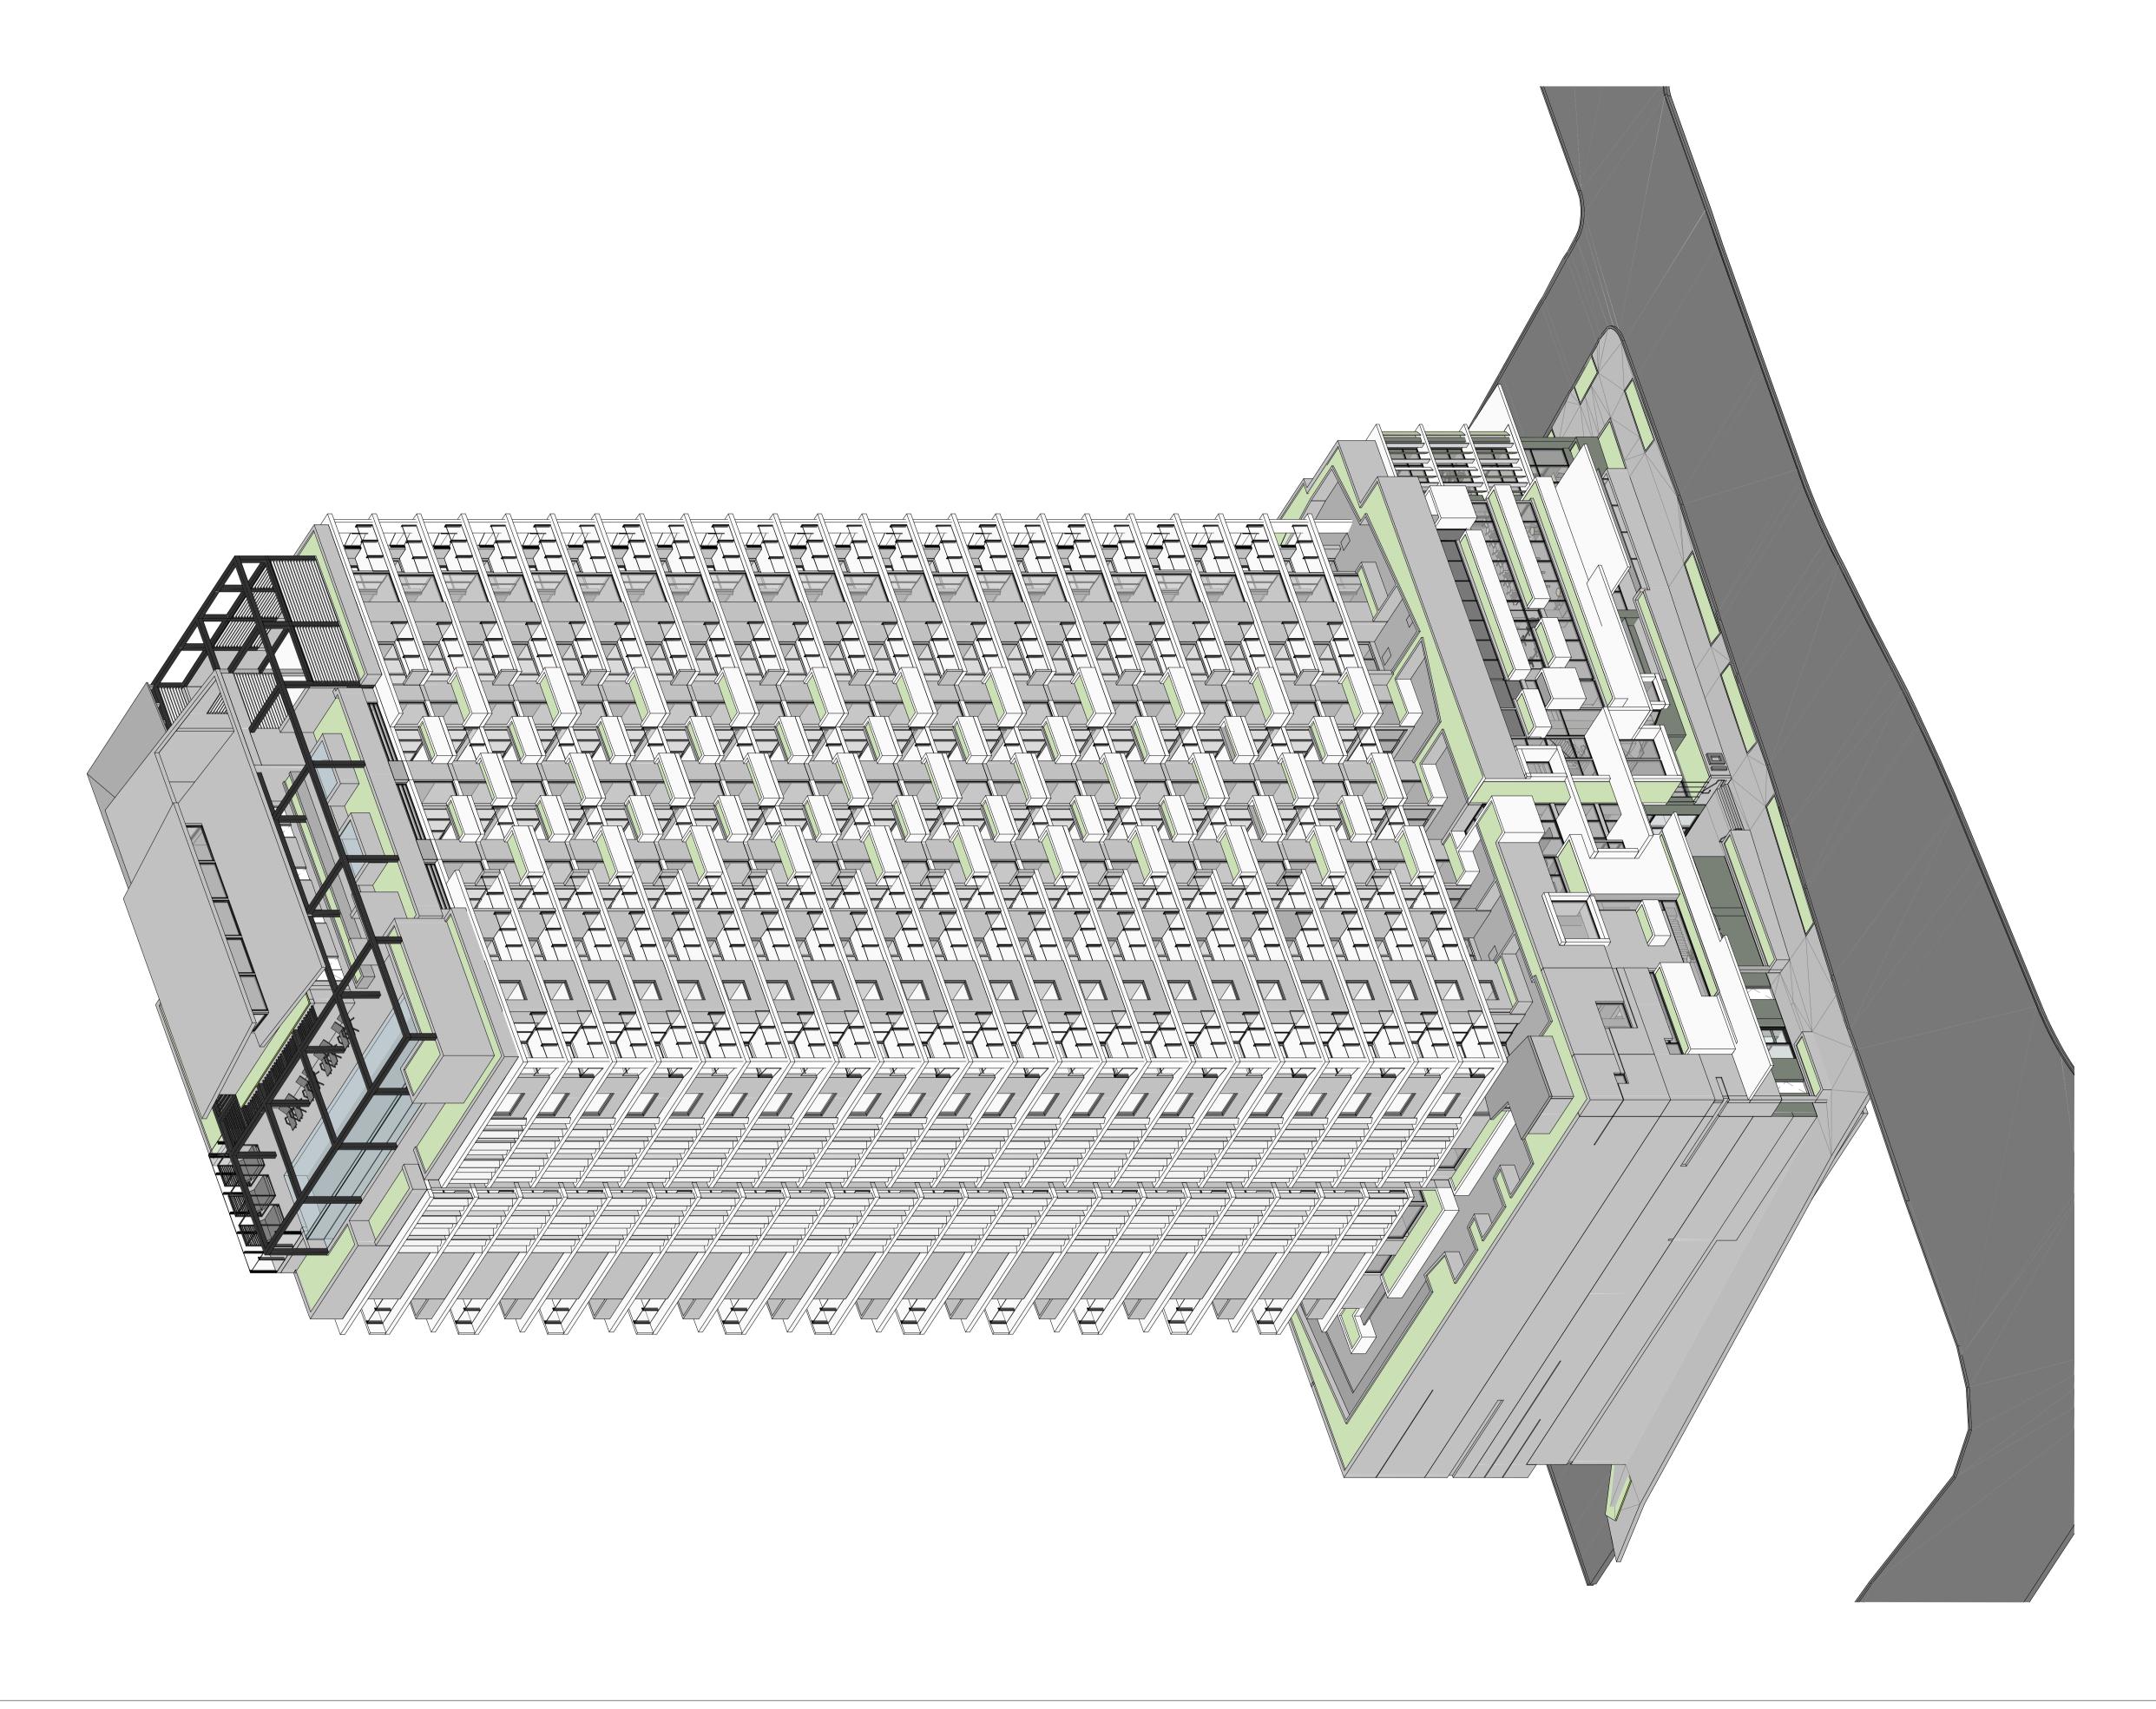 2
 Design coordination issue
 2024.12.0

 1
 Pre-lodgment preliminary design issue
 2024.11.0

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Pr

Project Name
14284 CAMPBELL ST
Project Address

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Drawing Title:
Northeast 3D Perspective


Author: Checker: Sheet Size: CL JW A1

Drawing Number: 14284\_SK30

Scale: 1:200 net



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 Issue
 Description
 Date

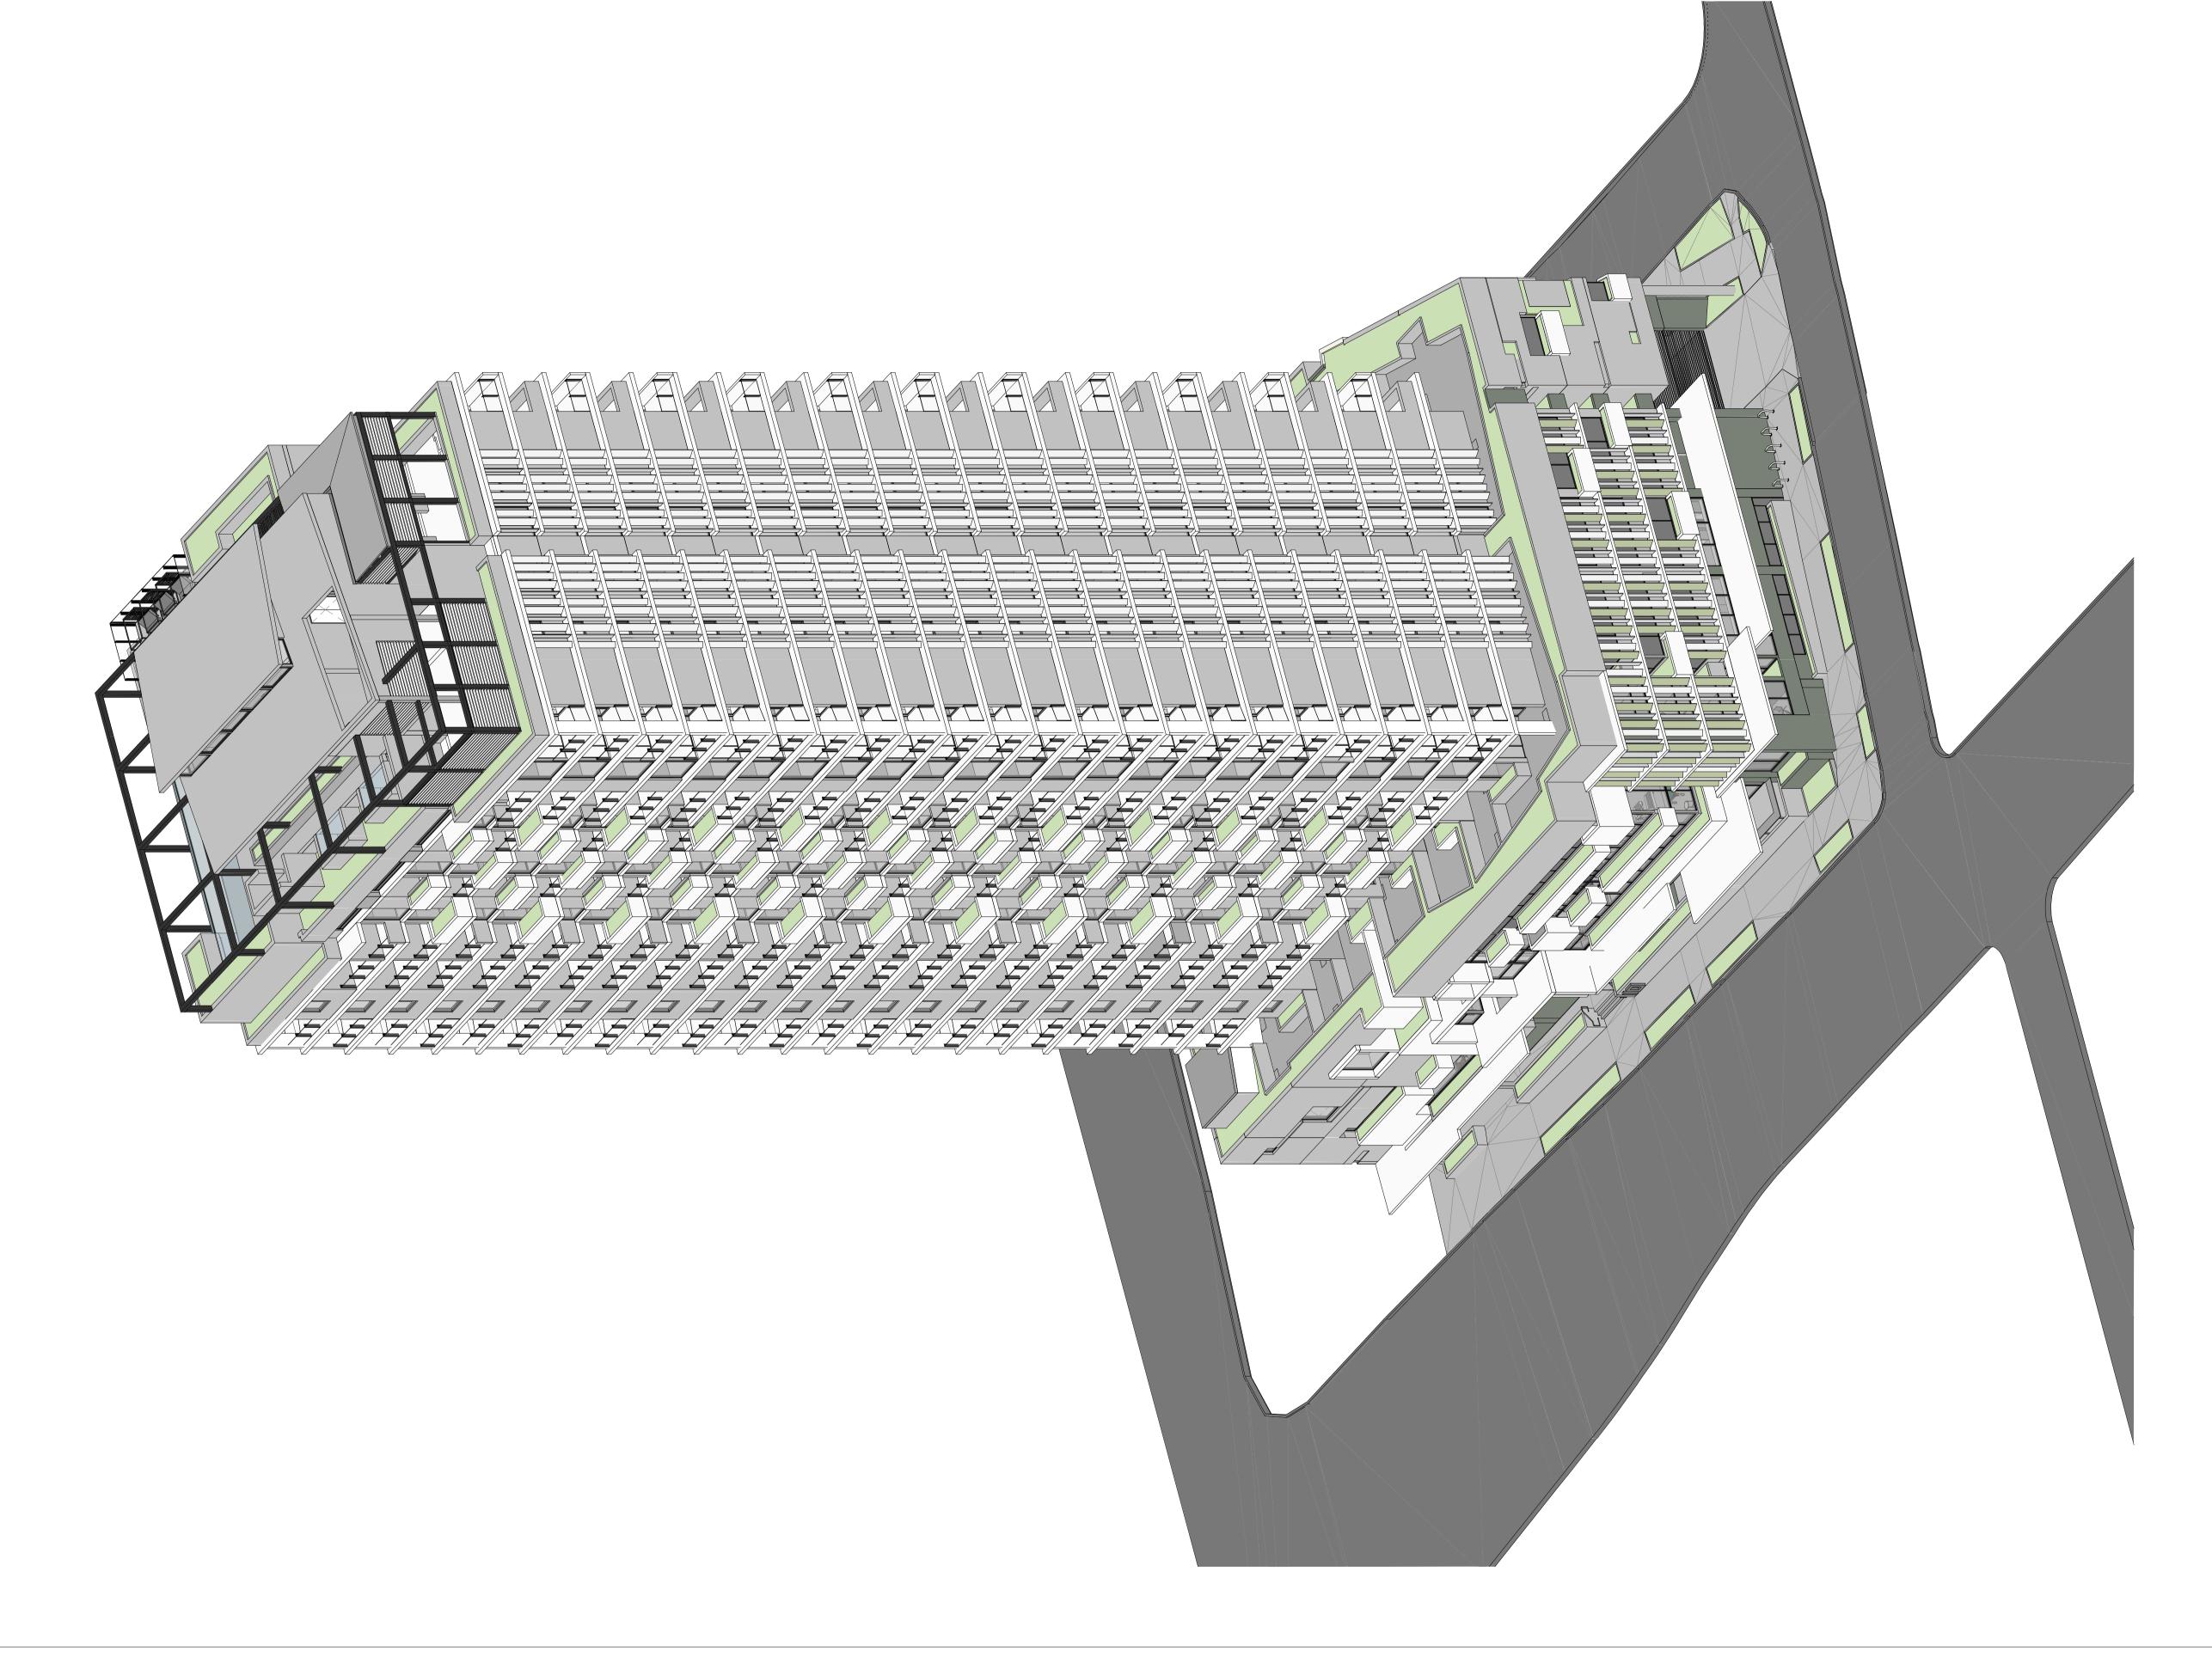 4
 Pre-DA Review issue
 2025.02.21

 3
 Pre-DA Consultant issue
 2025.02.06

 2
 Design coordination issue
 2024.12.05

 1
 Pre-lodgment preliminary design issue
 2024.11.05

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Builder

Project Name
14284 CAMPBELL ST
Project Address
10-16 Campbell Street, Bowen Hills





Drawing Title:
Northwest 3D Perspective


Author: Checker: Sheet Size: CL JW A1


Drawing Number: 14284\_SK31

Scale: 1:200



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 Issue
 Description
 Date

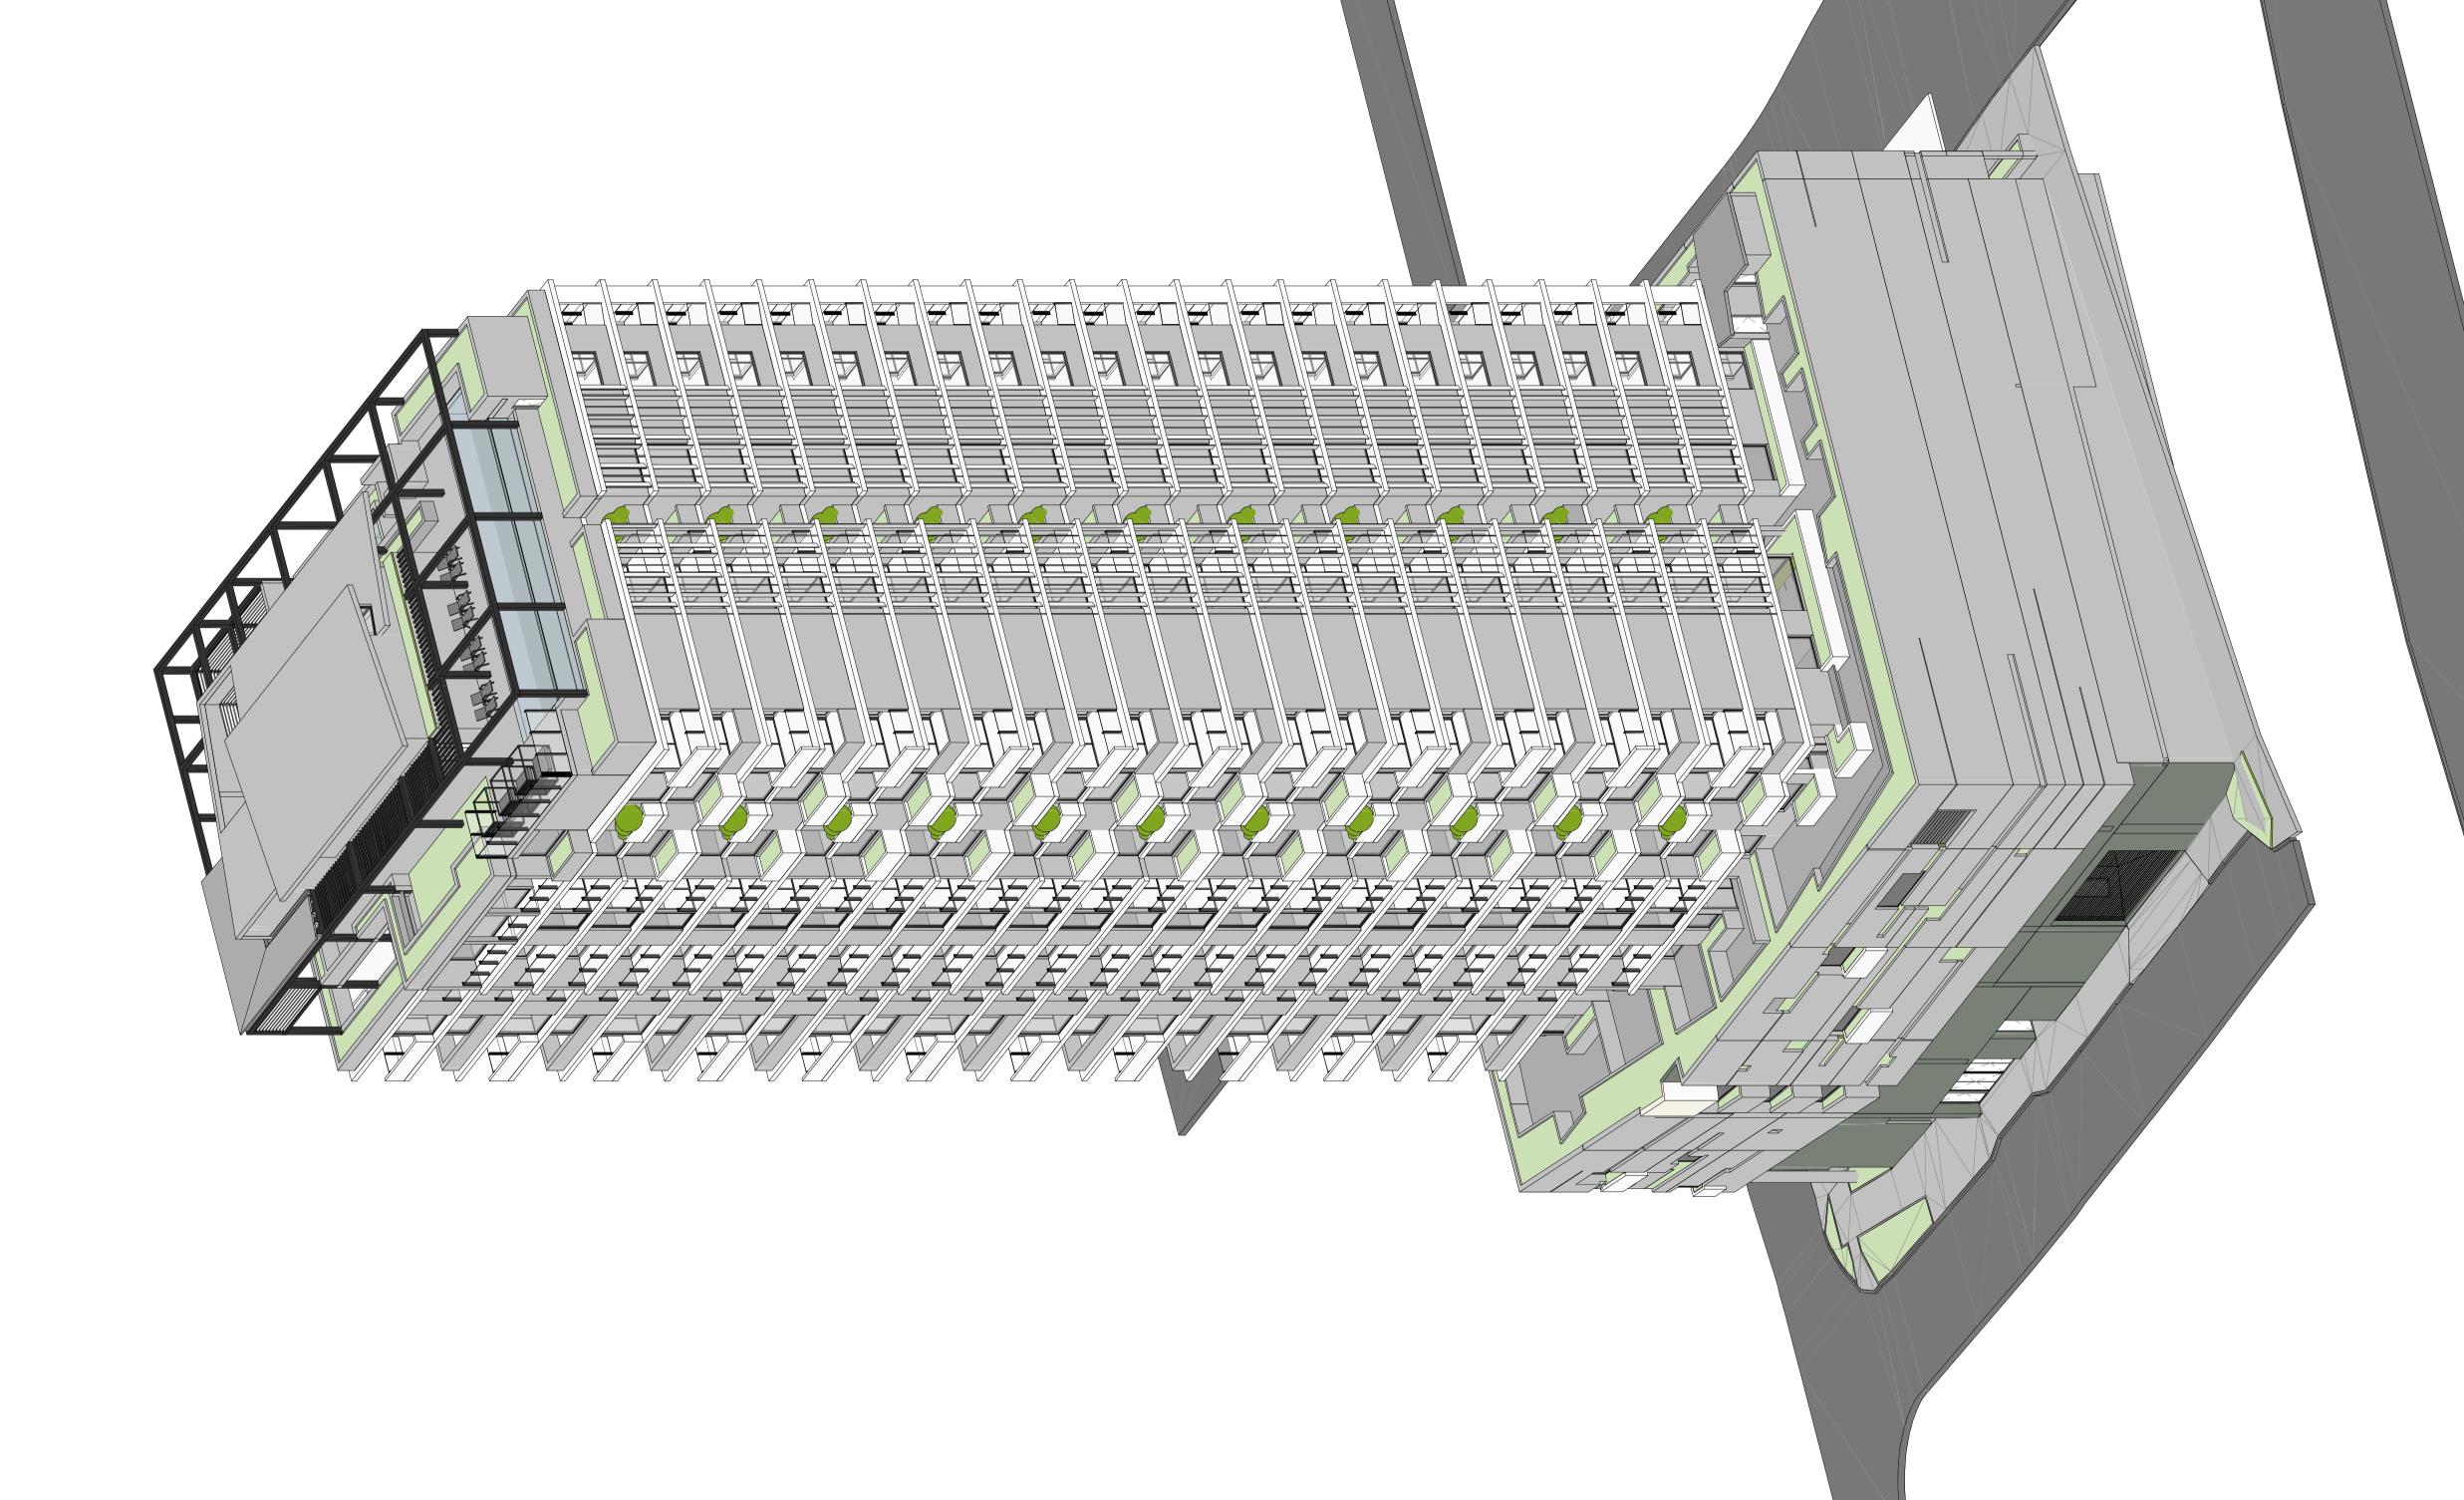 4
 Pre-DA Review issue
 2025.02.2\*

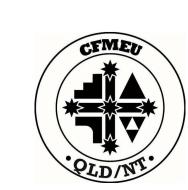 3
 Pre-DA Consultant issue
 2025.02.0\*

 2
 Design coordination issue
 2024.12.0\*

 1
 Pre-lodgment preliminary design issue
 2024.11.0\*

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Pro

Project Name
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Project Address

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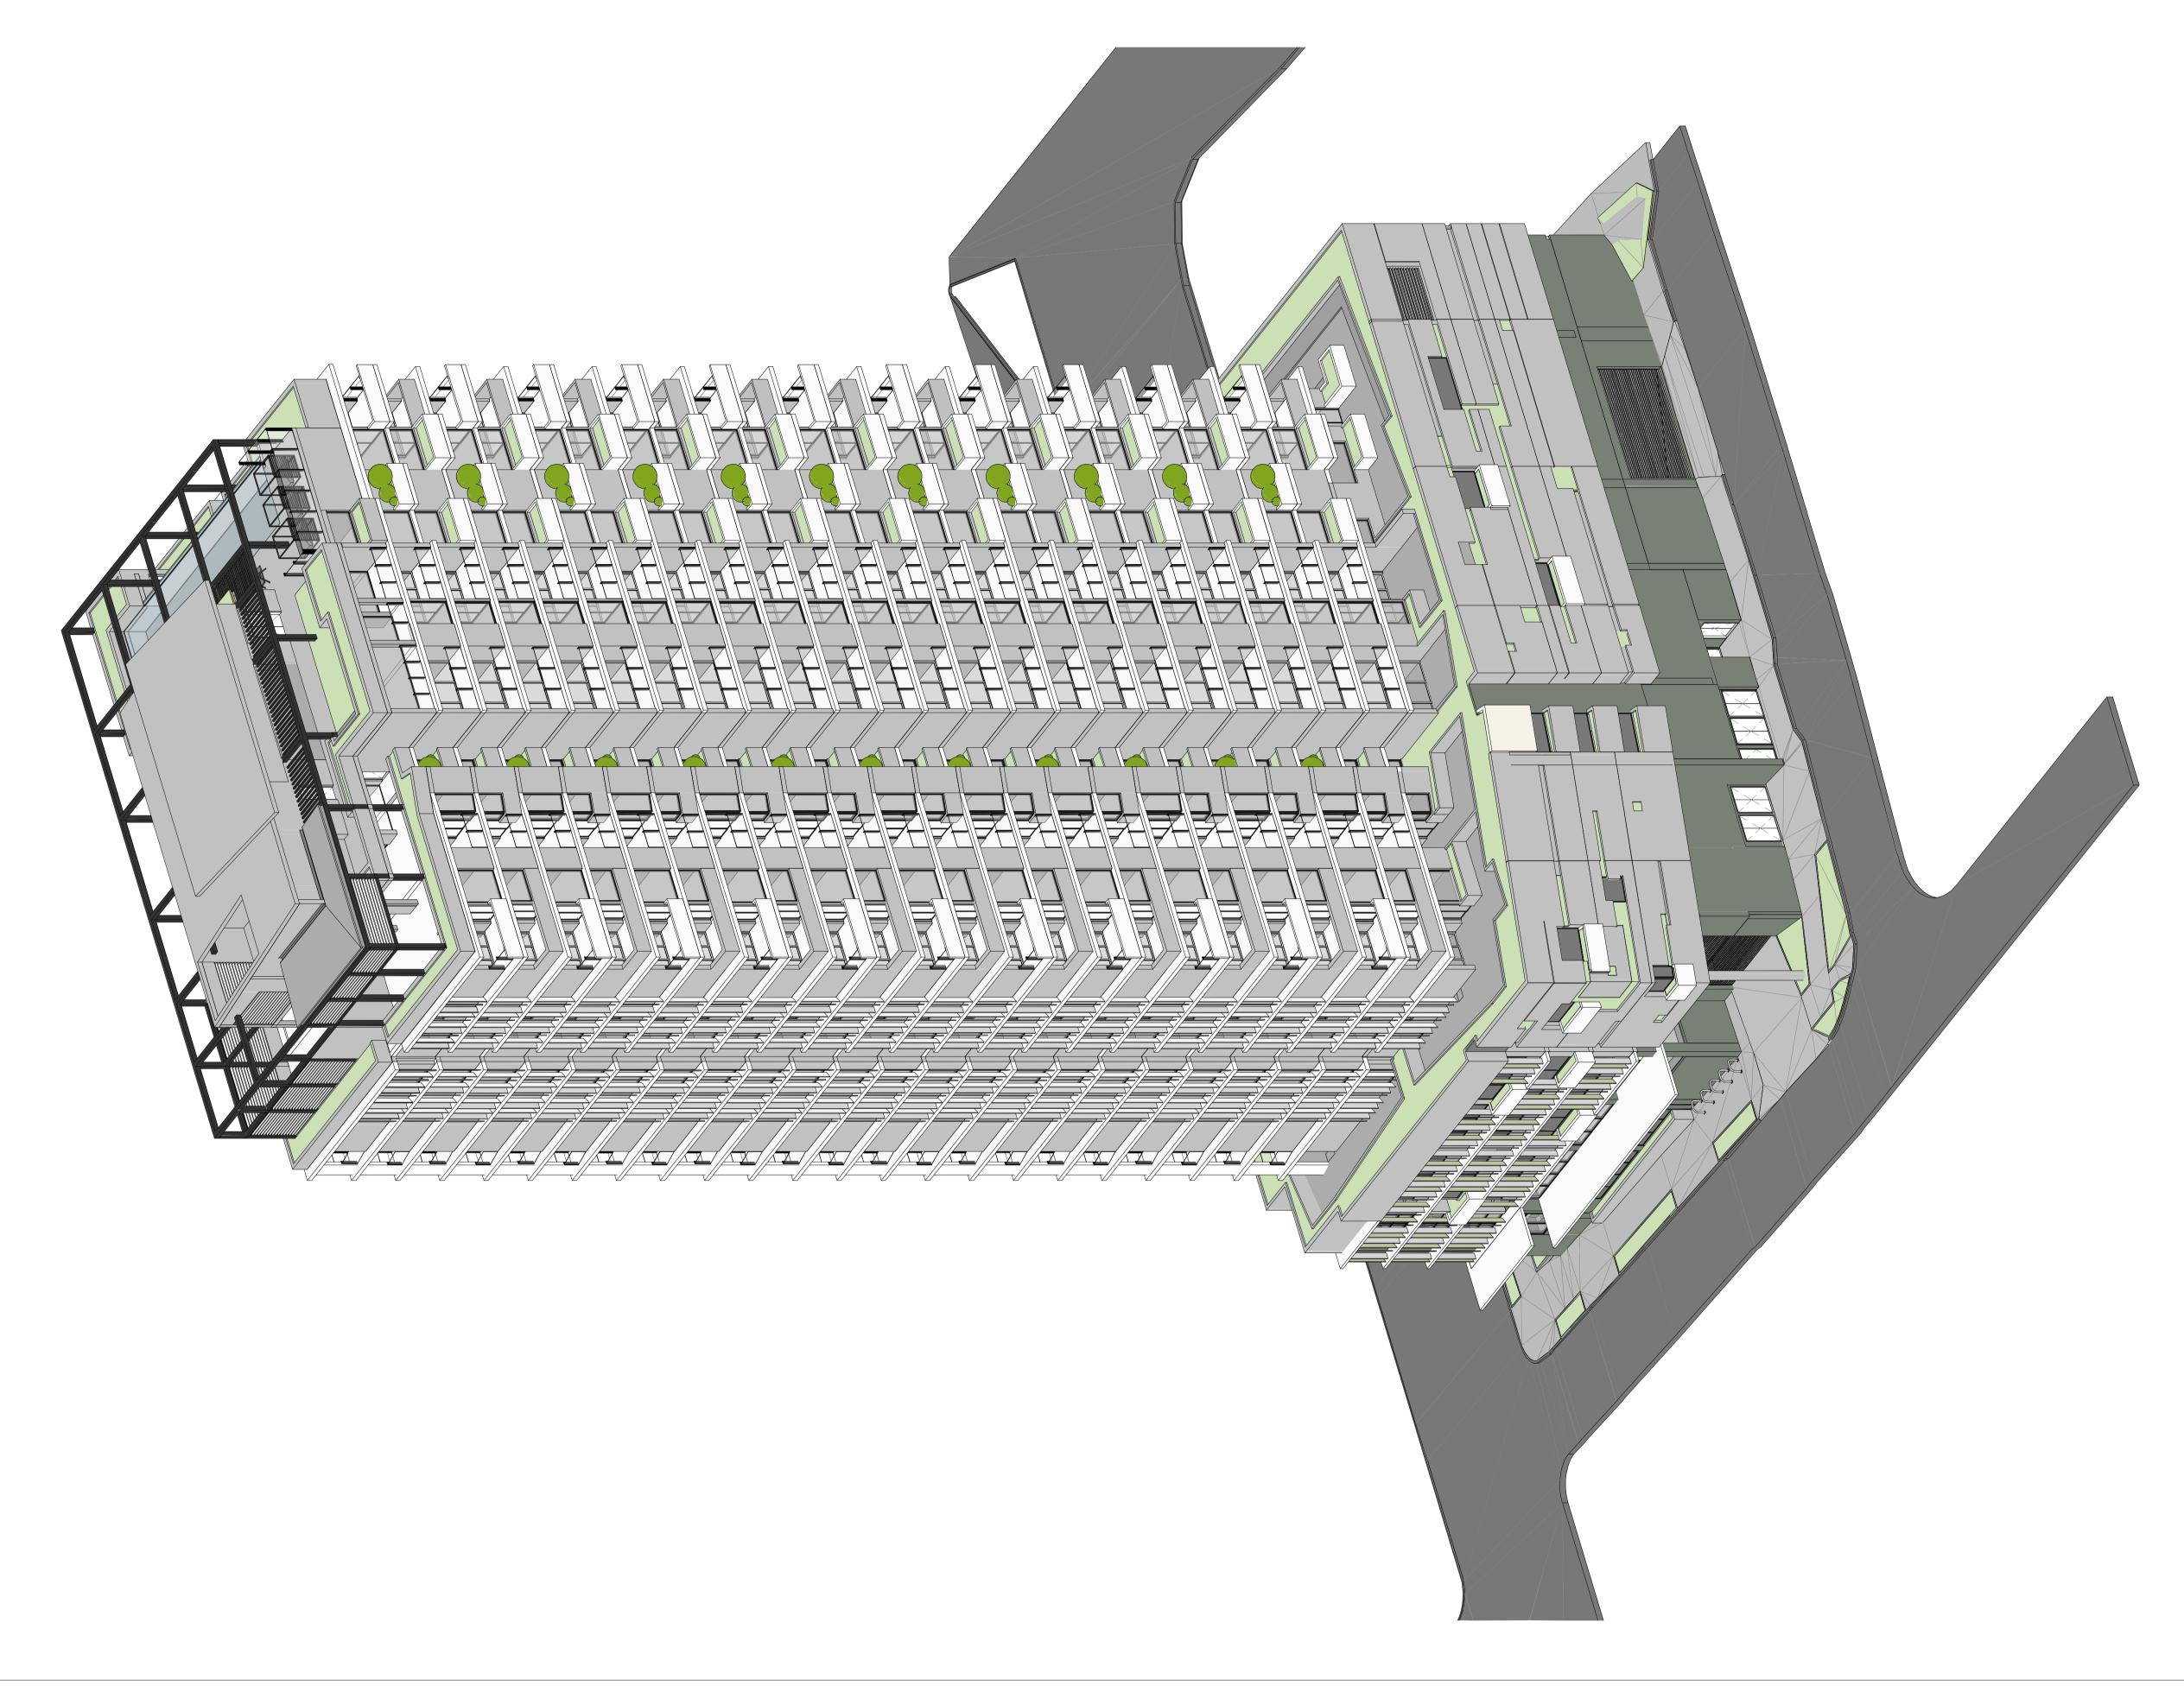
Drawing Title:
Southeast 3D Perspective

Author: Checker: Sheet Size: CL JW A1

Drawing Number: 14284\_SK32

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 Issue
 Description
 Date

 4
 Pre-DA Review issue
 2025.02.21

 3
 Pre-DA Consultant issue
 2025.02.06

 2
 Design coordination issue
 2024.12.05

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 Pre-lodgment preliminary design issue
 2024.11.05

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Project Name

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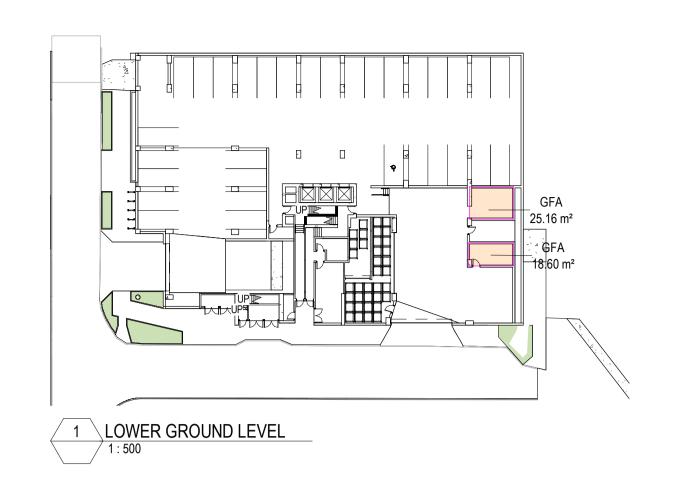
Drawing Title:
Southwest 3D Perspective


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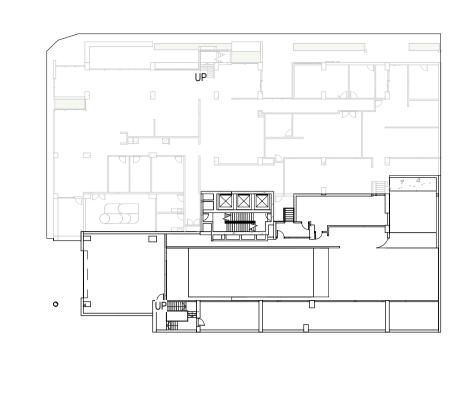
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1:200


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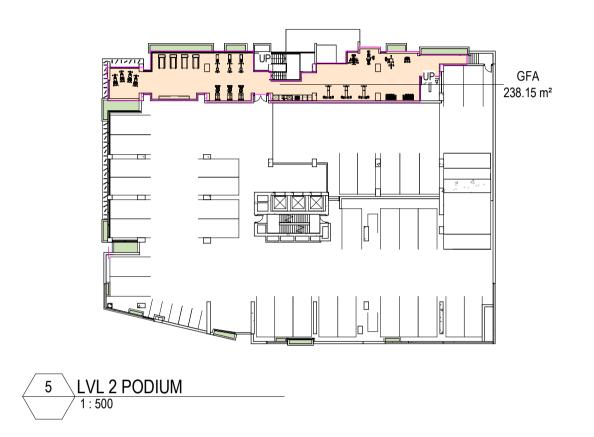








3 MEZZANINE LEVEL 1:500

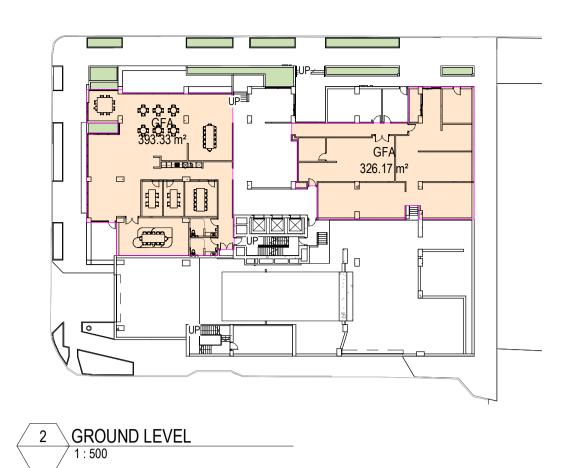

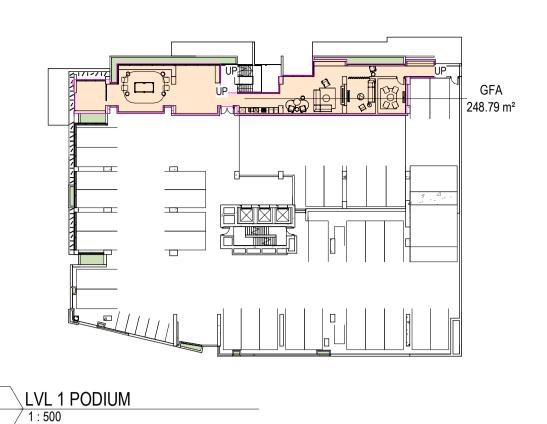


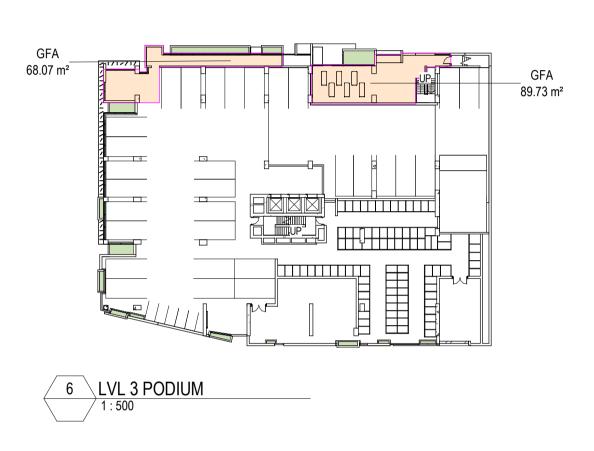

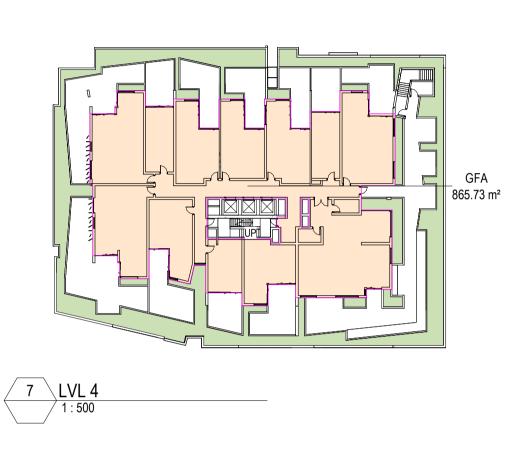





8 Apartments - LEVELS 05 - 26 (Exluding every 4th IvI)

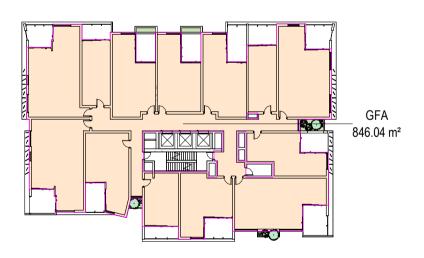



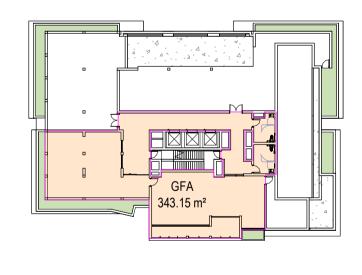



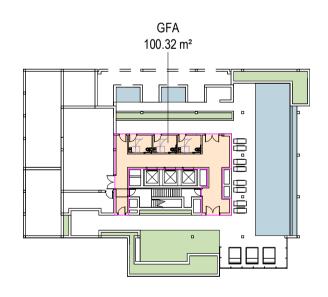

| 11 | ROOF DECK |
|----|-----------|
|    | 1:500     |

| Area Schedule (GFA) |      |                         |  |  |
|---------------------|------|-------------------------|--|--|
| Level               | Name | Area                    |  |  |
| Not Placed          | GFA  | 0.00 m <sup>2</sup>     |  |  |
| LOWER GROUND LEVEL  | GFA  | 43.75 m²                |  |  |
| GROUND LEVEL        | GFA  | 719.50 m <sup>2</sup>   |  |  |
| LVL 1 PODIUM        | GFA  | 248.79 m²               |  |  |
| LVL 2 PODIUM        | GFA  | 238.15 m <sup>2</sup>   |  |  |
| LVL 3 PODIUM        | GFA  | 157.80 m²               |  |  |
| LVL 4               | GFA  | 865.73 m²               |  |  |
| LVL 5               | GFA  | 852.83 m²               |  |  |
| LVL 6               | GFA  | 852.74 m²               |  |  |
| LVL 7               | GFA  | 852.83 m²               |  |  |
| LVL 8               | GFA  | 846.04 m²               |  |  |
| LVL 9               | GFA  | 852.83 m²               |  |  |
| LVL 10              | GFA  | 852.83 m²               |  |  |
| LVL 11              | GFA  | 852.83 m²               |  |  |
| LVL 12              | GFA  | 846.04 m²               |  |  |
| LVL 13              | GFA  | 852.83 m²               |  |  |
| LVL 14              | GFA  | 852.83 m <sup>2</sup>   |  |  |
| LVL 15              | GFA  | 852.83 m²               |  |  |
| LVL 16              | GFA  | 846.04 m²               |  |  |
| LVL 17              | GFA  | 852.83 m²               |  |  |
| LVL 18              | GFA  | 852.83 m²               |  |  |
| LVL 19              | GFA  | 852.83 m²               |  |  |
| LVL 20              | GFA  | 846.04 m²               |  |  |
| LVL 21              | GFA  | 852.83 m <sup>2</sup>   |  |  |
| LVL 22              | GFA  | 852.83 m²               |  |  |
| LVL 23              | GFA  | 852.83 m²               |  |  |
| LVL 24              | GFA  | 846.04 m²               |  |  |
| LVL 25              | GFA  | 852.83 m²               |  |  |
| LVL 26              | GFA  | 852.83 m²               |  |  |
| LOWER ROOF LEVEL    | GFA  | 343.15 m²               |  |  |
| ROOF DECK           | GFA  | 100.32 m²               |  |  |
| Grand total         |      | 21445.43 m <sup>2</sup> |  |  |

| GFA PLOT RATIOS                  |                                  |
|----------------------------------|----------------------------------|
| With roof levels GFA:            | = 21453.74 / 2101.96<br>= 10.21% |
| Without roof levels GFA:         | = 21014.58 / 2101.96<br>= 10.00% |
| Unit GFA only:                   | = 19597.04 / 2101.96<br>= 9.32%  |
| Plot area: 2101.96m <sup>2</sup> | 0.0270                           |

## **GFA GROSS FLOOR AREA DEFINITION**

Gross floor area for a building, means the total floor area of all storeys of the building, measured from the outside of the external walls and the centre of any common walls of the building, other than areas used for -

- a. Building services, plant or equipment; or
- b. access between levels; or
- c. a ground floor public lobby; or d. a mall; or
- e. parking, loading or manoeuvering vehicles; or f. unenclosed private balconies whether roofed or not

NOTE


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Areas are approximate only and are TBC by a surveyor




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|-------|---------------------------------------|-----------|
| Issue | Description                           | Date      |
| 4     | Pre-DA Review issue                   | 2025.02.2 |
| 3     | Pre-DA Consultant issue               | 2025.02.0 |
| 2     | Design coordination issue             | 2024.12.0 |
| 1     | Pre-lodgment preliminary design issue | 2024.11.0 |
|       |                                       |           |
|       |                                       |           |
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Project Address 10-16 Campbell Street, Bowen Hills





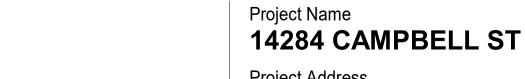

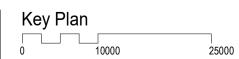


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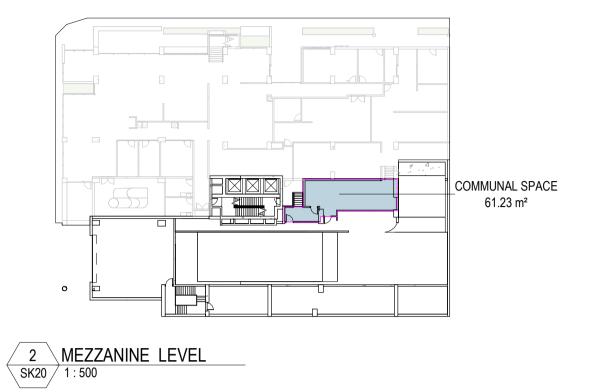



nettleton tribe partnership pty ltd ABN 58 161 683 122 85 Bowen Street, Spring Hill, QLD 4000


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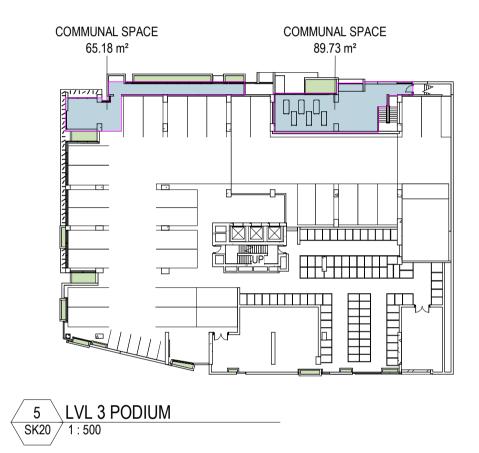





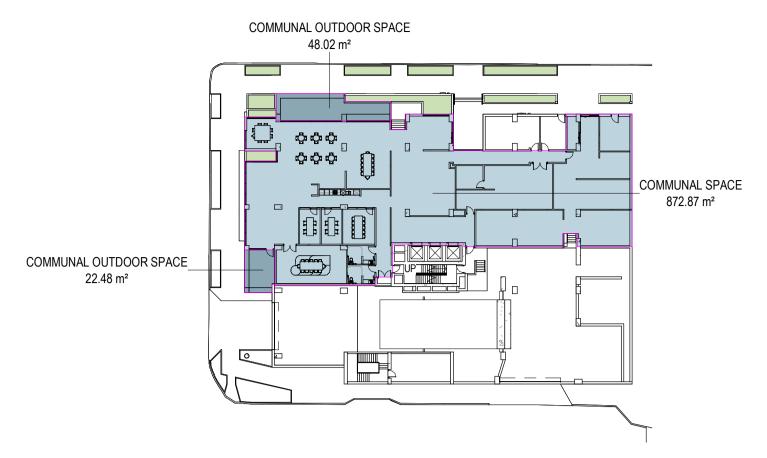





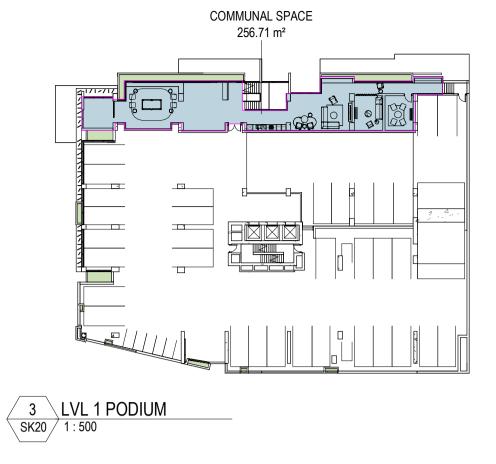

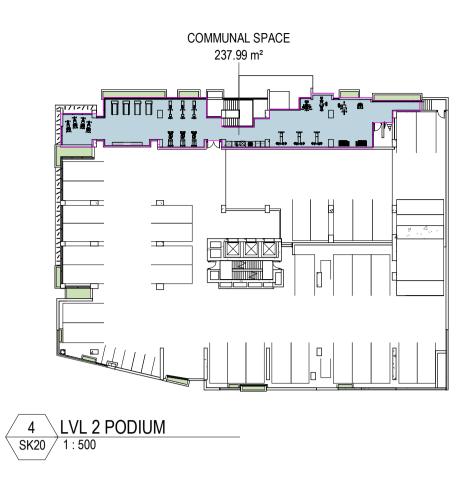

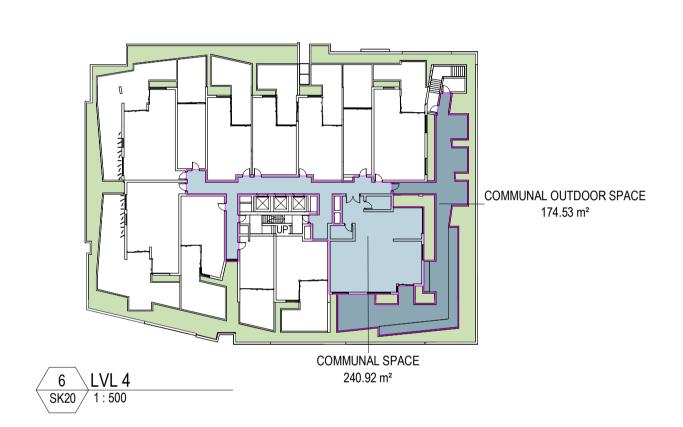

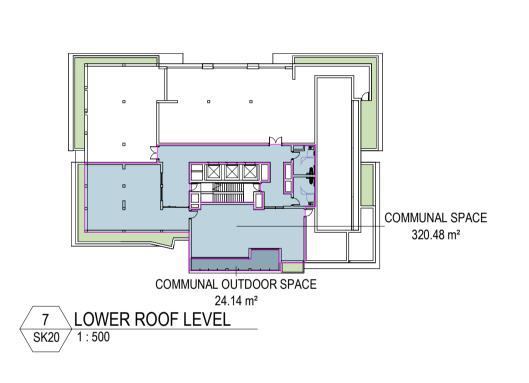


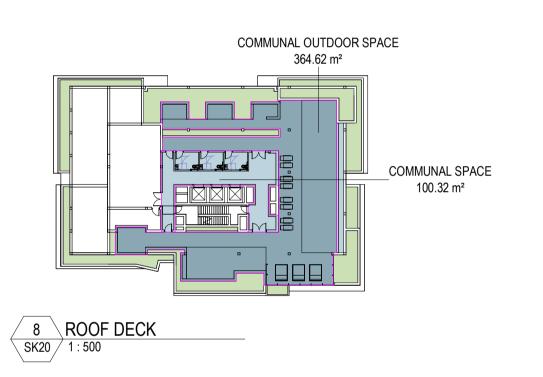

| AREA SCHEDULE (COMMUNAL SPACE) |                |                        |  |  |
|--------------------------------|----------------|------------------------|--|--|
| Level                          | Name           | Area                   |  |  |
| GROUND LEVEL                   | COMMUNAL SPACE | 872.87 m <sup>2</sup>  |  |  |
| MEZZANINE LEVEL                | COMMUNAL SPACE | 61.23 m <sup>2</sup>   |  |  |
| LVL 1 PODIUM                   | COMMUNAL SPACE | 256.71 m <sup>2</sup>  |  |  |
| LVL 2 PODIUM                   | COMMUNAL SPACE | 237.99 m²              |  |  |
| LVL 3 PODIUM                   | COMMUNAL SPACE | 89.73 m <sup>2</sup>   |  |  |
| LVL 3 PODIUM                   | COMMUNAL SPACE | 65.18 m <sup>2</sup>   |  |  |
| LVL 4                          | COMMUNAL SPACE | 240.92 m <sup>2</sup>  |  |  |
| LVL 5                          | COMMUNAL SPACE | 2.79 m <sup>2</sup>    |  |  |
| LVL 5                          | COMMUNAL SPACE | 3.11 m <sup>2</sup>    |  |  |
| LOWER ROOF LEVEL               | COMMUNAL SPACE | 320.48 m <sup>2</sup>  |  |  |
| ROOF DECK                      | COMMUNAL SPACE | 100.32 m <sup>2</sup>  |  |  |
|                                |                | 2251.34 m <sup>2</sup> |  |  |


| AREA SCHEDULE (COMMUNAL OUTDOOR SPACE) |                        |                       |  |  |  |
|--|------------------------|-----------------------|--|--|--|
| Level                                  | Name                   | Area                  |  |  |  |
| GROUND LEVEL                           | COMMUNAL OUTDOOR SPACE | 48.02 m²              |  |  |  |
| LVL 4                                  | COMMUNAL OUTDOOR SPACE | 174.53 m²             |  |  |  |
| LOWER ROOF LEVEL                       | COMMUNAL OUTDOOR SPACE | 24.14 m²              |  |  |  |
| ROOF DECK                              | COMMUNAL OUTDOOR SPACE | 364.62 m²             |  |  |  |
| GROUND LEVEL                           | COMMUNAL OUTDOOR SPACE | 22.48 m²              |  |  |  |
|  |                        | 633.80 m <sup>2</sup> |  |  |  |



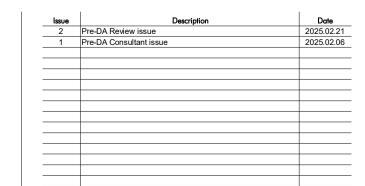

Builder and/or subcontractors shall verify all project dimensions before commencing on-site work or off-site fabrication. Figured dimensions shall take precedence over scaled dimensions. This drawing is copyright and cannot be reproduced in whole or in part or by any medium without the written permission of Nettleton Tribe Partnership Pty Ltd.

Project Name
14284 CAMPBELL ST

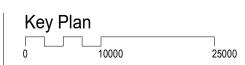





**A**1 14284\_SK41



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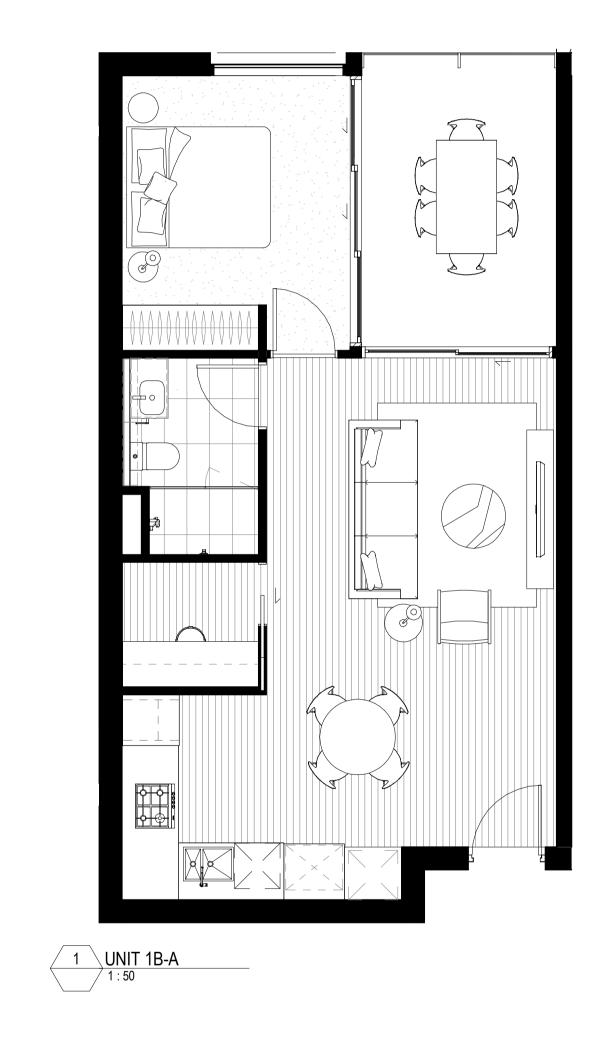
Project Address
10-16 Campbell Street, Bowen Hills


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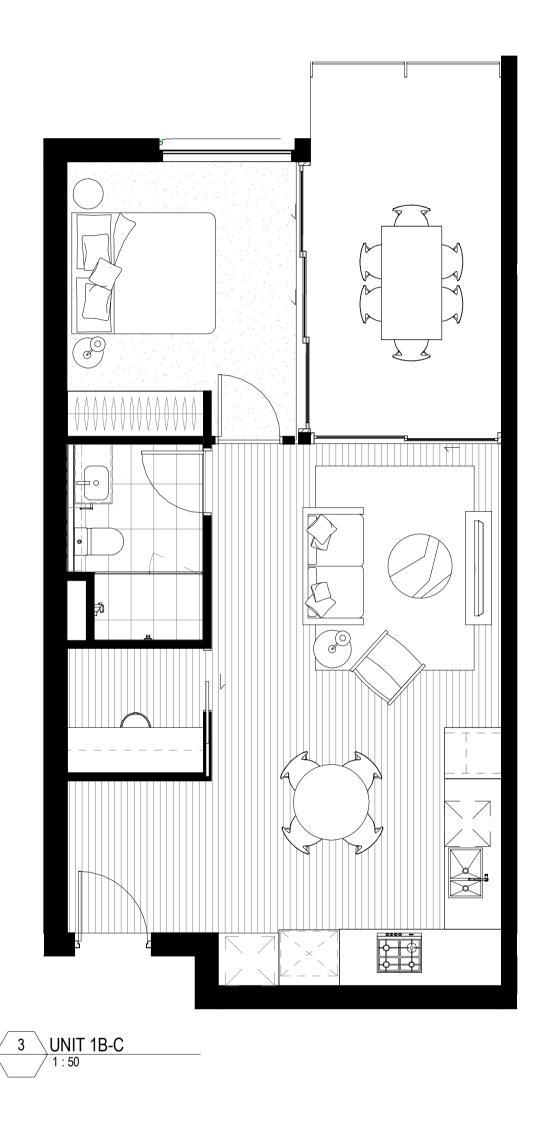
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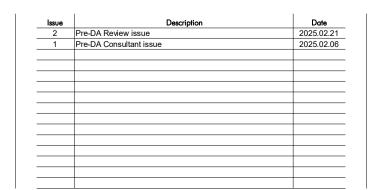
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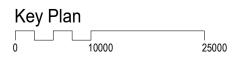










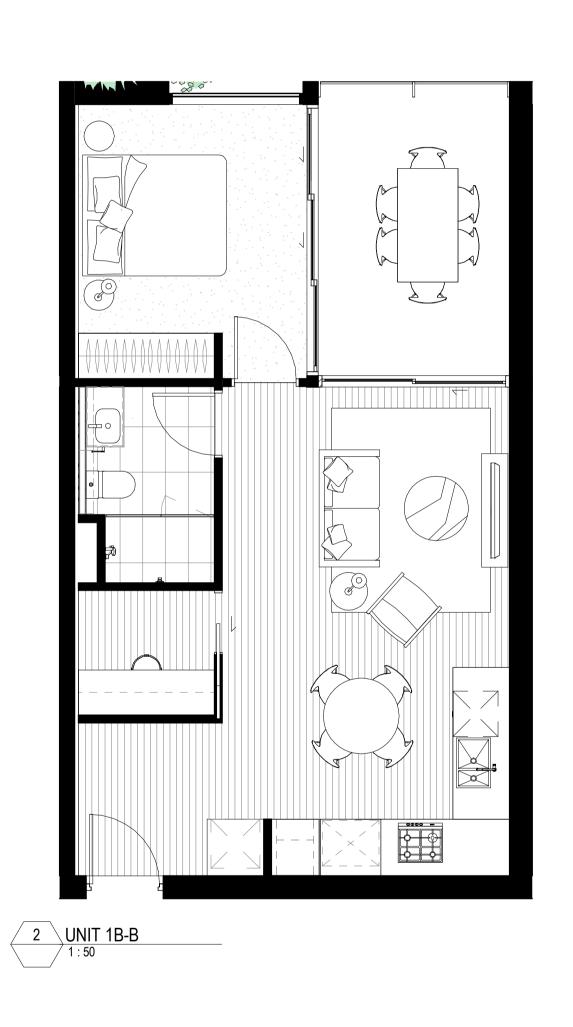












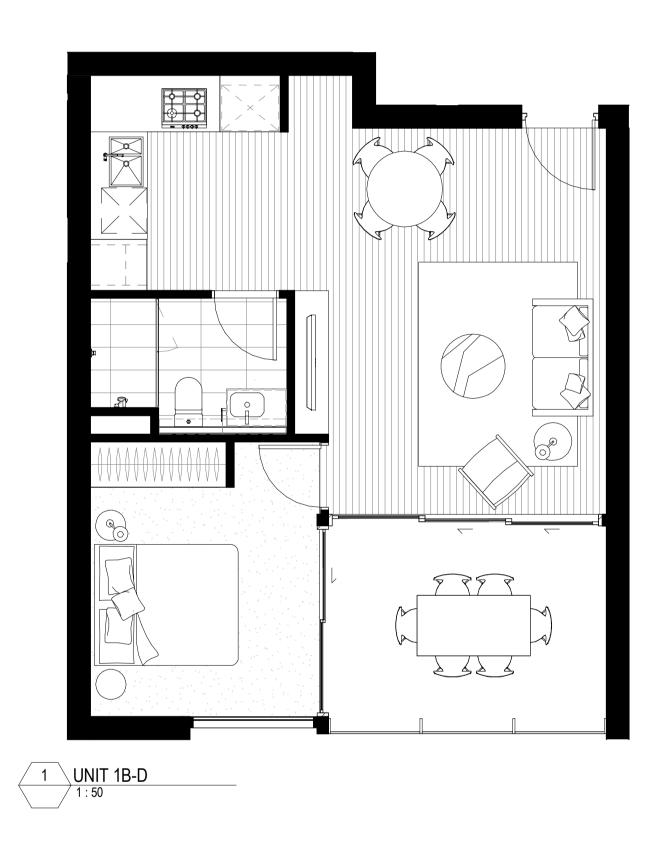


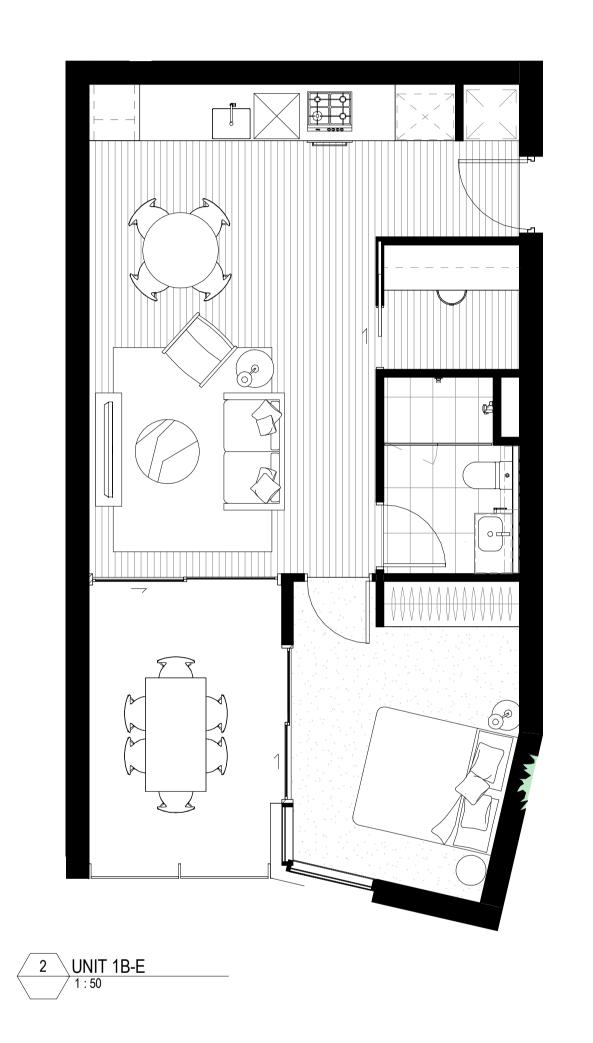


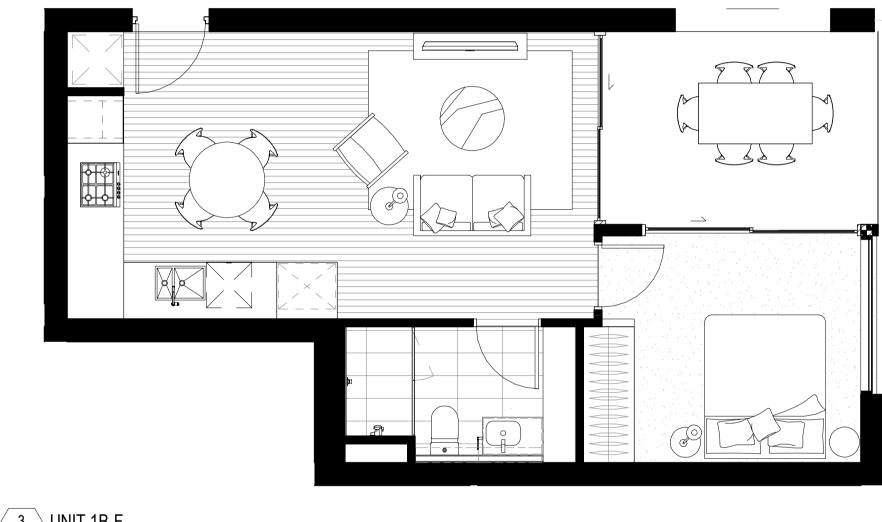


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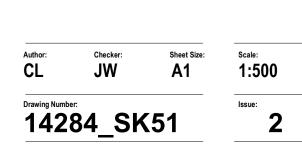




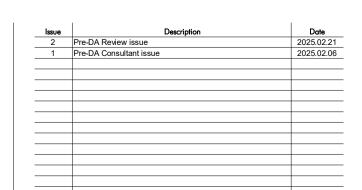


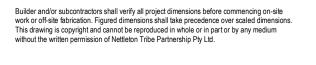





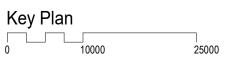




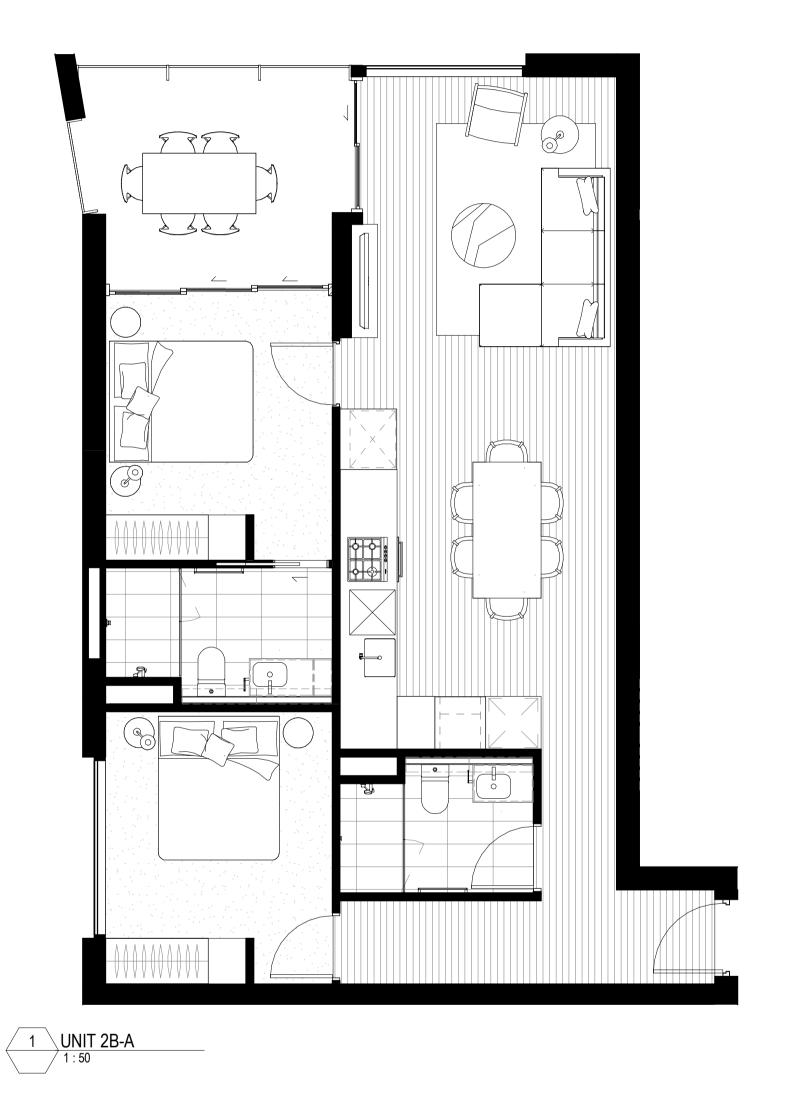


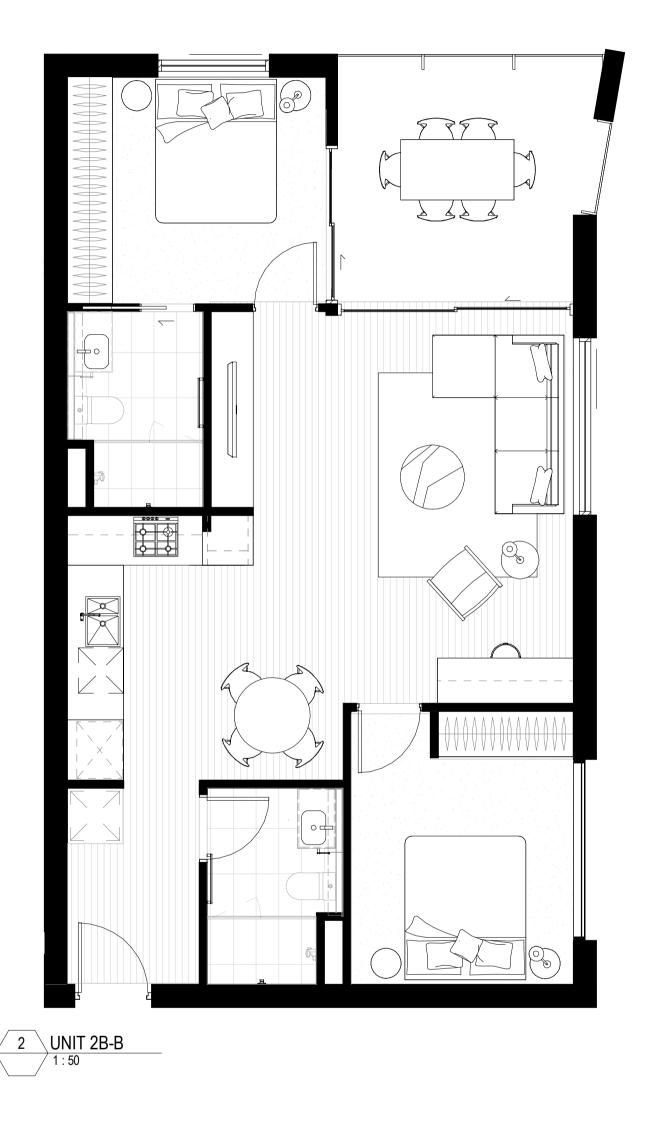

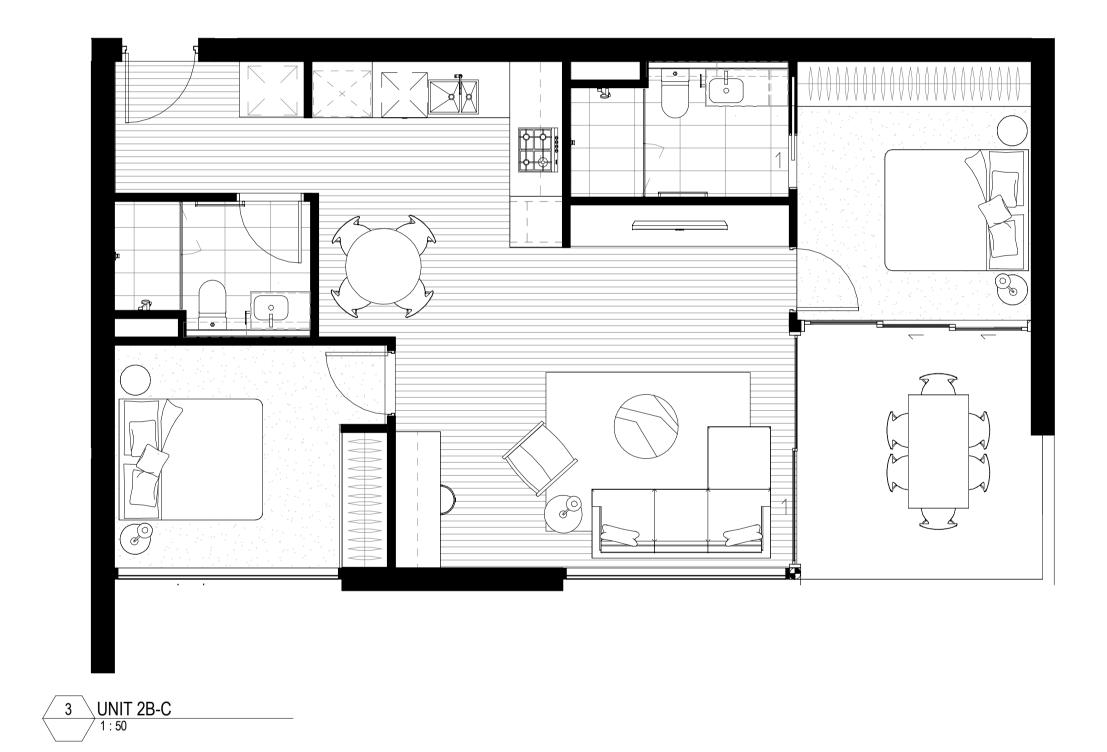




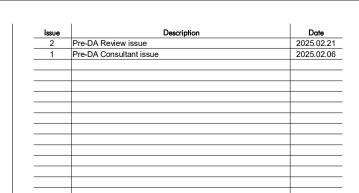

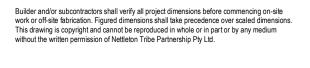



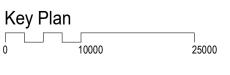













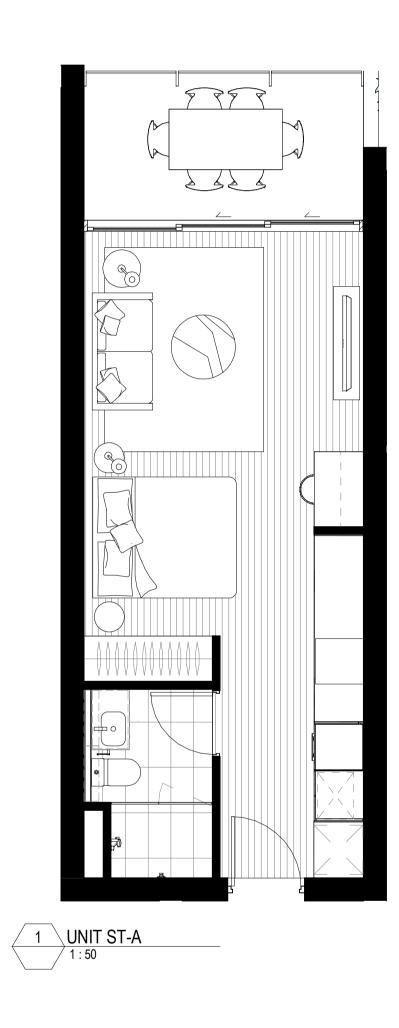


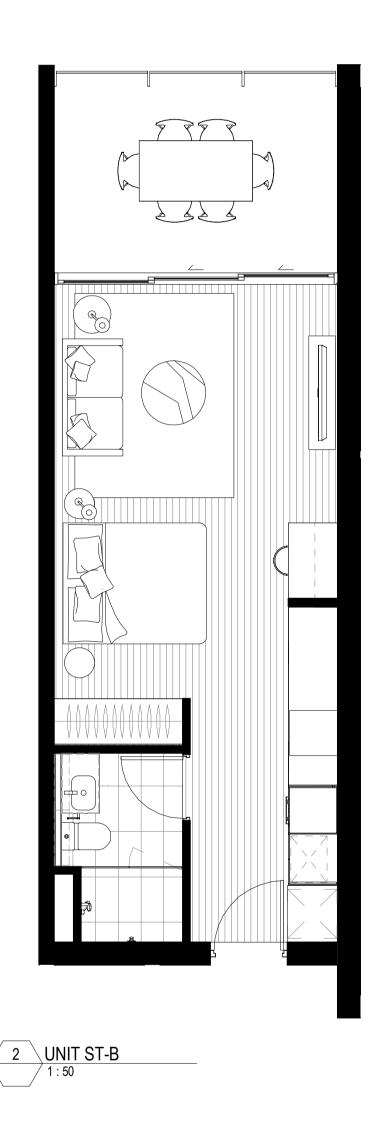

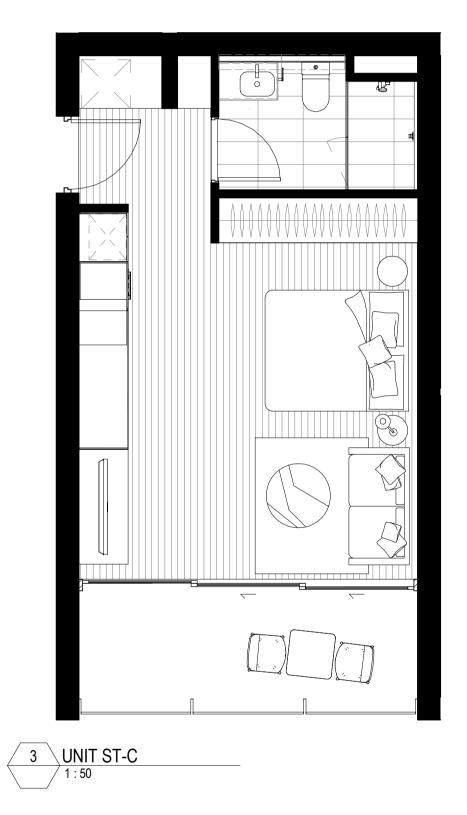





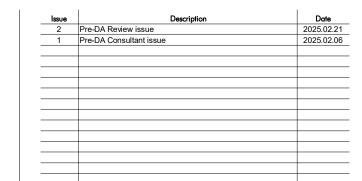

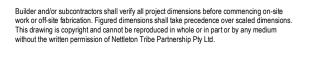



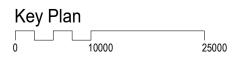

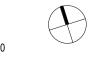



Author: Checker: Sheet Size: Scale: CL JW A1 1:50

Drawing Number: Issue:





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