

19-25 Campbell Street, Bowen Hills

Architectural Design Report

16 August 2024

Rev. F

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A: ARCHITECTURAL DRAWINGS

B: SURVEY



01 Introduction

The project is located on Campbell Street, Hazelmount and Edgar Street block, where the existing site currently contains a collection of one and two storey businesses, some with off street parking. The site is within the Bowen Hills Priority Development Area and zoned mixed use. To the west of the site, across Hazelmount Street is Madison Heights Apartments at 30 storeys and Panorama tower at 30 storeys. To the north nearby is the Bowen Hills railway station. To the east is largely residential and to the south is Fortitude Valley and Brisbane City beyond.

The proposal provides a new 34 storey residential tower with basement and podium parking, podium communal areas and retail and activated uses on ground level. The proposal has been designed as a built-to-rent tower. Build to rent refers to a residential development in which all apartments are owned by the developer and are leased out to tenants. For the design, this means provision of enhanced residential facilities and amenities tailored to the rental market and a unit mix suited to the rental demographic.

The design anticipates increased pedestrian activation along Hazelmount Street and addresses the footpath treatment, ground floor activation and podium treatment with careful consideration of future use. Proposed increases to the width of existing footpath verges and an anticipated road widening on Campbell street has also informed the ground plane design and treatment.


The Queensland sub-tropical climate is reflected in the landscape design with planted edges and shady undercroft pedestrian paths. A tropical green language is used to assist with podium screening and provides a multi-faceted layering of detail. The tower extends this concept with planted edges and balconies between a private landscaped communal podium and a landscaped rooftop pool area.

The proposal responds to a range of factors to provide livability within the rental market in the Bowen Hills precinct. The built form delivers a range of apartment types, private common spaces and street activation with retail tenancies and common uses spaces.



19-25 Campbell Street, Bowen Hills

O 1 Context

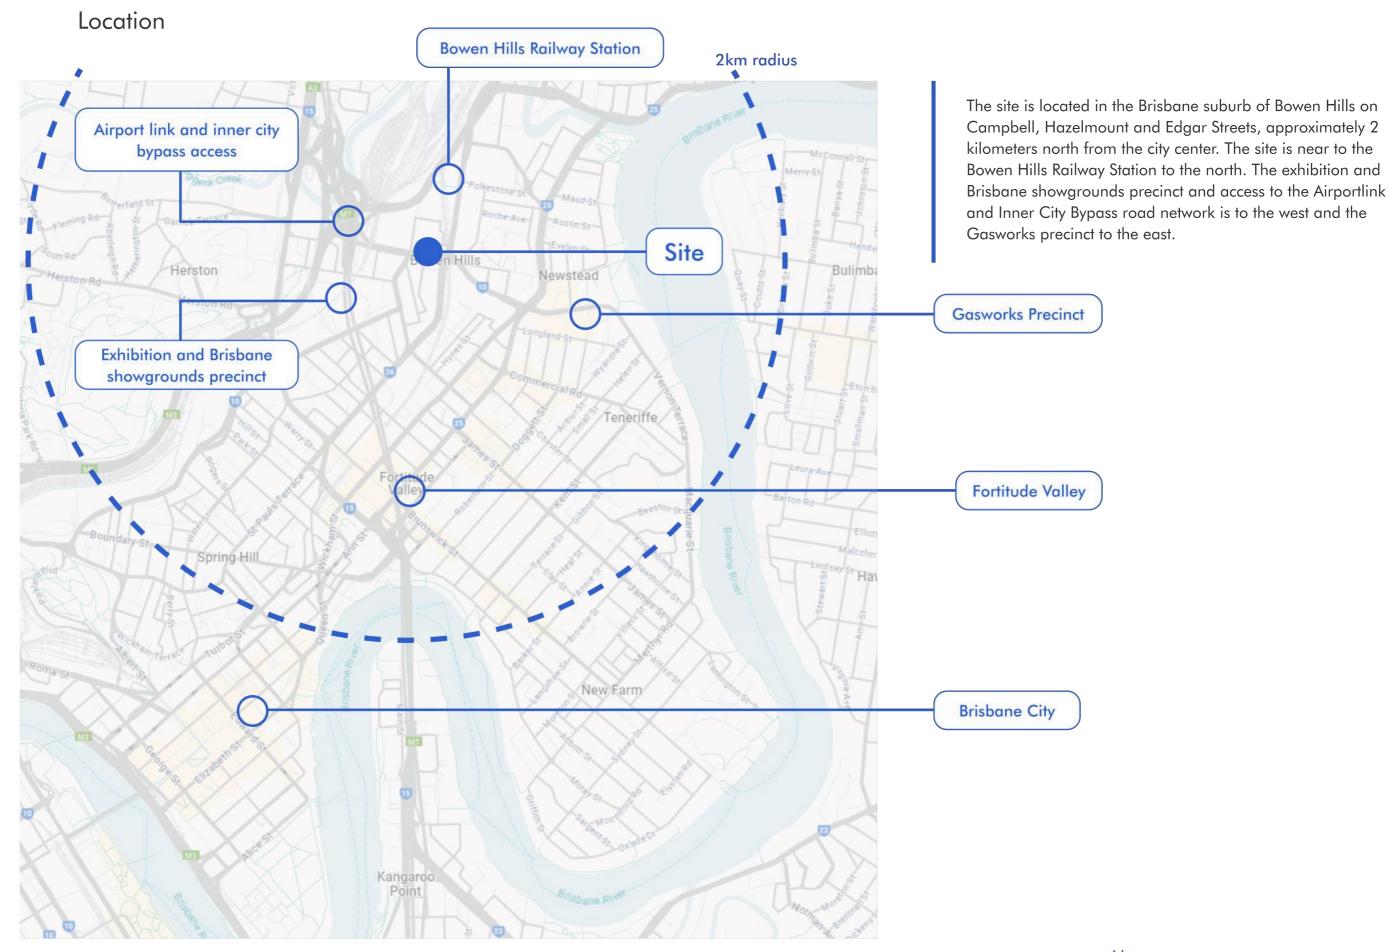



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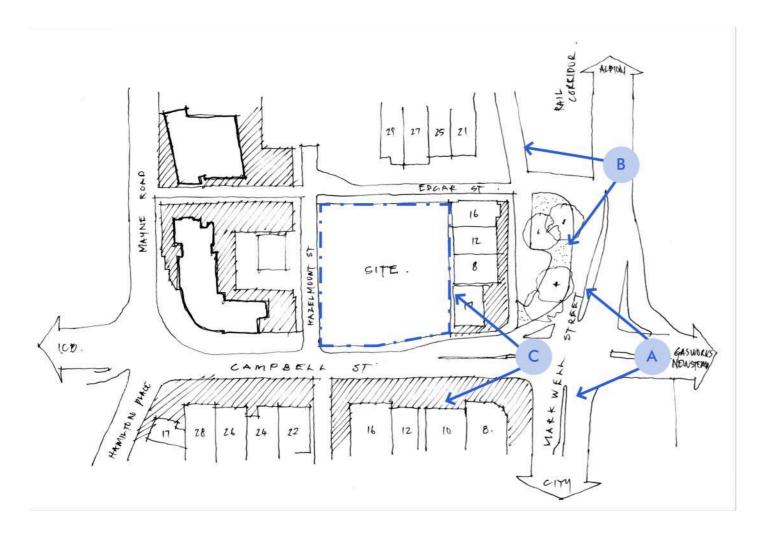




NORTHERN VIEW

19-25 Campbell Street, Bowen Hills

Street Views



The site is visible from Markwell Street in both directions when crossing Campbell Street. Also, the Montpelier Road intersection at the Markwell Street and Campbell Street junction provides views across the Jamison Street businesses toward the site.







View from Montpelier Road toward site


View from Markwell Street toward site



Campbell Street




Street Views

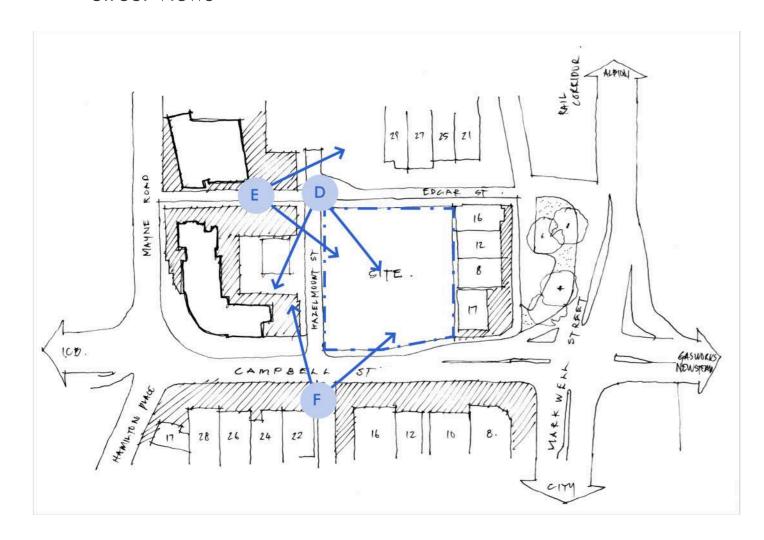

The views from Hazelmount and Edgar street show the existing one and two storey businesses across the site with some off-street parking. Across Hazelmount to the west is the driveway ramping to the neighboring Madison Heights apartments. At the Campbell Street end of Hazelmount is the green bladed screening of podium parking to the Madison Heights Apartments.





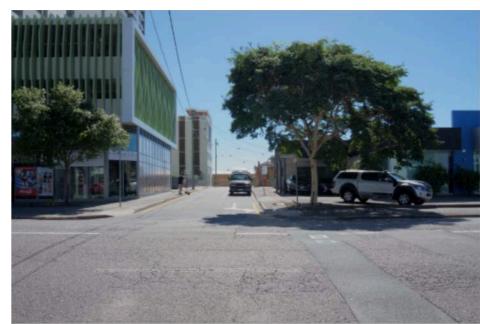


D Hazelmount Street looking south

E Edgar Street looking east

F Campbell St and Hazelmount St Corner



Site Analysis

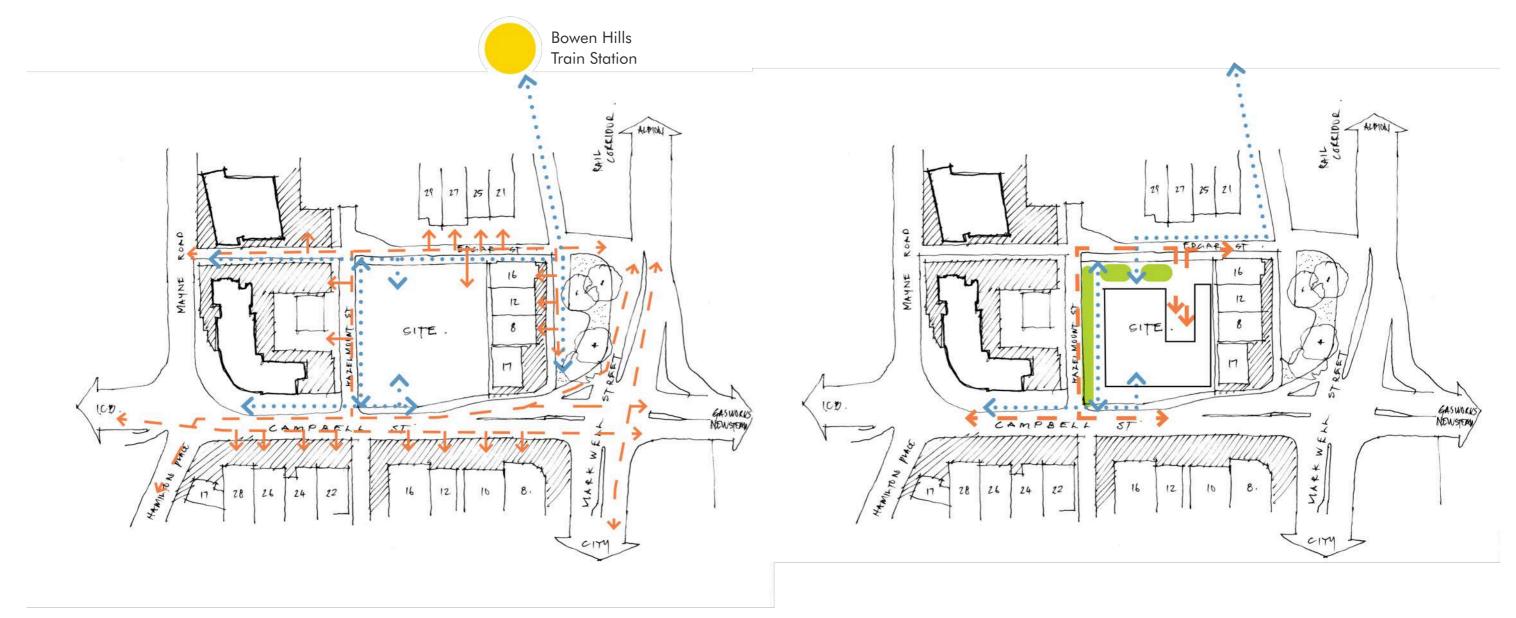

Traffic + Pedestrian Analysis

Traffic + Pedestrian Site Response


A pedestrian analysis shows strength in the pedestrian connection that exists from the south of the site travelling north to the Bowen Hills train station (and vice versa). This places significant importance on the pedestrian treatment, permeability, safety and experience along the Hazelmount Street verge on our side of the road.

Vehicle servicing and drop-off will be difficult along the busy Campbell Street frontage and the secondary streets of Hazelmount and Edgar serve as more suitable locations for servicing the building. Vehicle access is proposed off Edgar Street.

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Site Analysis




Land Use + Activation Analysis

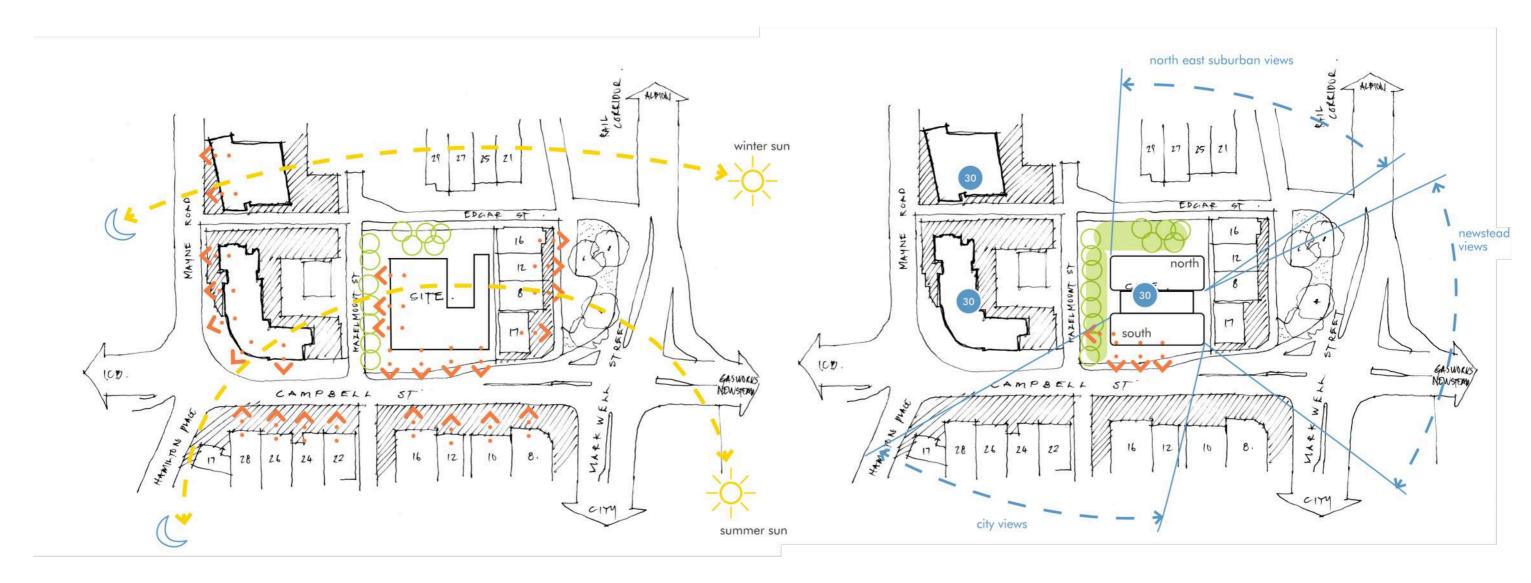Views + Open Space Site Response


The existing land use and activation shows a series of one and two storey small businesses flanked by the large residential towers of Madison Heights, Code Apartments and the Richmond Apartments to the south.

The sites' primary address, Campbell Street, is on the southern side of the site. The summer sun reaches the east, north and west facades with some western shading expected from the existing Madison Heights towers.

Views to the north-east are uninterrupted across Albion and beyond and views to the west are uninterrupted across Newstead toward the Brisbane River. The south offers elevated city views across the Richmond and Code apartments and over the Sullivan Nicolaides Pathology Lab.

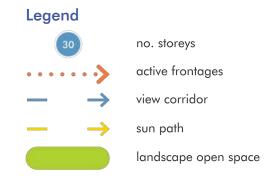

Surrounding Views

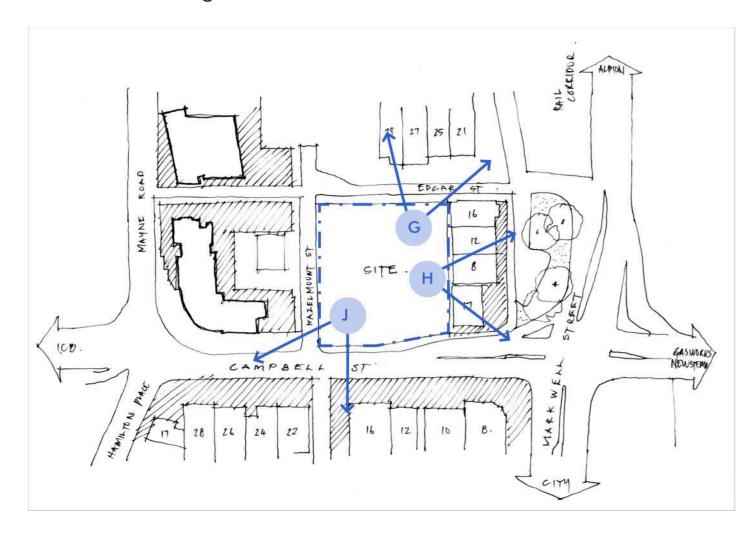

Views to the north-east are uninterrupted across Albion and beyond and views to the east are uninterrupted across Newstead toward the Brisbane River. The south offers elevated city views across the Richmond and Code apartments and over the Sullivan Nicolaides Pathology Lab.








North east suburban views

Newstead views

City views



Ground Floor Amenity

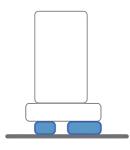

activated streetscape lined with retail and common spaces, and a cross-site lobby link work to create a permeable ground plane...a celebration of the Queensland sub-tropical climate through planted edges, shady undercroft pedestrian paths and an open-air strategy










Podium Facade

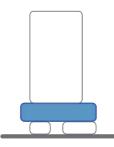

a tropical green language...perforated undercroft enclosures, perforated metal detailing, screening and the dappled shade of planting and landscape creates a multifaceted layering of detail and light and shadow...










Tower Architecture

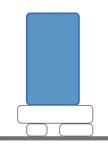

tower facade articulation through horizontal slab projections, alterations in balustrade heights, the reveal of balconies and planted edges












Ground + Rooftop Common Areas

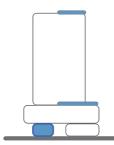

quality indoor + outdoor common areas that provide amenity to residents...a place to catch up with friends, to quietly relax, to work or to swim...creating a wholistic living environment for residents

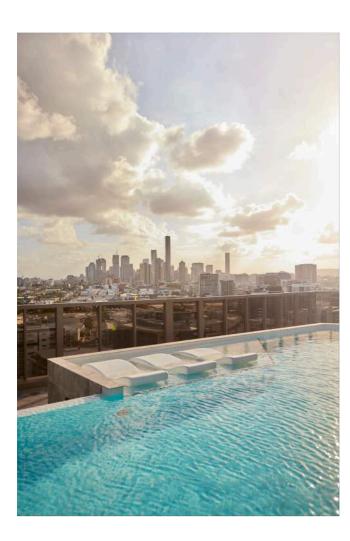




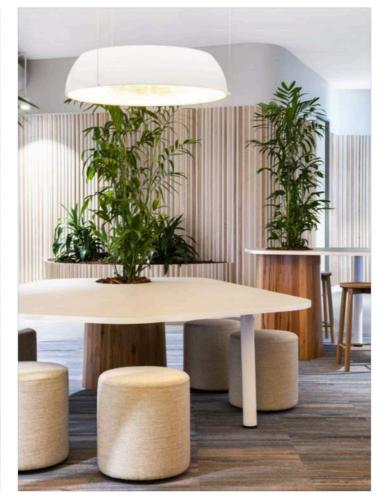



19-25 Campbell Street, Bowen Hills

Design Concept

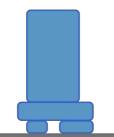

analysis of the topography has informed the design and landscape treatment generating flowing forms and green edges







Podium Development

The desire to integrate natural elements into our interior spaces and provide meaningful connection to outdoor spaces is one of the most desirable aspects of Queensland residential architecture. Good residential design provides a meaningful connection to outdoor spaces allowing residents to be connected to nature. These connections have been shown to alleviate stress, providing a health and well being benefit to residents. Proof that physical connection to nature is beneficial to residents' mental health is becoming clearer and the incorporation of biophilic design into residential environments is becoming a basic requirement in the design process.

Indoor outdoor connections add value to the daily life of residents and contribute to the mental health of building occupants. With that in mind, the proposed development at Campbell street Bowen hills seeks to provide a series of connected spaces where the natural environment is incorporated into the everyday movement and tasks of the building occupants.

The site is located on the top of a ridge line, occupying a location that is bounded by three streets to the north, west and south. The site is visually prominent from all sides. Pedestrian traffic currently moves around the edges however the site sits in a direct line which connects the Bowen Hills Rail and the route to the Brisbane Exhibition showgrounds development area.

The proposal seeks to connect and emphasize this route providing a landscaped internal laneway link through the site. Located along the laneway edges are retail spaces, active resident spaces and management functions. The site edges open to the three street frontages with retail spaces and building entrances. Wider footpath setbacks have been incorporated to deliver additional landscaping on


ground to the perimeter than is typically provided.

Vehicles are housed in a below ground carpark and above ground podium parking. The edge of the podium parking is sleeved with residential communal functions on the Campbell street frontage and partially along the Hazelmount frontage. The podium edges are designed to act as additional layers of site contours which meander around the street edge moving in and out to create vertical space for street tree canopies to fill as they grow. The other frontages are filled with planted landscape verges which terrace back and allow plants to spill over the edges, further softening the built form. The planters provide the building occupants with a connection to the natural environment on these levels and provide a breathing façade to ventilate the parking levels.

Further above, the tower is designed in a H shape configuration which is pulled apart on the South and North to allow the lift lobby spaces access to light, cross ventilation and planted zones. The intention is to provide these natural connections at each "stop" point for residents, the Lobby, The Carpark and the Lift landings. This creates a more continuous connection to the natural environment.

Similarly, the buildings residential shared zones are spread between Ground, Podium and Roof, with each space providing a variety of smaller functional spaces which sit in the landscape.

Connecting occupants with the natural environment is a proven way to enhance the health and wellbeing of residents and a critical component of a build to rent scheme such as this.

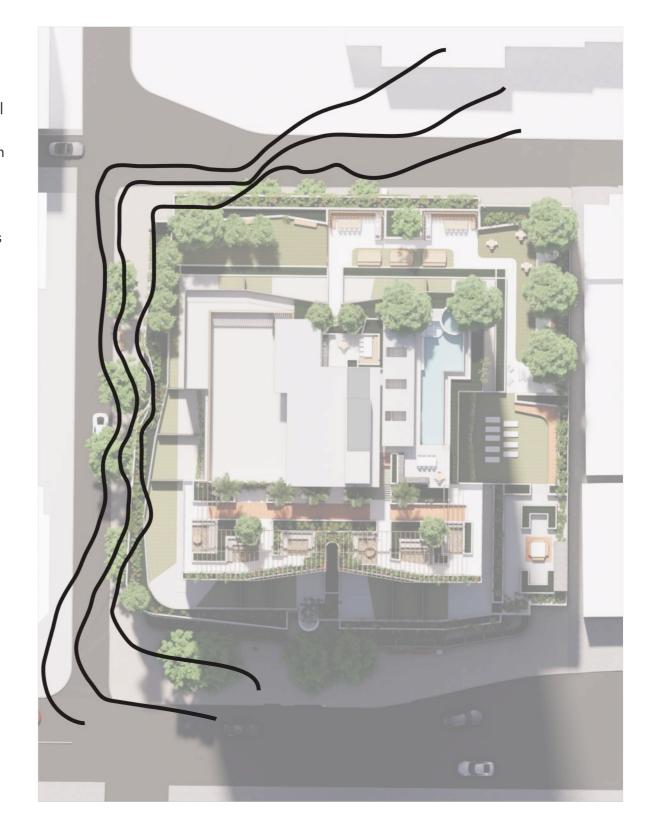



Podium Development


Key to development of the ground plane design is the pedestrian movement and positioning of active uses. The proposal incorporates a through block lobby between Campbell and Edgar Street with access to the Hazelmount edge. This provides maximum flexibility for occupant movement and access for all three frontages.


Retail and active uses are proposed on Campbell Street and Hazelmount Street to complement the active use along the broader Campbell street extent.

The public pedestrian route, along the activated Campbell Street, deviates under the podium to the north.

Vehicle entry and exit and services has proposed access off Edgar Street leaving Campbell Street free for uninterrupted traffic flow.


Key:

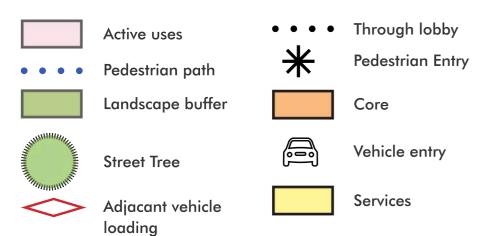

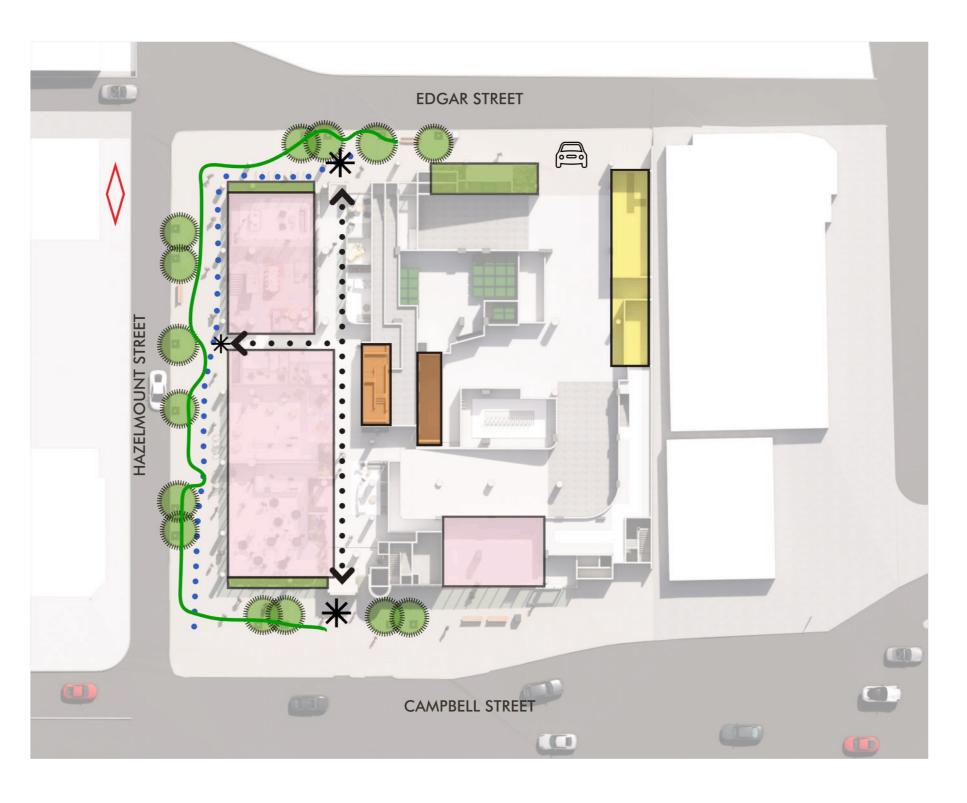




Edgar Street Edge Sections

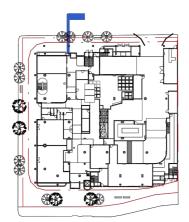

A proposed increase to the Edgar Street verge to 2.5m provides an increased pedestrian movement zone at ground level. The proposal seeks to maintain an unencumbered area at ground level to achieve this. Above level 1, the proposal encroaches on the new verge zone and remains within the existing property boundary.



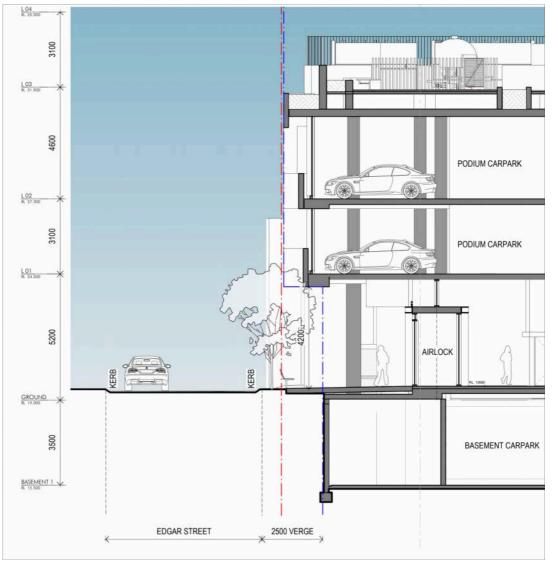


Existing Property
Boundary

Boundary

Proposed Property

Campbell Street Edge Sections

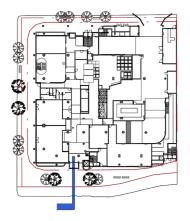

A proposed future road widening on Campbell Street and subsequent verge widening to 3.75m has resulted in significant resumption from the existing property boundary. The proposal seeks to maintain a road widening and unencumbered verge at ground level to achieve this.






Existing Property
Boundary


Proposed Property

Boundary

Hazelmount Street Edge Sections

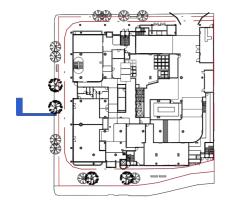

A proposed increase to the Hazelmount Street verge to 3.75m provides an increased pedestrian movement zone at ground level. The proposal seeks to maintain an unencumbered area at ground level to achieve this. Ground level and below remains unencumbered by the increased verge. At level 1 to level 2, the amount of encroachment varies along the length of Hazelmount Street as identified in the plan drawings.

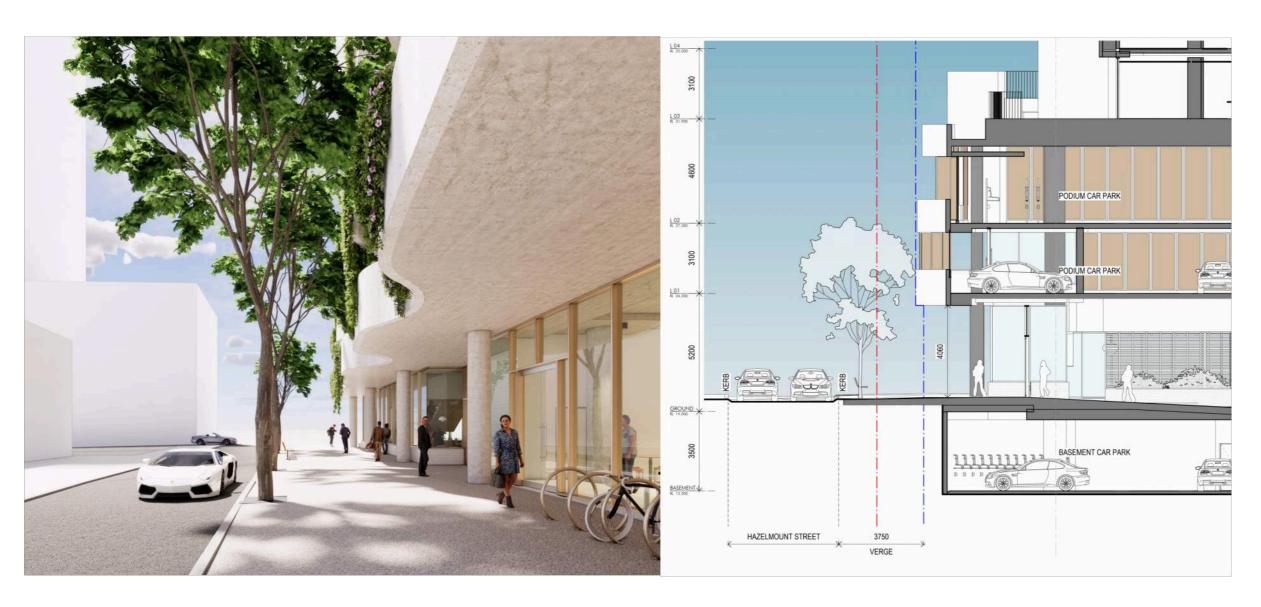

Boundary

Proposed Property

Boundary

Building Elements and Appearance

The proposal provides a distinct lower, middle and upper building form and is well articulated with varied materials, balconies and screening.


The built form of the podium and ground floor plane provides an articulated landscaped screen to the north and west and communal areas to the south on Campbell street to activate and provide street appeal. Retail and active uses flank the Campbell Street and Hazelmount Street frontages and the ground plane. This extends on the south up the full podium with common areas as well as on the west up to level 2. The form and look signify a strong podium and the landscaped tropical green language creates a multifaceted layering of detail and light and shadow. The podium edges account for deep planting from street level.

The building entry points have been well defined for pedestrians through form articulation. Street awnings provide appropriate weather protection and scale. Visual and noise privacy has been considered with loading and servicing occurring under the building.

The landscaped communal podium deck provides a recreational retreat for residents and is positioned to take advantage of the climate and view aspects. Different landscape treatments offer a variety of spaces for residents to enjoy.

The built form of the tower represents and responds to its surrounding context by providing a unique and modern residential tower form with landscape elements and planted edges. Horizontal slab projections articulate the façade and adjustable screening provides a secondary layer of detail and climatic response. The building orientation responds with apartments setback from the neighboring residential tower on the west and with communal balconies to the north and the south. The communal balconies of the typical floor allows cross ventilation opportunities and supports a naturally ventilated and comfortable environment. Screening on the towers west responds climatically to the location and orientation.

The private communal rooftop space is positioned with the swimming pool and surrounds to take maximum advantage of the climate whilst maintaining views and outlook back to the city and across to the suburbs. Rooftop plant is to the west and is screened.

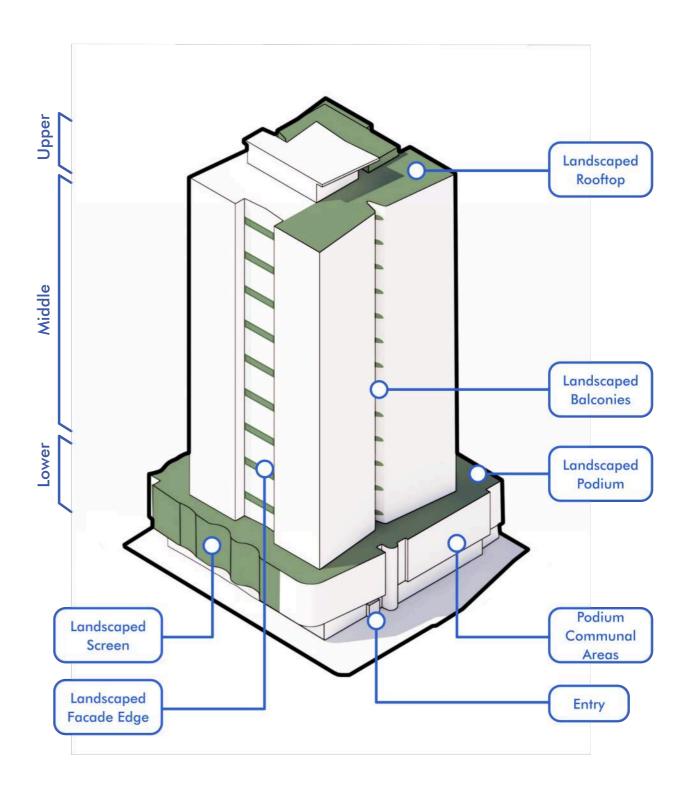



Materiality


The material selection aim to create a distinct identity that responds to the context of Bowen Hills. By using a refined palette of natural tones and textures, the architectural language expresses elegance through simplicity. Materials such as concrete, metal, glass and timber are synthesized with lush greenery to create a timeless design impression.

The use of concrete, glass, and bronze metal on the ground level are intended to create a strong base while maintaining a level of transparency with aesthetic details. Concrete, landscaping, and bronze perforated sheet metal create a singular banded façade language to the podium levels along the three street frontages.

The tower materials incorporates timber and greenery to vertically connect the podium to the rooftop terrace, whereas concrete balconies and edges are used to express the horizontal which also maintain sufficient sun protection to the apartments glazing.

Key:

- Off-form concrete look
- 2. Curtain wall shopfront with bronze powdercoat mullions
- 3. Perforated screen (podium & tower)
- 4. Sun loving planting to northern elevations of podium & tower
- 5. Native timber cabanas
- 6. Native timber deck
- 7. Metal roof sheeting
- 8. Native timber-look batten screen
- 9. Glazing with dark coloured mullions
- 10. Shade tolerant planting to southern elevation of podium & tower
- 11. Concrete pedestrian awning with shade tolerant planting
- 12. Feature brick to entry / perimeter walls

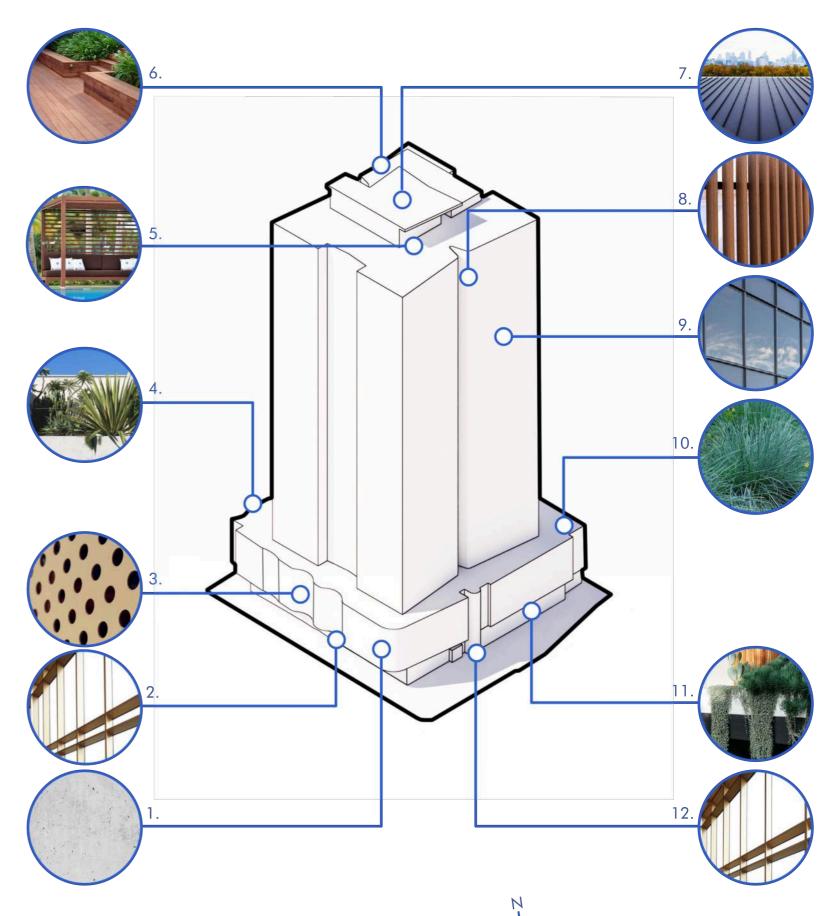

Communal Open Space and Facilities

The ground level lobby space incorporates a private residential lounge and tea facilities as a place for residents to meet socially or for home business. A variety of zones and seating options are proposed. Also, on the ground level a dog wash facility is proposed. Mail rooms and parcel lockers complement the residential amenities at ground level and basement communal laundry allows additional flexibility for the studio apartments.

On the first level a private residents external lounge and meeting rooms are proposed on the western edge. These are connected to the ground level with a feature stair. This provides further breakout space for residents with work from home facilities. Both spaces contribute to the passive surveillance and activation of Hazelmount street from the podium.

The development provides universally accessible communal open space to the Level 3 podium and to the roof. A shared private recreational space has been created on level 1 and 2 of the podium. The landscaped terrace is provided on the south and east with a gym and common lounge area attached for good solar orientation. BBQ facilities and lawn spaces on level 3 provide safe and private breakout opportunities for the residents.

On the roof, a large swimming pool and sundeck provide a private swimming and sun lounge opportunities for residents. Cabanas and a lawn terrace offer views south to city and a place to relax and entertain.

Key:

- 1. Residents Lounge
- 2. Dog Wash
- 3. Parcel Locker & Mail Room
- 4. Private Lounge, co-working space & informal breakout spaces
- 5. Podium Lounge
- 6. Gymnasium
- 7. Rooftop Lounge
- 8. Lawn Terrace
- 9. Pool








Level 2 Podium



Level 3 Podium

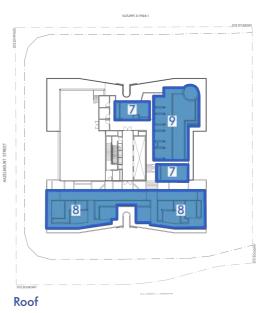




Communal Open Space and Facilities

Balconies

The ability to open a dwelling to the outdoors is an important social and environmental aspect to living in a subtropical climate and forms an integral part of Queensland life. The exterior verandah or balcony serves as a place to look out to views and to capture breezes, but perhaps most essentially as a place to relax and entertain. For small apartments, where there is greater demand on living space, it is often necessary to look for alternative design solutions or provide private external recreation space to facilitate group gatherings. Such spaces have been created on the level four podium and on the roof of the building. All balconies have been designed to maintain the privacy of habitable rooms.

Bicycle Parking

Bicycle parking has been provided throughout the basement, ground and podium levels in dedicated areas. Access to the ground level rooms is directly off Edgar street with a direct pedestrian link through to the ground level lobby. Kerbside visitor bicycle parking is provided on the footpath of Hazelmount street in close proximity to the retail spaces.

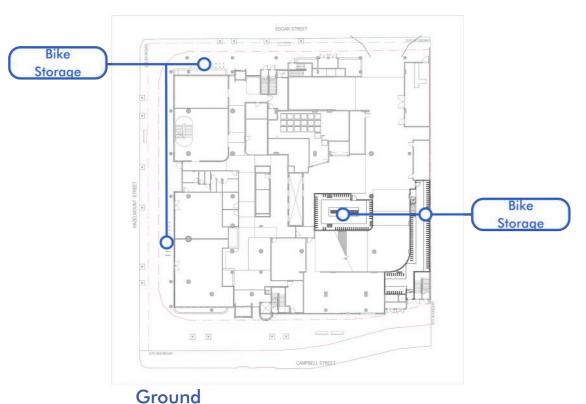





Subtropical Design Response

Location and Orientation

The tower has a dominant north south axis orientation reducing the amount of façade area facing east and west, minimizing the heat gain due to solar exposure. The central east and west apartments are set back from the corner apartments providing extended solar projection.

Massing and Internal Layout

The tower form provides appropriate sunlight penetration and balcony spaces off the typical lift lobby space provide natural light to penetrate the core of the tower and provides opportunities for natural ventilation through the building.

Street Activation

The movement patterns of pedestrians along Hazelmount street have informed the positioning of active spaces to provide increased activity and passive surveillance of the street throughout the day and evenings.

Views


Views to the north east are uninterrupted across Albion and beyond and views to the west are uninterrupted across Newstead toward the Brisbane River. The south offers elevated city views across Richmond and Code apartments and over the Sullivan Nicolaides Pathology Lab.


Building Setbacks

The podium and tower have been designed with the required setbacks from boundaries and neighboring buildings.

Doors and Openings

There are multiple opportunities for residents to access common outdoor space. The landscaped podium deck and rooftop pool terrace provide the largest outdoor space areas, however balconies from the typical lift lobby provide alternate access to outdoor spaces, views, light and breeze.

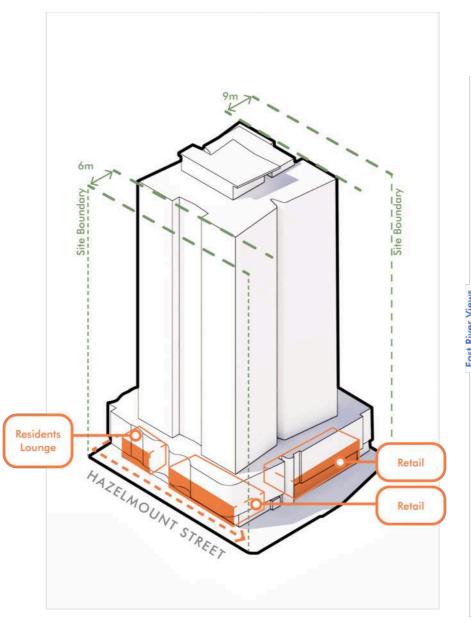

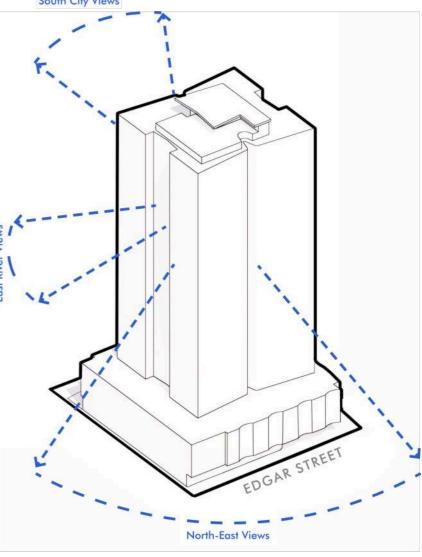



Subtropical Design Response

Natural Ventilation Systems

The tower provides opportunities for mixed mode ventilation systems through the provision of openable facades and ceiling fans.

Shade Structures

The podium façade provides a landscaped tropical green façade to facilitate light and shade, filtered and dappled light.

Building Materials

Building materials have been proposed to provide long-term durability and low maintenance throughout the life of the building. The use of painted and applied surfaces throughout the design is limited and wherever possible natural and environmentally sustainable materials will be used.

Active Transport

The site is in close proximity to the Bowen Hills Train station and within a short distance from major off road bicycle paths. On site secure bicycle storage is included for residents and visitor bicycle parking available to support an active and healthy lifestyle

Environmental Initiatives

The proposal provisions a sharecar vehicle arrangement with access to dedicated on site cars as part of a shared use arrangement. This reduces the number of vehicles on the road network and makes the most efficient use of limited travel for inner city living. It also encourages active transport as a combined transport option.

Environmentally Sustainable Design

A wide range of holistic sustainability measures have been carefully integrated into the preliminary design of the development. These initiatives ensure a healthy, energy and water efficient building with a minimised ecological footprint. Further specific information can be found in the ESD report provided.







Hazelmount Street podium facade





Hazelmount Street podium facade



Hazelmount Street edge






Hazelmount Street edge




Hazelmount Street retail corner

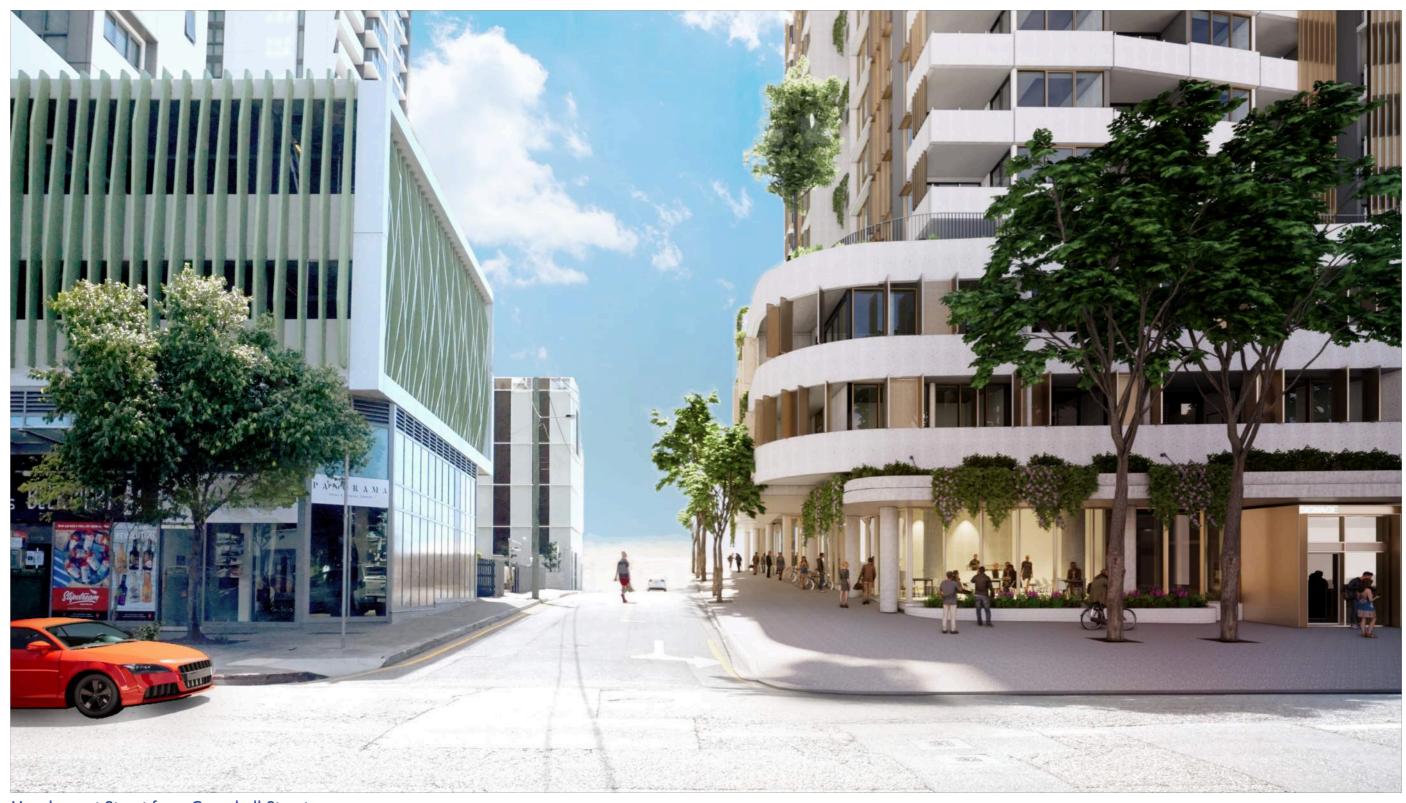

Hazelmount Street from Campbell Street



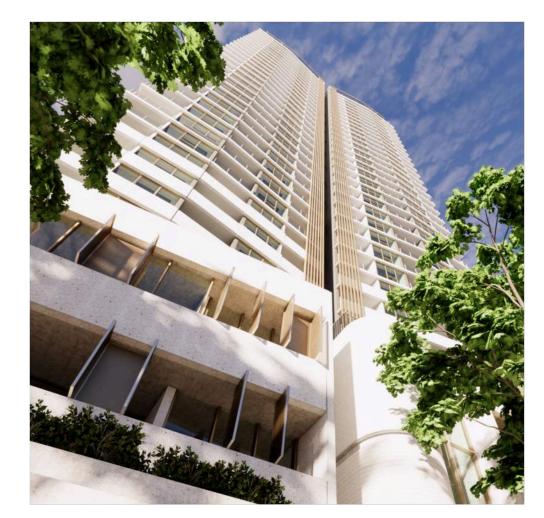


Campbell Street entry



Campbell Street and Hazelmount Street corner




Campbell Street podium facade

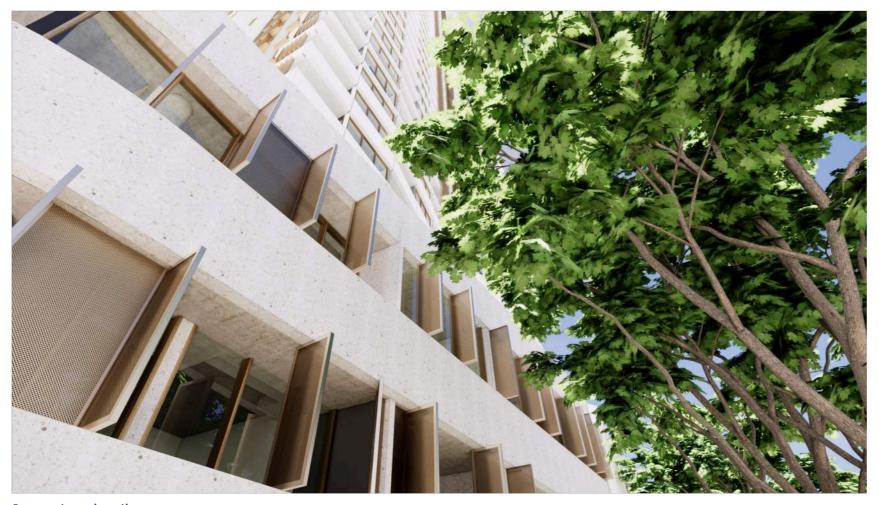



Screening detail

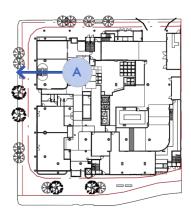



Internal view of residents lounge toward Hazelmount Street

O4 Summary

04 Summary

Area Plan



Are	ea Schedule	e (GFA)	Area	Schedule	(GFA)	
Level	Name	Area	Level	Name	Area	
BASEMENT 1	GFA	42.69 m²	L 16	GFA	968.78 m²	
GROUND	GFA	298.58 m²	L 17	GFA	968.78 m²	
GROUND	GFA	210.08 m²	L 18	GFA	968.78 m ²	
GROUND	GFA	22.31 m²	L 19	GFA	968.78 m²	
GROUND	GFA	45.58 m²	L 20	GFA	968.78 m²	
GROUND	GFA	161.84 m²	L 21	GFA	968.78 m²	
L 01	GFA	453.68 m²	L 22	GFA	968.78 m²	
L 01	GFA	30.71 m²	L 23	GFA	968.78 m²	
L 02	GFA	331.38 m²	L 24	GFA	968.78 m²	GFA GROSS FLOOR AREA DEFINITION
L 03	GFA	999.73 m²	L 25	GFA	968.78 m²	Gross floor area, for a building, means the total floor area of all storeys of the
L 04	GFA	968.78 m²	L 26	GFA	968.78 m²	building, measured from the outside of the external walls and the centre of
L 05	GFA	968.78 m²	L 27	GFA	968.78 m²	common walls of the building, other than areas used for-
L 06	GFA	968.78 m²	L 28	GFA	968,78 m²	a. building services, plant or equipment; or
L 07	GFA	968.78 m²	L 29	GFA	968.78 m²	b. access between levels; or
L 08	GFA	968.78 m²	L 30	GFA	968.78 m²	c. a ground floor public lobby; or d. a mall: or
L 09	GFA	968.78 m²	L 31	GFA	968.78 m²	e. parking, loading or manoeuvring vehicles; or
L 10	GFA	968.78 m²	L 32	GFA	968.78 m²	f. unenclosed private balconies, whether roofed or not
L 11	GFA	968.78 m²	L 33	GFA	968.78 m²	NOTE
L 12	GFA	968.78 m²	LOWER ROOF DECK	GFA	45.71 m²	NOIE
L 13	GFA	968.78 m²	ROOF DECK	GFA	22.50 m ²	Areas are approximate only and are TBC by a surveyor
L 14	GFA	968.78 m²	ROOF DECK	GFA	33.35 m²	
L 15	GFA	968.78 m²	Grand total		31761.55 m²	



04 Summary



	Area Schedule (Communal S	Space)	
Level	Name	Area	
GROUND	COMMUNAL SPACE	678 m²	
L 01	COMMUNAL SPACE	30 m²	
L 01	COMMUNAL SPACE	62 m²	
L 01	COMMUNAL SPACE	179 m²	
L 01	COMMUNAL SPACE	180 m²	
L 02	COMMUNAL SPACE	132 m²	
L 02	COMMUNAL SPACE	180 m²	
ROOF DECK	COMMUNAL SPACE	22 m²	

Level	Name	Area
L 01	COMMUNAL OUTDOOR SPACE	22 m²
L 01	COMMUNAL OUTDOOR SPACE	22 m²
L 01	COMMUNAL OUTDOOR SPACE	36 m²
L 01	COMMUNAL OUTDOOR SPACE	105 m²
L 02	COMMUNAL OUTDOOR SPACE	3 m²
L 02	COMMUNAL OUTDOOR SPACE	18 m²
L 02	COMMUNAL OUTDOOR SPACE	35 m²
L 03	COMMUNAL OUTDOOR SPACE	927 m²
LOWER ROOF DECK	COMMUNAL OUTDOOR SPACE	397 m²
ROOF DECK	COMMUNAL OUTDOOR SPACE	308 m²
Grand total IOTE: REAS ARE AN A	APPROXIMATE ONLY	1873 m²



Rev F

04 Development Summary

Development Summary

19-25 Campbell Street				updated:	16.08.202
Original Site Area (m2):		3,276			
New Site Area (m2):		2,792	15.4		
Plot Ratio Allowed:	1:8	26,208	31,686	provided	5,478
Site Cover (above podium):		60%	1,244	provided	38%
Parking:	0.75 + 0.15	393	185	provided	- 208
3 Bedroom Apartments:	10% of GFA	28	31	provided	11.0%

Unit Types

	Unit Type	Beds	Internal Area (approx)	Balcony Area (approx)	Internal+ Balcony (approx)	Total Units	Total Beds	Total Cars Required	Visitor Cars Required
Studio	S-A	1	31.00	7.00	38.00	62	62	46.5	9.3
18	1B-A	1	53.00	10.00	63.00	62	62	46.5	9.3
18	1B-B	1	50.00	10.00	60.00	122	122	91.5	18.3
1B	1B-C	1	55.70	11.50	67.20	31	31	23.25	4.65
2B	2B-A	2	92.00	10.00	102.00	31	62	23.25	4.65
2B	2B-B	2	74.00	23.00	97.00	31	62	23.25	4.65
2B	2B-C	2	80.00	10.00	90.00	62	124	46.5	9.3
3B	3B-A	3	112.00	19.00	131.00	31	93	23.25	4.65
Retail	Retail		370.00						4
					Units:	432	618	324	69.0
							requir	ed cars:	393

Studio	1 Bed Units	2 Bed Units	3 Bed Units
62	0	0	0
0	62	0	0
0	122	0	0
0	31	0	0
0	0	31	0
0	0	31	0
0	0	62	0
0	0	0	31
62	215	124	31
14.4%	49.8%	28.7%	7.2%

..., ..., ...


Unit Matrix

							- 0									
	Level	north wing	north wing	north wing	north wing	west wing	west wing	east wing	east wing	south wing	Unit Count					
Terrace		plant	Common	NAME OF TAXABLE PARTY.	E CONTRACTOR OF THE PARTY OF TH		2000000					50000000				7
Level		2B-A	2B-B	18-A	3B-A	1B-B	1B-B	1B-B	1B-B	2B-C	S-A	1B-C	1B-A	S-A	2B-C	14
Level	_	2B-A	2B-B	1B-A	3B-A	1B-B	1B-B	1B-B	1B-B	2B-C	S-A	1B-C	1B-A	S-A	2B-C	14
Level	31	2B-A	2B-B	1B-A	3B-A	1B-B	1B-B	1B-B	1B-B	2B-C	S-A	1B-C	1B-A	S-A	2B-C	14
		2B-A	2B-B	1B-A	3B-A	1B-B	1B-B	1B-B	1B-B	2B-C	S-A	1B-C	1B-A	S-A	2B-C	14
	29	2B-A	2B-B	1B-A	3B-A	1B-B	1B-B	1B-B	1B-B	2B-C	S-A	1B-C	1B-A	S-A	2B-C	14 14
Level	28	2B-A	2B-B	1B-A	3B-A	1B-B	1B-B	1B-B	1B-B	2B-C	S-A	1B-C	1B-A	S-A	2B-C	14
Level	27	2B-A	2B-B	1B-A	3B-A	1B-B	1B-B	1B-B	1B-B	2B-C	S-A	1B-C	1B-A	S-A	2B-C	14
Level	26	2B-A	2B-B	1B-A	3B-A	1B-B	1B-B	1B-B	1B-B	2B-C	S-A	1B-C	1B-A	S-A	2B-C	14 14
Level	25	2B-A	2B-B	1B-A	3B-A	1B-B	1B-B	1B-B	1B-B	2B-C	S-A	1B-C	1B-A	S-A	2B-C	14
Level		2B-A	2B-B	1B-A	3B-A	1B-B	18-B	1B-B	1B-B	2B-C	S-A	1B-C	1B-A	S-A	2B-C	14
Level		2B-A	2B-B	1B-A	3B-A	1B-B	1B-B	18-B	1B-B	2B-C	S-A	1B-C	1B-A	S-A	2B-C	14
		2B-A	2B-B	1B-A	3B-A	1B-B	1B-B	1B-B	1B-B	2B-C	S-A	1B-C	18-A	S-A	2B-C	14
Level	21	2B-A	2B-B	1B-A	3B-A	1B-B	1B-B	1B-B	1B-B	2B-C	S-A	1B-C	1B-A	S-A	2B-C	14 14
Level	20	2B-A	2B-B	1B-A	3B-A	1B-B	1B-B	1B-B	1B-B	2B-C	S-A	1B-C	1B-A	S-A	2B-C	14
Level		2B-A	2B-B	1B-A	3B-A	1B-B	1B-B	1B-B	1B-B	2B-C	S-A	1B-C	1B-A	S-A	2B-C	14
Level	22.2	2B-A	2B-B	1B-A	3B-A	1B-B	1B-B	1B-B	1B-B	2B-C	S-A	1B-C	1B-A	S-A	2B-C	14 14
Level	17	2B-A	2B-B	1B-A	3B-A	1B-B	1B-B	1B-B	1B-B	2B-C	S-A	1B-C	1B-A	S-A	2B-C	14
Level	16	2B-A	2B-B	1B-A	3B-A	1B-B	1B-B	1B-B	1B-B	2B-C	S-A	1B-C	1B-A	S-A	2B-C	14
Level	15	2B-A	2B-B	1B-A	3B-A	1B-B	1B-B	1B-B	1B-B	2B-C	S-A	1B-C	1B-A	S-A	2B-C	14
Level	14	2B-A	2B-B	1B-A	3B-A	1B-B	1B-B	1B-B	1B-B	2B-C	S-A	1B-C	1B-A	S-A	2B-C	14
Level	13	2B-A	2B-B	1B-A	3B-A	1B-B	1B-B	1B-B	1B-B	2B-C	S-A	1B-C	1B-A	S-A	2B-C	14 14
Level	12	2B-A	2B-B	1B-A	3B-A	1B-B	1B-B	1B-B	1B-B	2B-C	S-A	1B-C	18-A	S-A	2B-C	14
Level	11	2B-A	2B-B	1B-A	3B-A	1B-B	1B-B	1B-B	1B-B	2B-C	S-A	1B-C	1B-A	S-A	2B-C	14
Level	10	2B-A	2B-B	1B-A	3B-A	1B-B	1B-B	1B-B	1B-B	2B-C	S-A	1B-C	1B-A	S-A	2B-C	14 14
Level	9	2B-A	2B-B	1B-A	3B-A	1B-B	1B-B	1B-B	1B-B	2B-C	S-A	18-C	1B-A	S-A	2B-C	14
Level	8	2B-A	2B-B	1B-A	3B-A	1B-B	1B-B	1B-B	1B-B	2B-C	S-A	1B-C	1B-A	S-A	2B-C	14 14
Level	7	2B-A	2B-B	1B-A	3B-A	1B-B	1B-B	1B-B	1B-B	2B-C	S-A	1B-C	1B-A	S-A	2B-C	14
Level	6	2B-A	2B-B	1B-A	3B-A	1B-B	1B-B	1B-B	1B-B	2B-C	S-A	1B-C	1B-A	S-A	2B-C	14
Level	5	2B-A	2B-B	1B-A	3B-A	18-B	1B-B	1B-B	1B-B	2B-C	S-A	1B-C	18-A	S-A	2B-C	14
Level	4	2B-A	2B-B	1B-A	3B-A	1B-B	1B-B	1B-B	1B-B	2B-C	S-A	1B-C	1B-A	S-A	2B-C	14 14
Level	3	2B-A	2B-B	1B-A	3B-A	1B-B	18-B			2B-C	S-A	1B-C	1B-A	S-A	2B-C	12
Level	2	Parking								8			8			0
Level	1	Parking														0
Level	Ground	Entry														
Level	B1	Parking														
																units

Parking | September | Septemb

Appendix

A: Architectural Drawings

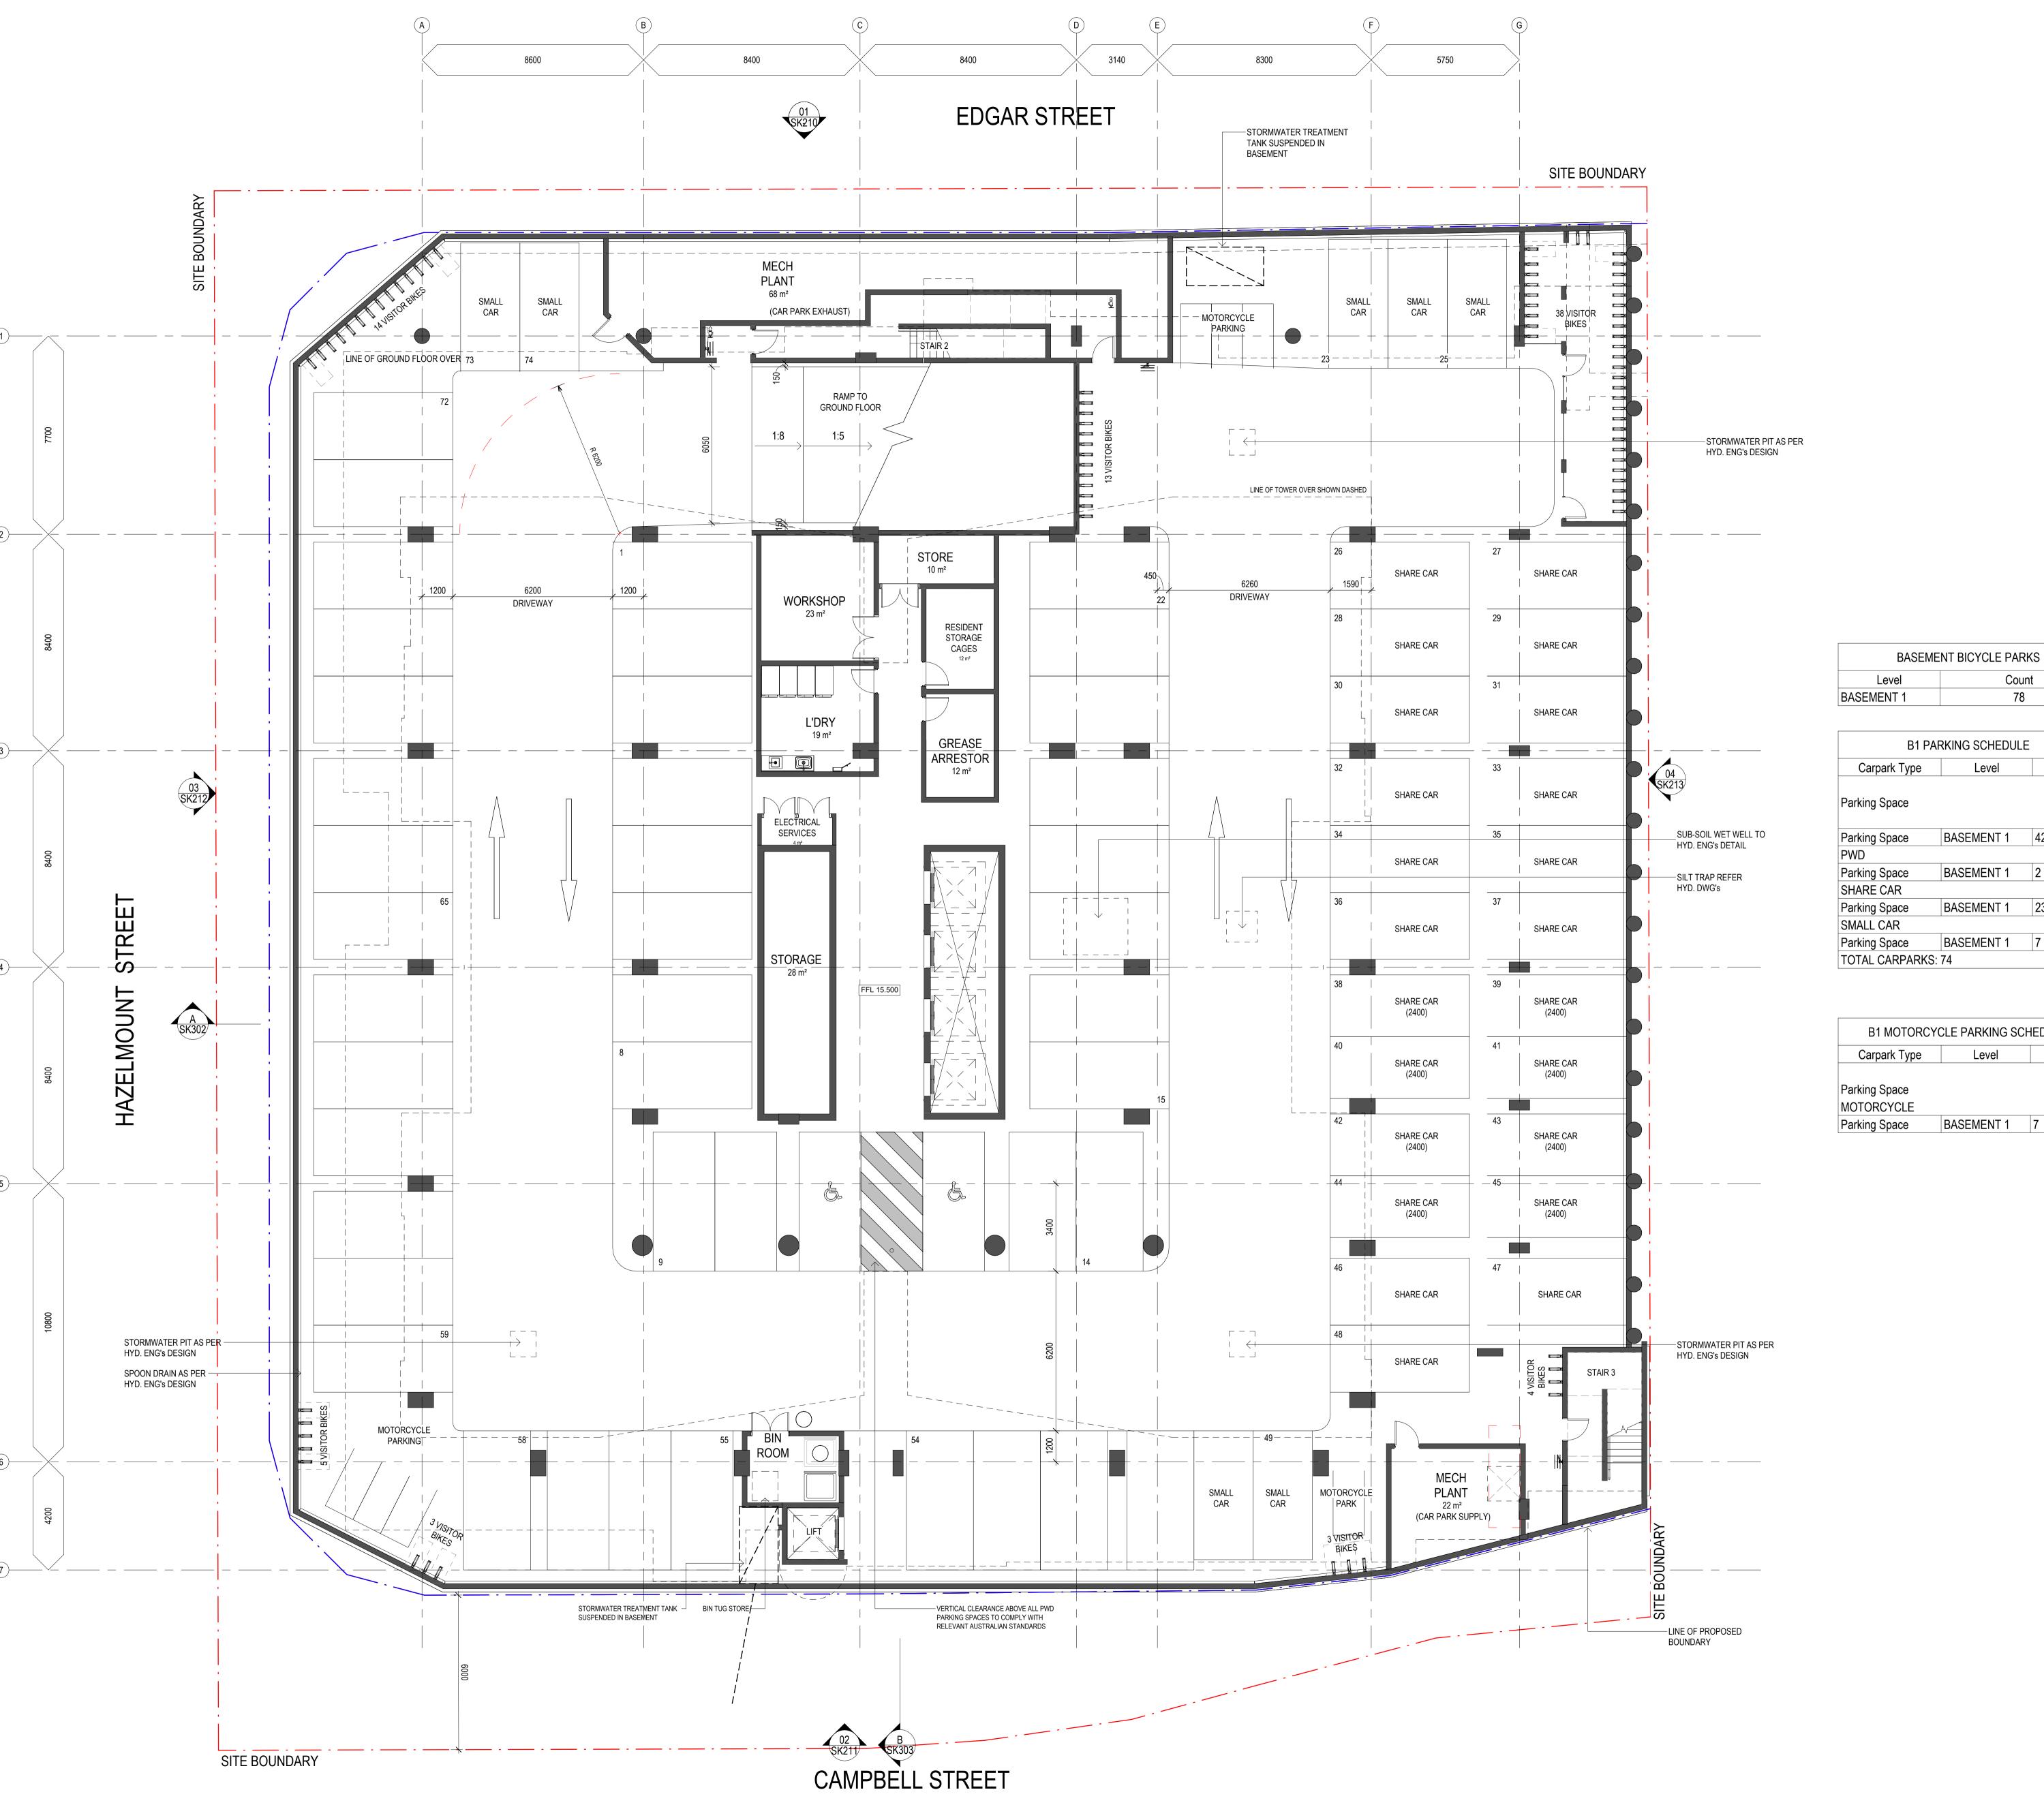

Issue	Description	Date
6	DA ISSUE	16.08.2024
5	ISSUE FOR PRICING	31.01.2022
4	ISSUE FOR INFORMATION	26.11.2021
3	FOR INFORMATION	18.11.2021
2	Preliminary Issue	13.10.2021
1	Preliminary issue for information	08.09.2021

work or off-site fabrication. Figured dimensions shall take precedence over scaled dimensions. This drawing is copyright and cannot be reproduced in whole or in part or by any medium without the written permission of Nettleton Tribe Partnership Pty Ltd.

B1 PAI	RKING SCHEDULE	
Carpark Type	Level	Count
Parking Space		
Parking Space	BASEMENT 1	42
PWD		
Parking Space	BASEMENT 1	2
SHARE CAR		
Parking Space	BASEMENT 1	23
SMALL CAR		
Parking Space	BASEMENT 1	7
TOTAL CARPARKS:	74	

B1 MOTORCY	CLE PARKING SCH	HEDULE
Carpark Type	Level	Count
Parking Space		
MOTORCYCLE		
Parking Space	BASEMENT 1	7

Project Name

BOWEN HILLS RESIDENTIAL

Project Address

19- 25 Campbell Street, Bowen Hills

Drawing Title
B01 GA PLAN

Drawing Number: 11703_DD1102 6

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Key Plan

0 2000 5000

Builder and/or subcontractors shall verify all project dimensions before commencing on-site

 Issue
 Description
 Date

 6
 DA ISSUE
 16.08.2024

 5
 ISSUE FOR PRICING
 31.01.2022

 4
 ISSUE FOR INFORMATION
 26.11.2021

 3
 FOR INFORMATION
 18.11.2021

 2
 Preliminary Issue
 13.10.2021

 1
 Preliminary issue for information
 08.09.2021

dowse NEW URBAN PROJECTS VILLAGES

Project Name

BOWEN HILLS

RESIDENTIAL

Project Address
19- 25 Campbell
Street, Bowen Hills


L00 GA PLAN

Author: Checker: Sheet Size: Scale: 1:100

Drawing Number: 11703_DD1103

6

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Project Name

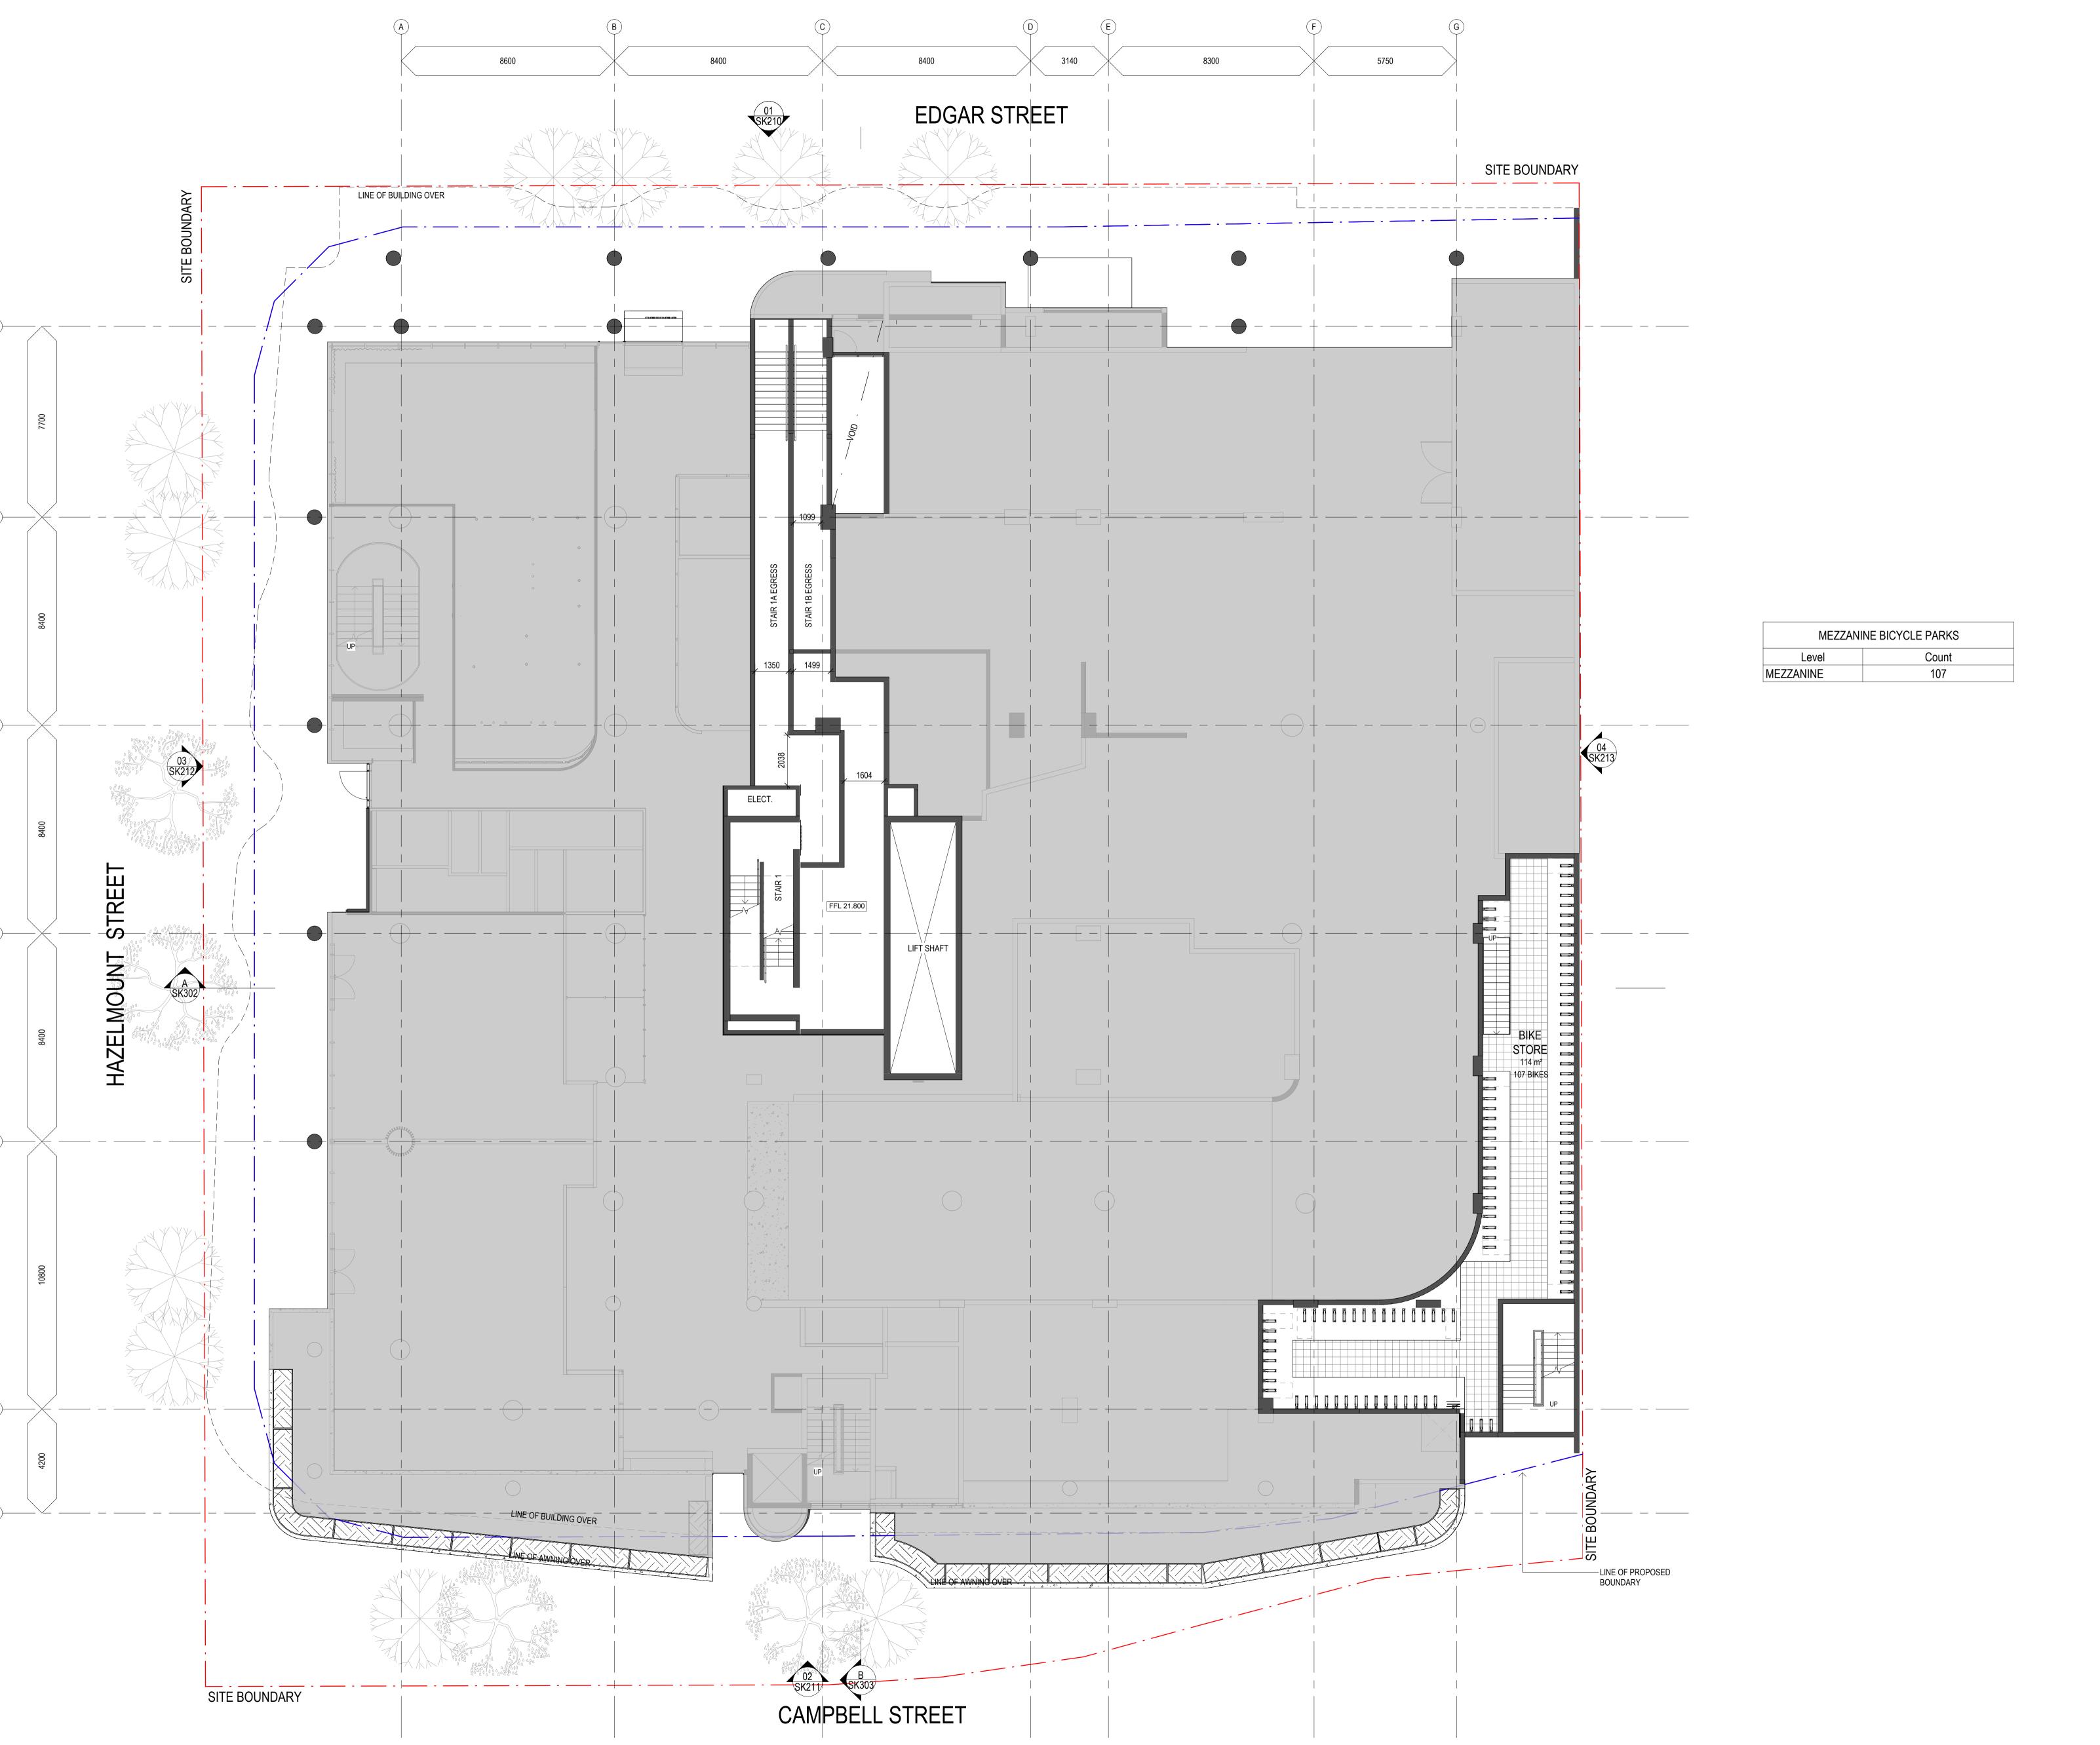BOWEN HILLS

RESIDENTIAL


Project Address
19- 25 Campbell
Street, Bowen Hills

Drawing Title
MEZZANINE STORE

Author: Checker: Sheet Size: Scale: 1:100

Drawing Number: 11703_DD1103.1 4

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dowse NEW URBAN Projects VILLAGES

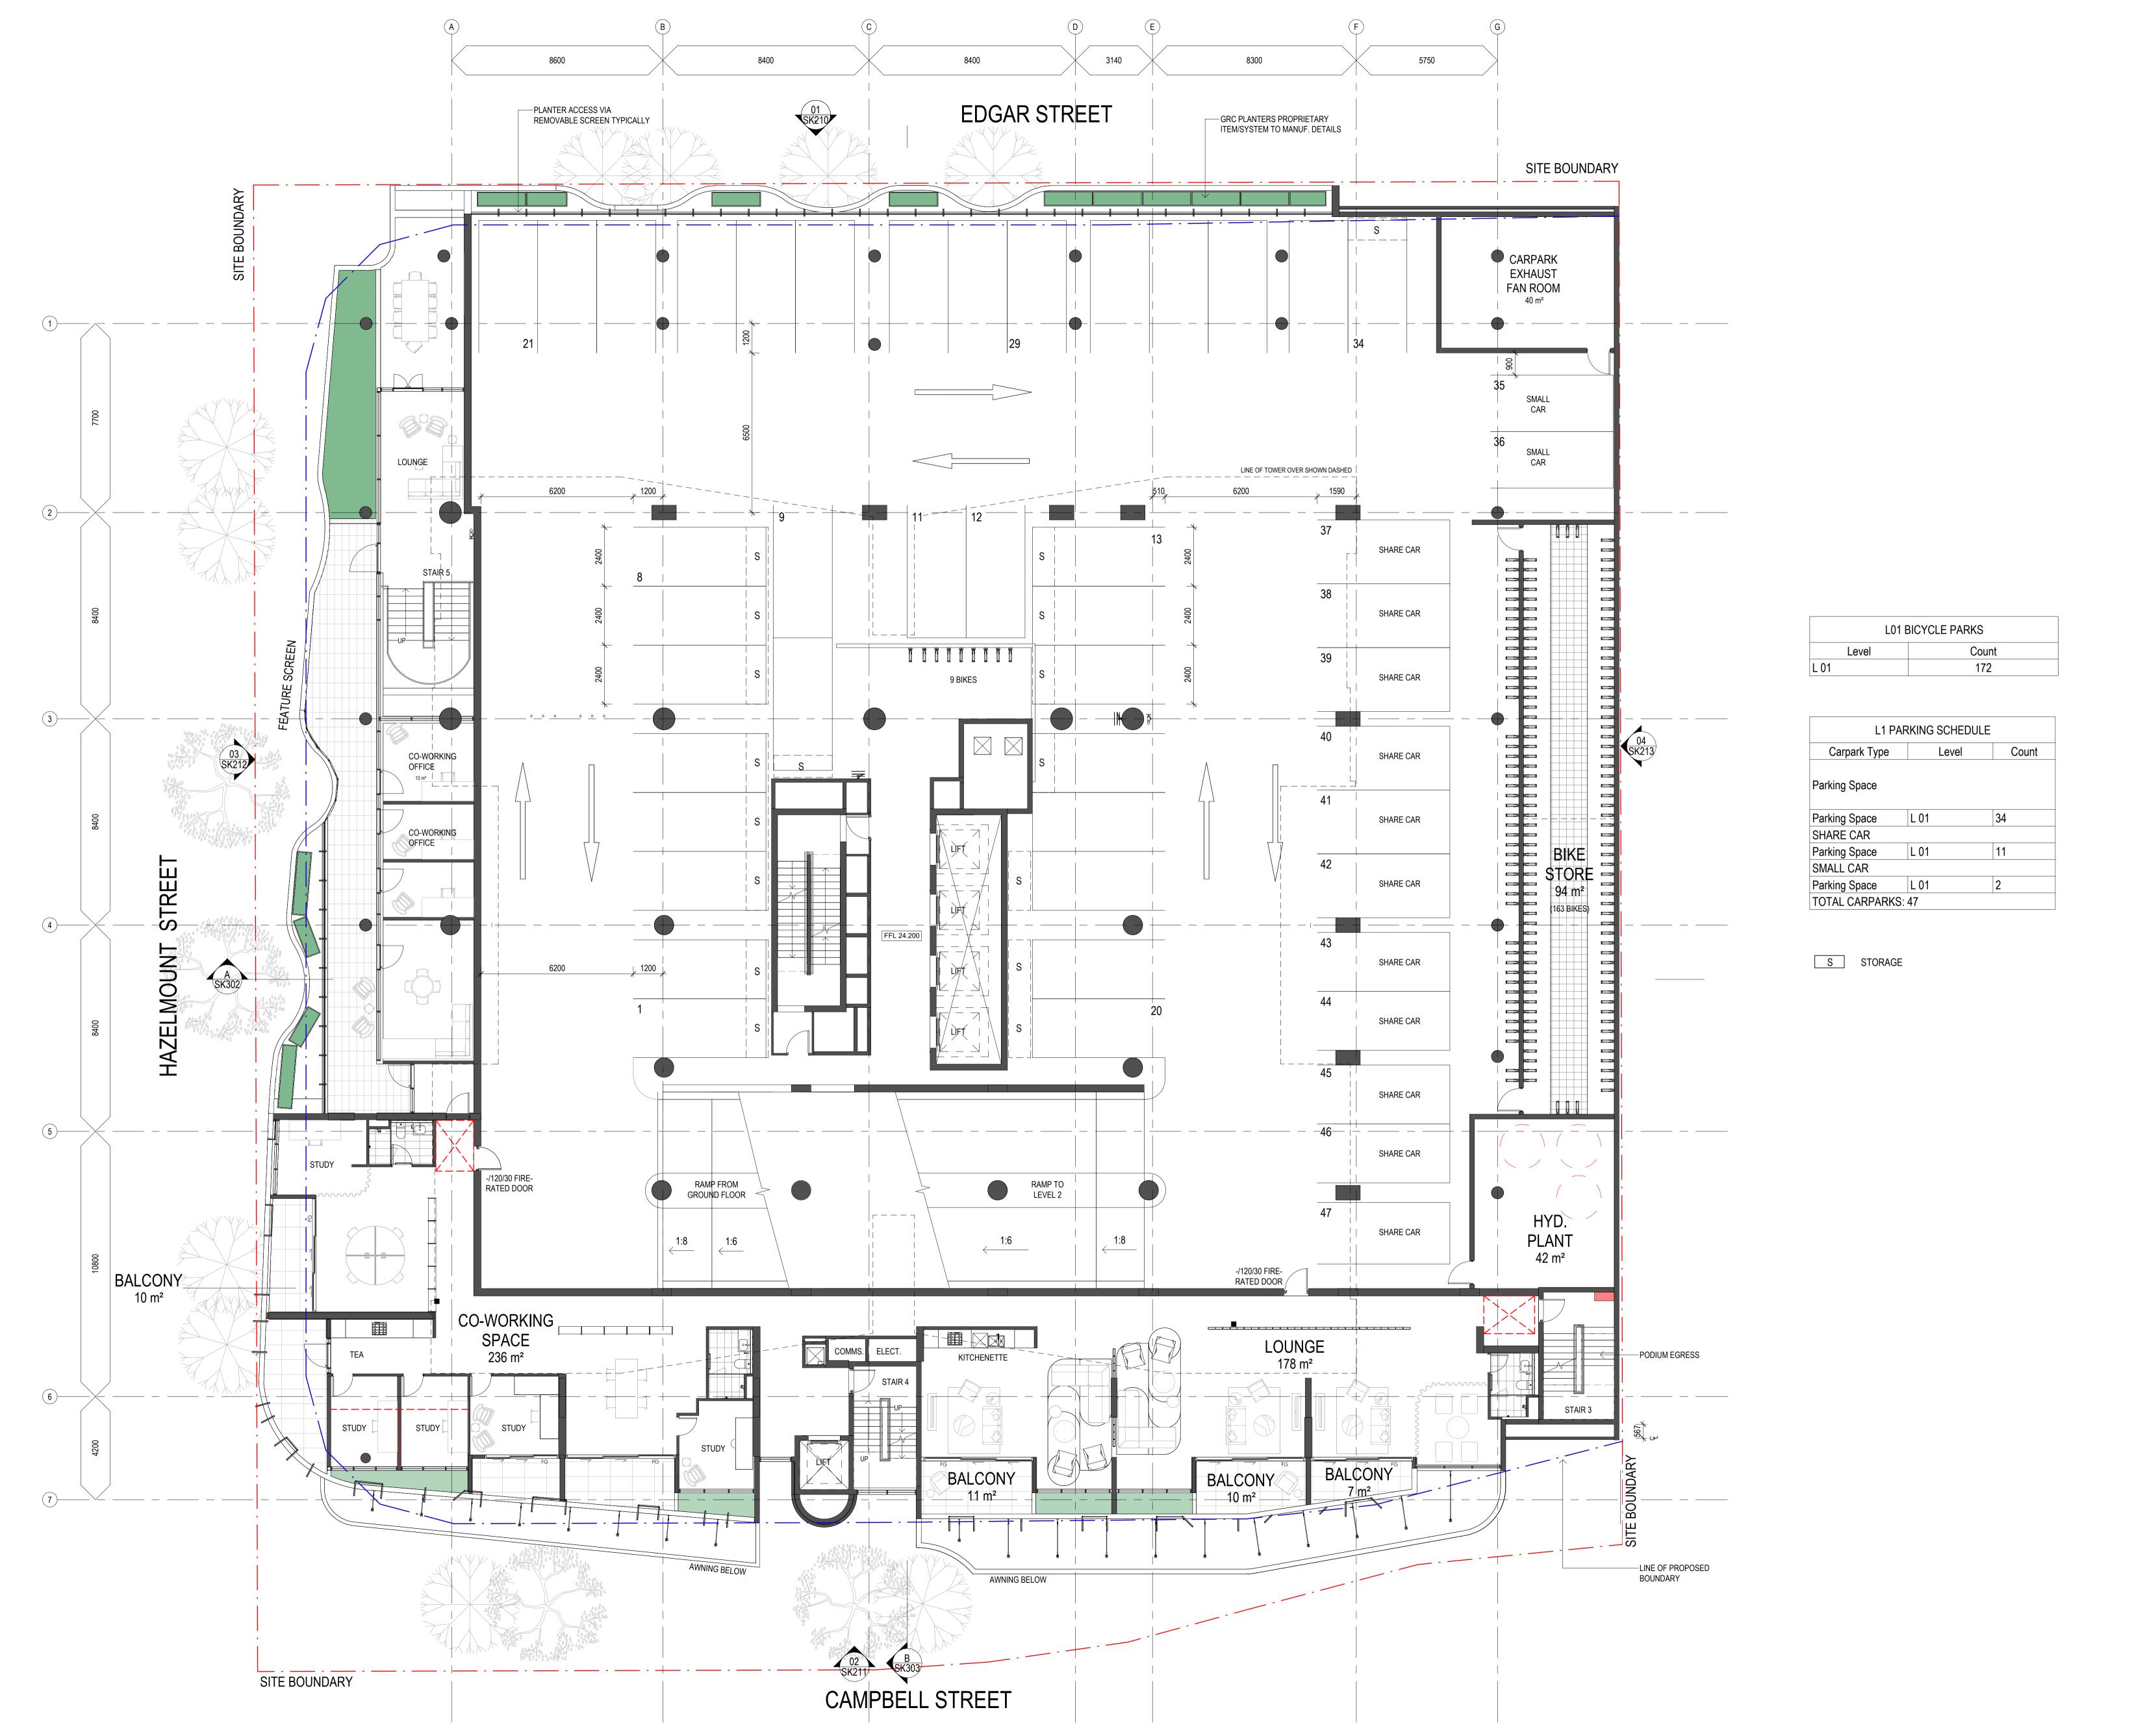Project Name


BOWEN HILLS

RESIDENTIAL

Project Address
19- 25 Campbell
Street, Bowen Hills

Drawing Title
L01 GA PLAN

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Project Name
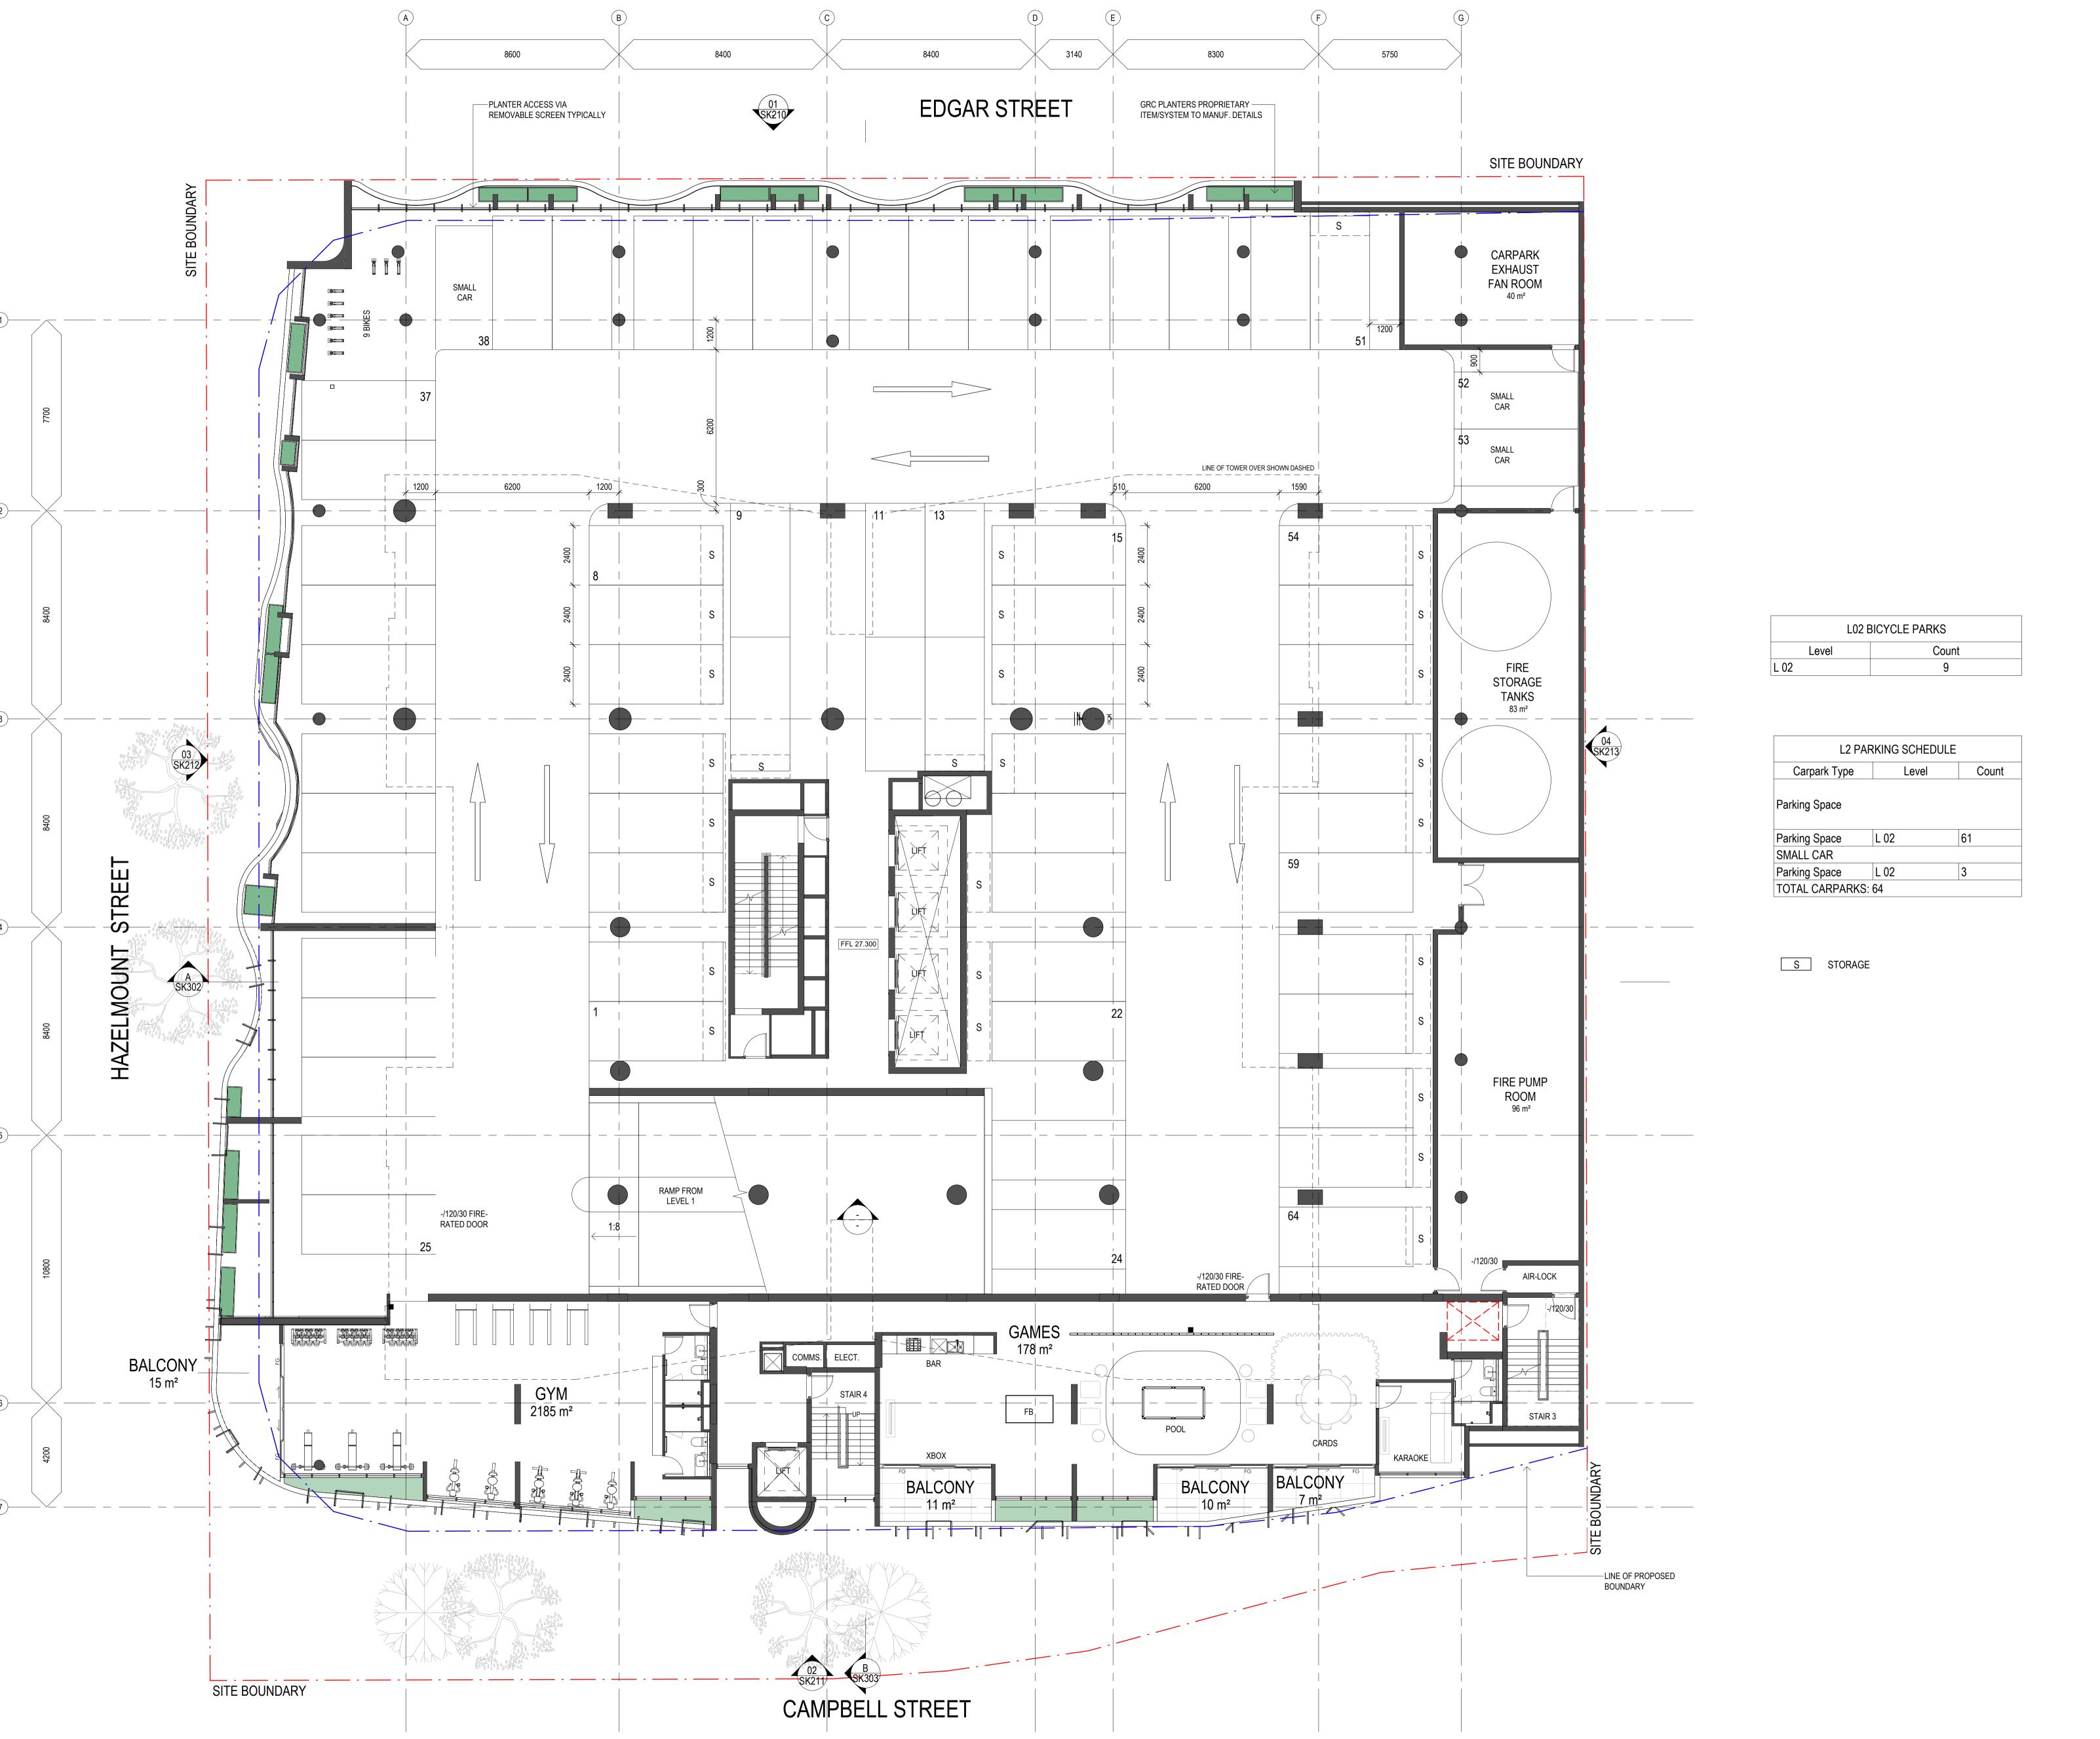
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Project Address
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Street, Bowen Hills

Drawing Title
L02 GA PLAN

Author: Checker: Sheet Size: Scale: 1:100

Drawing Number: 11703_DD1105

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Key Plan

0 2000 5000

 Issue
 Description
 Date

 6
 DA ISSUE
 16.08.2024

 5
 ISSUE FOR PRICING
 31.01.2022

 4
 ISSUE FOR INFORMATION
 26.11.2021

 3
 FOR INFORMATION
 18.11.2021

 2
 Preliminary Issue
 13.10.2021

 1
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Street, Bowen Hills

L03 GA PLAN

Author: Checker: Sheet Size: 1:100

Drawing Number: 11703_DD1106

Scale: 1:100

Issue: 6

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 Issue
 Description
 Date

 6
 DA ISSUE
 16.08.2024

 5
 ISSUE FOR PRICING
 31.01.2022

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 ISSUE FOR INFORMATION
 26.11.2021

 3
 FOR INFORMATION
 18.11.2021

 2
 Preliminary Issue
 13.10.2021

 1
 Preliminary issue for information
 08.09.2021

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Project Name

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RESIDENTIAL

Project Address
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Street, Bowen Hills

TYPICAL (EVEN) LEVEL 4 - 33 GAPLAN

Author: Checker: Sheet Size: Scale: JF MH B1 1:100

Drawing Number: Issue: 6

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 Issue
 Description
 Date

 6
 DA ISSUE
 16.08.2024

 5
 ISSUE FOR PRICING
 31.01.2022

 4
 ISSUE FOR INFORMATION
 26.11.2021

 3
 FOR INFORMATION
 18.11.2021

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 Preliminary Issue
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 08.09.2021

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Project Name
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Street, Bowen Hills


Drawing Title
TYPICAL (ODD) LEVEL 4-33 GA PLAN

Author: Checker: Sheet Size: Scale:

JF MH B1 1:100

Drawing Number: 11703_DD1108 6

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 Issue
 Description
 Date

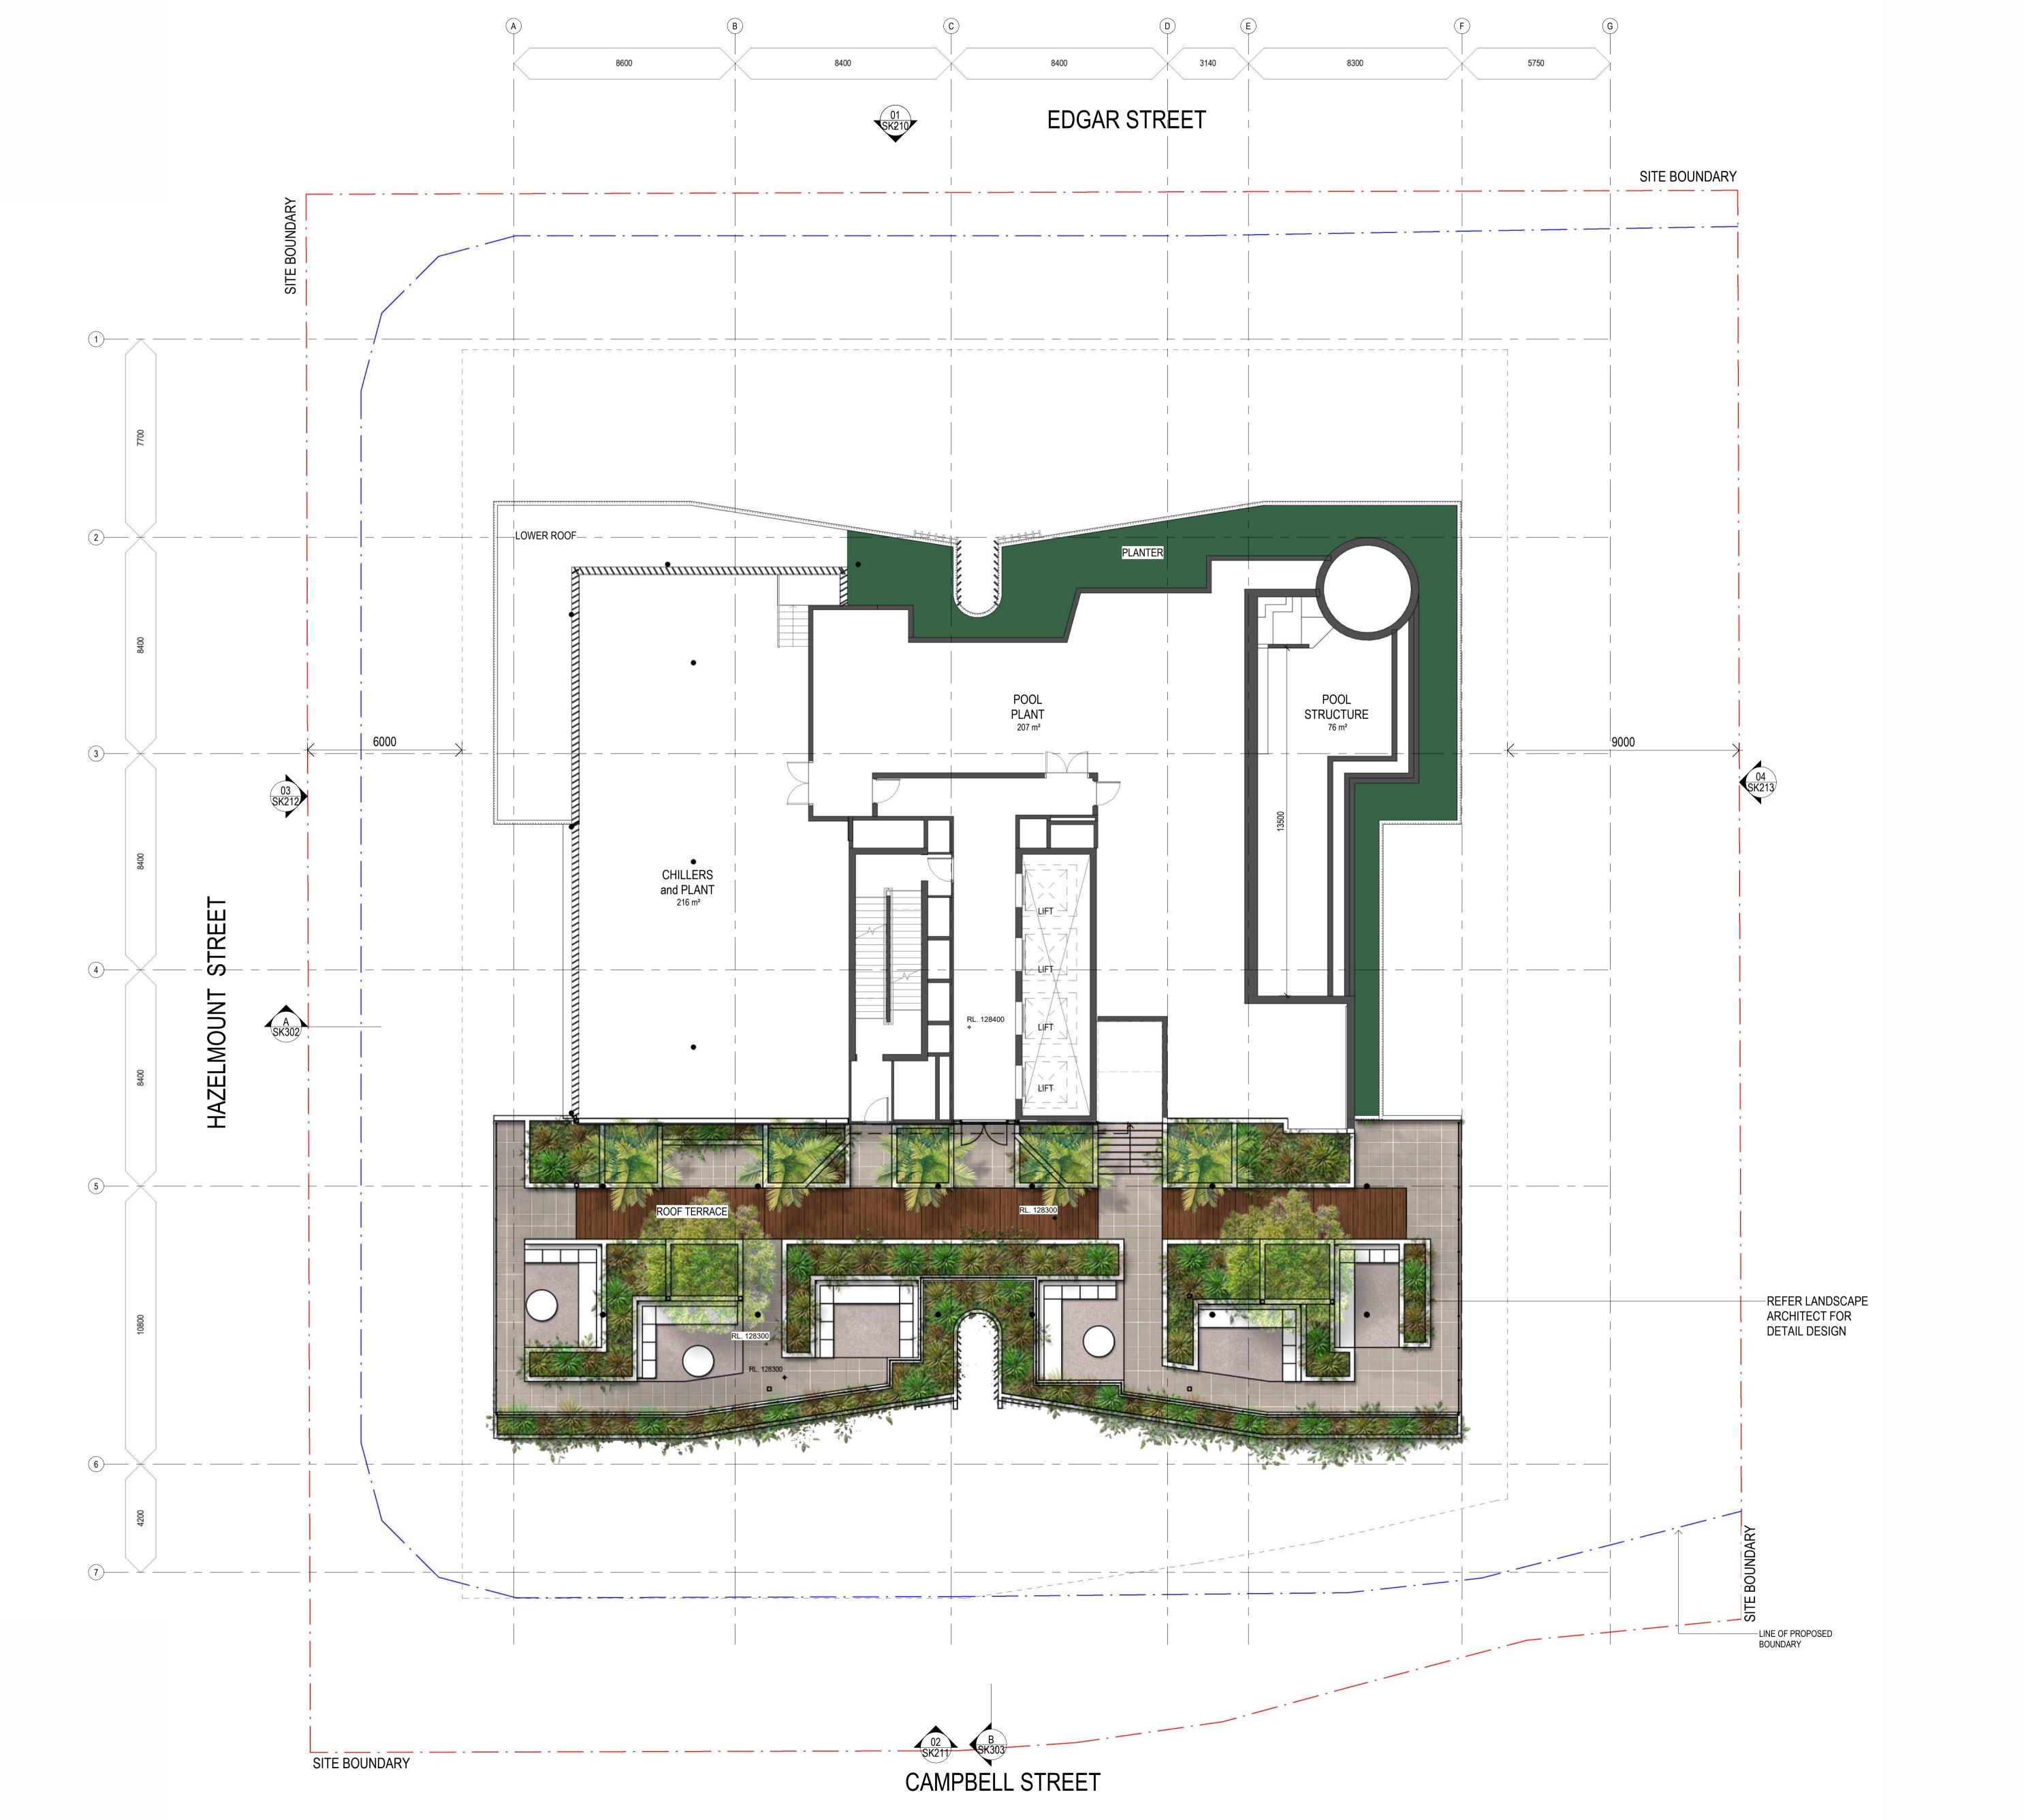 6
 DA ISSUE
 16.08.2024

 5
 ISSUE FOR PRICING
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 4
 ISSUE FOR INFORMATION
 26.11.2021

 3
 FOR INFORMATION
 18.11.2021

 2
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RESIDENTIAL

Project Address
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Street, Bowen Hills

LEVEL 34 LOWER ROOF DECK PLAN

Author: Checker: Sheet Size: 1:100

Drawing Number: 11703_DD1109

6

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 Issue
 Description
 Date

 6
 DA ISSUE
 16.08.2024

 5
 ISSUE FOR PRICING
 31.01.2022

 4
 ISSUE FOR INFORMATION
 26.11.2021

 3
 FOR INFORMATION
 18.11.2021

 2
 Preliminary Issue
 13.10.2021

 1
 Preliminary issue for information
 08.09.2021

dowse NEW URBAN projects VILLAGES

Project Name

BOWEN HILLS

RESIDENTIAL

Project Address
19- 25 Campbell
Street, Bowen Hills


Drawing Title
LEVEL 35 UPPER ROOF DECK PLAN

Author: Checker: Sheet Size: Scale: 1:100

Drawing Number: 11703_DD1110

6

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Project Name
BOWEN HILLS
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Project Address
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Street, Bowen Hills

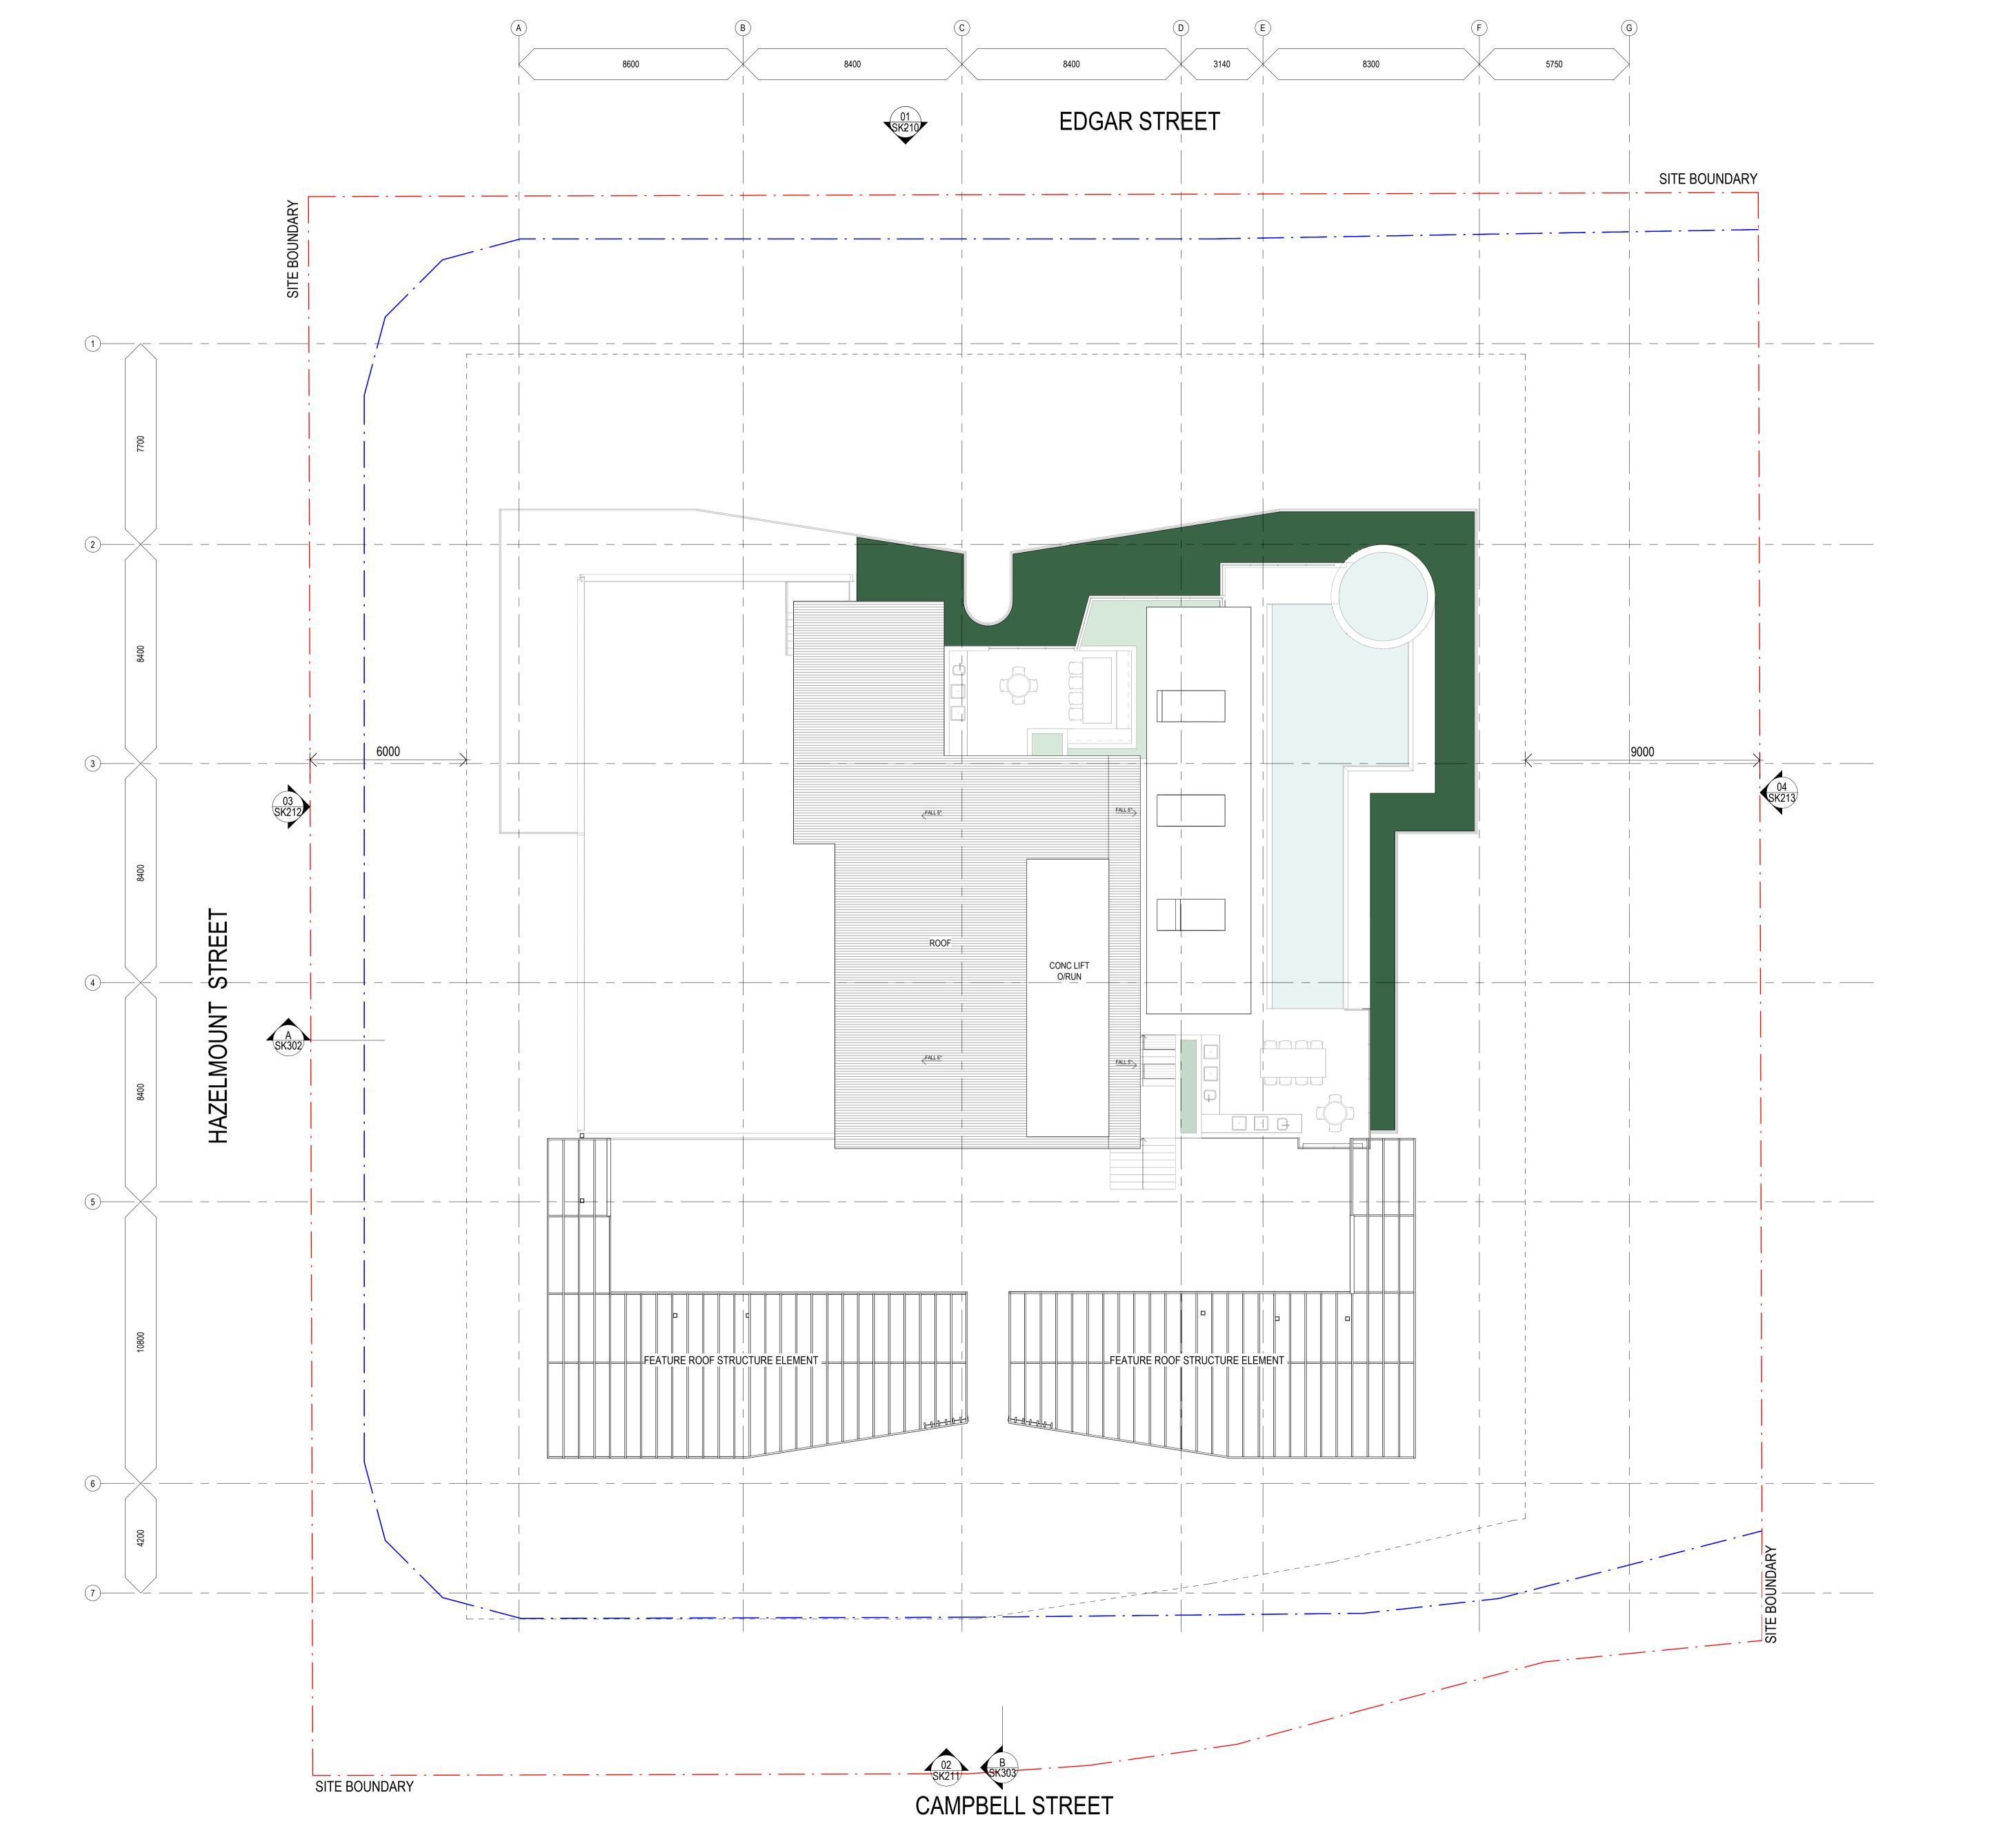ROOF PLAN

Author: Checker: Sheet Size: Scale: 1:100

Drawing Number: 11703_DD1111 4

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Project Name

BOWEN HILLS

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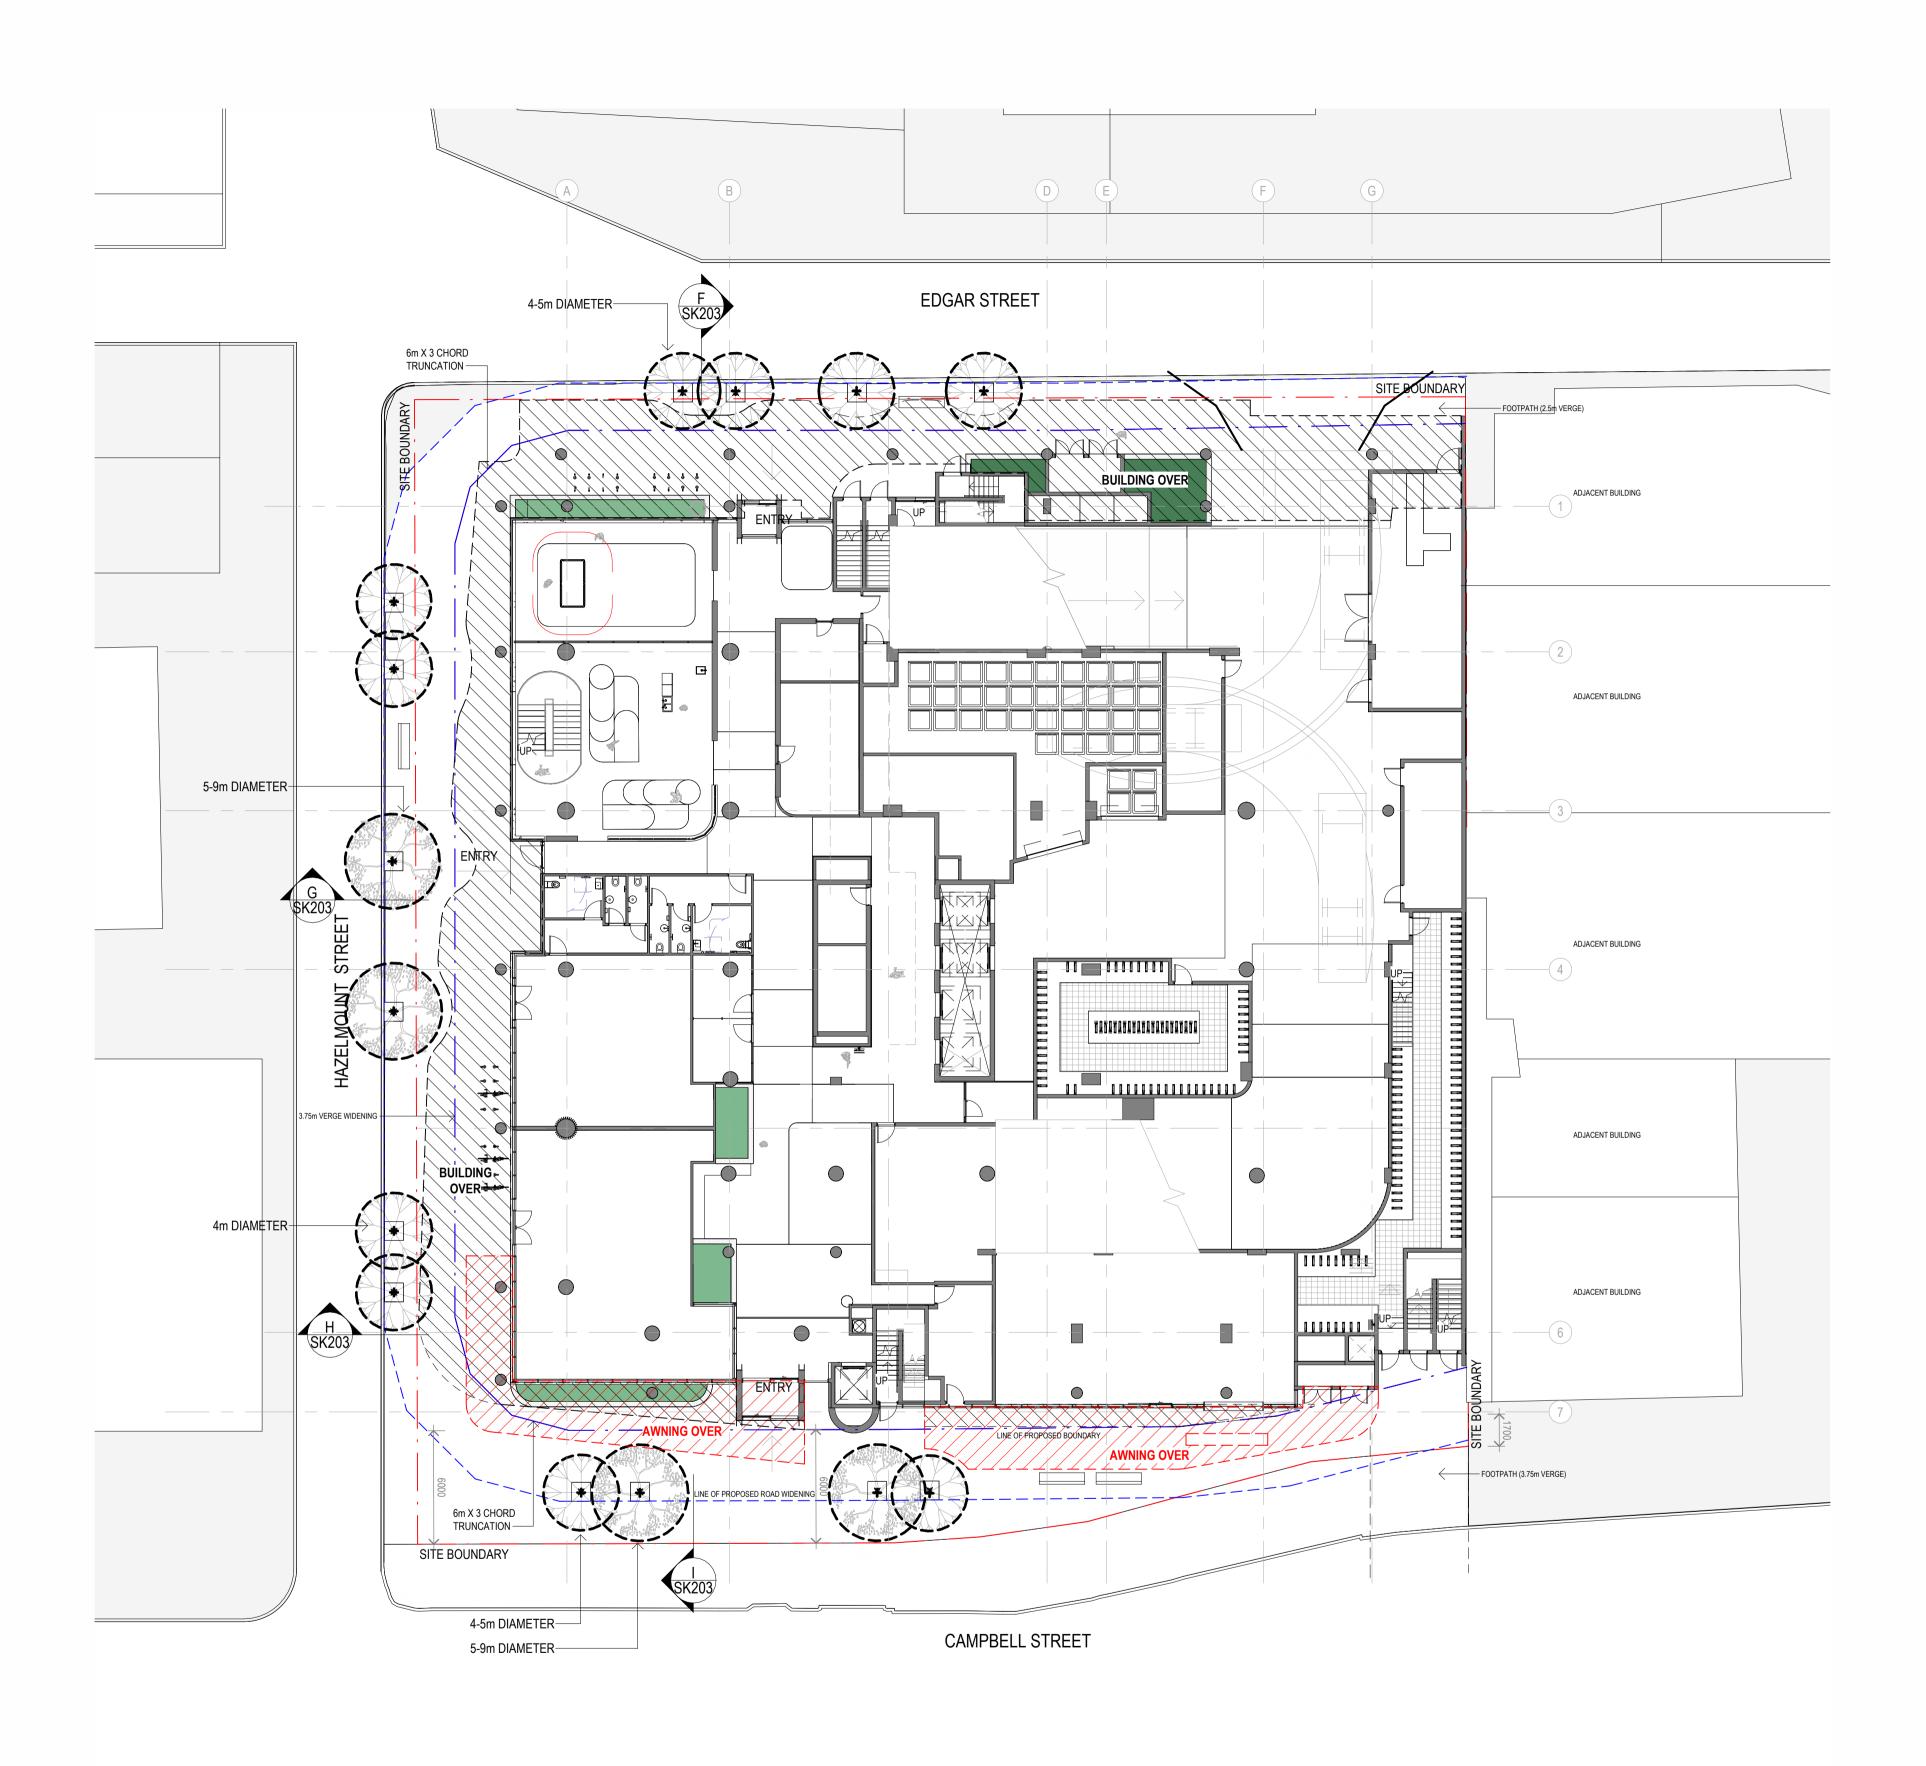
Project Address
19- 25 Campbell
Street, Bowen Hills

SITE PLAN - LOT DIAGRAM


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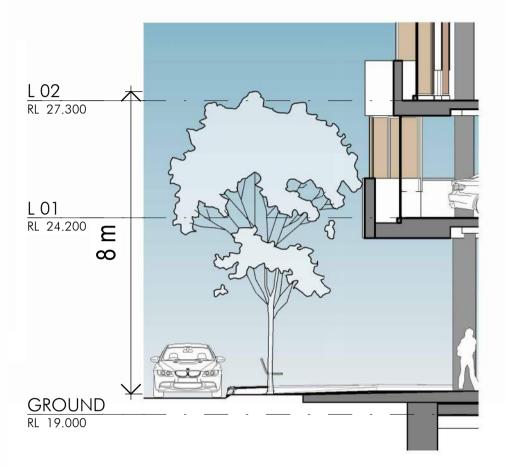
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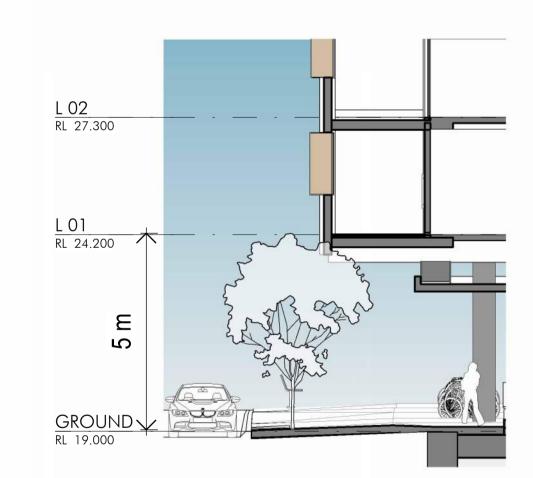
1 GROUND FLOOR - COVERED AREA PLAN 1:200




F STREET TREE SECTION - EDGAR



G STREET TREE SECTION - HAZELMOUNT A

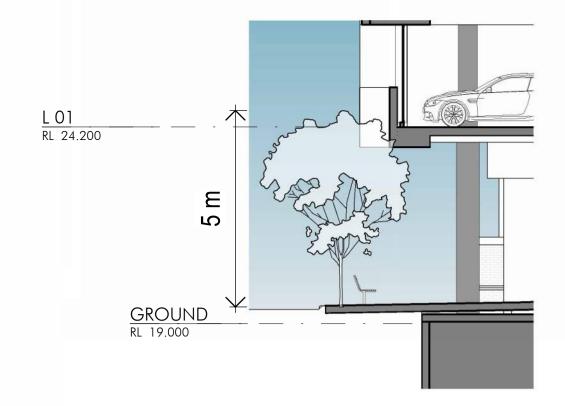

H STREET TREE SECTION - HAZELMOUNT B

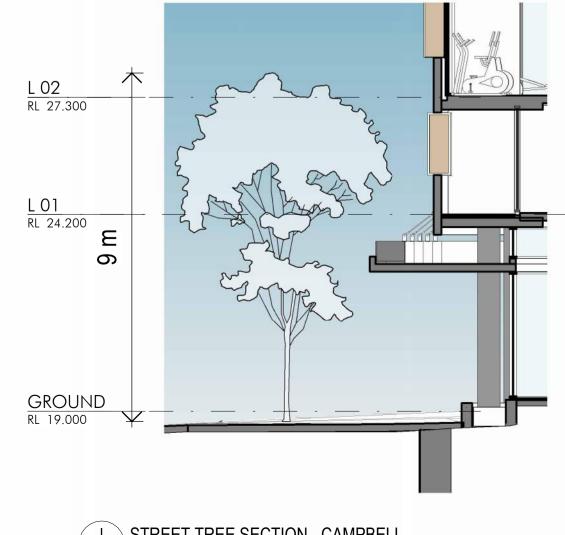


STREET TREE SECTION - CAMPBELL 1:100

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Key Plan

2000 5000

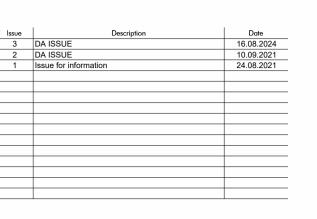

Project Name

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Project Address

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Street, Bowen Hills


GROUND FLOOR - COVERED AREA PLAN

Author: Checker: Sheet Size: Scale:

JF MH A1

Drawing Number: Issue: 3

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Key Plan

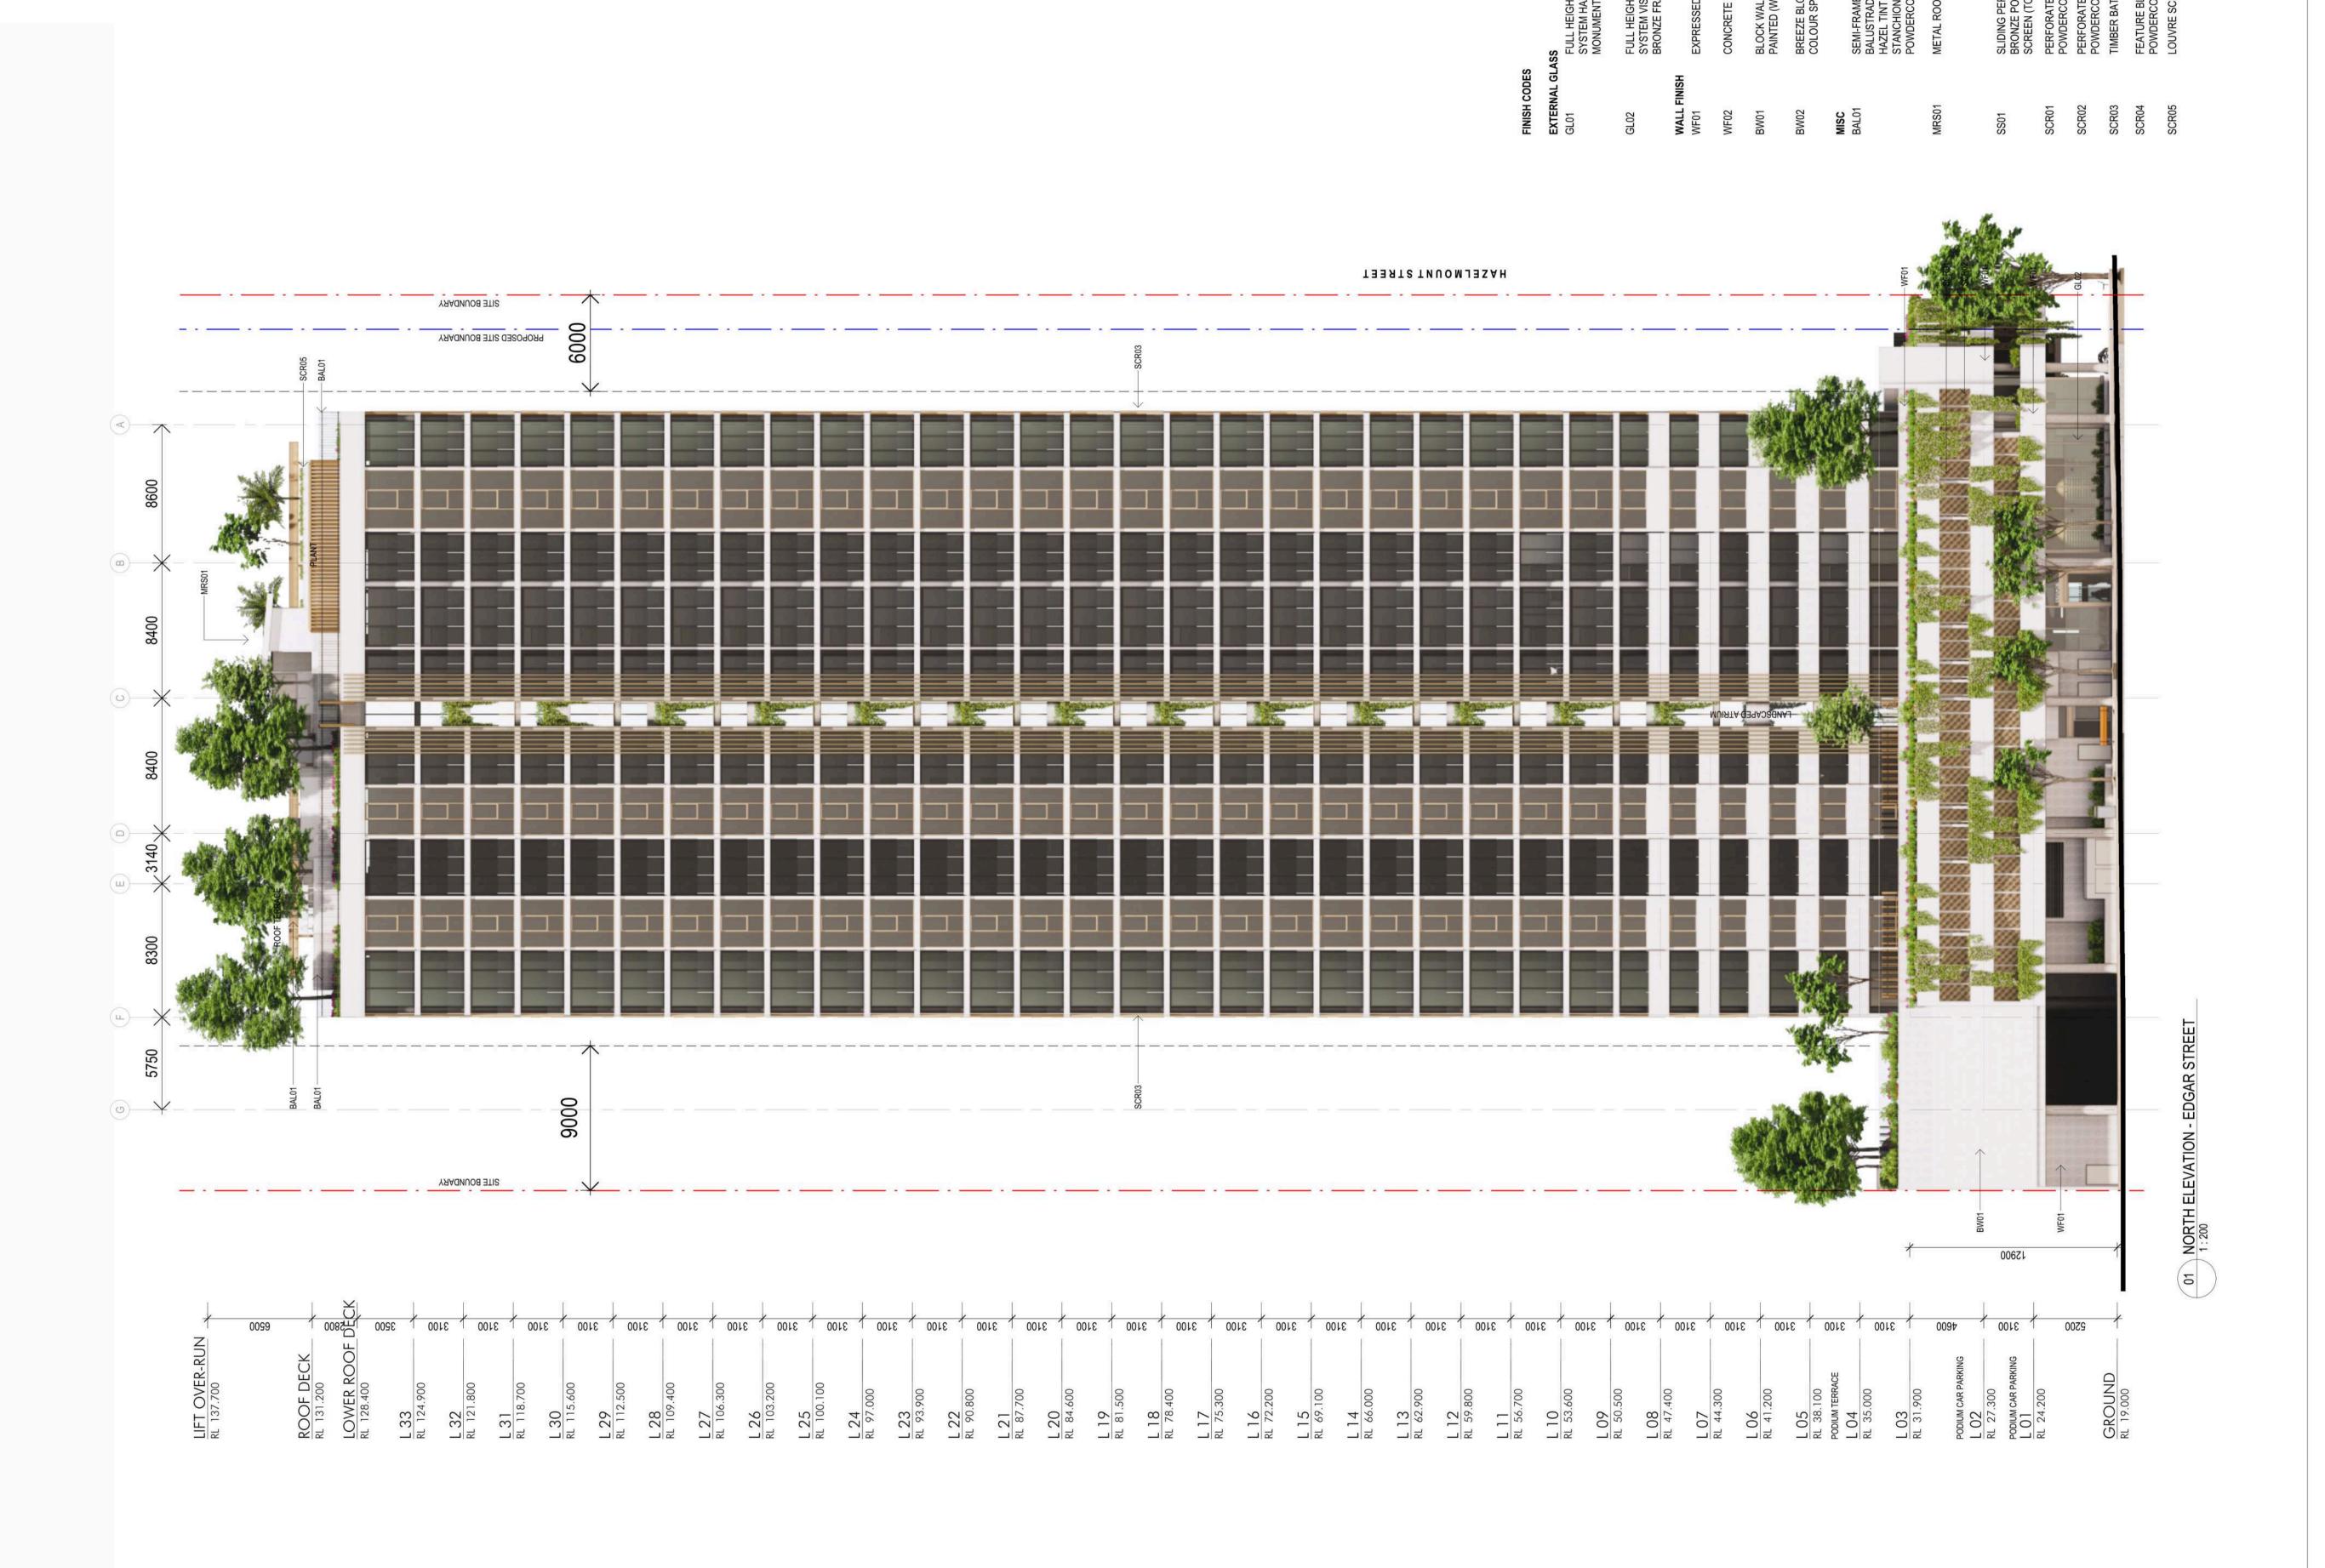4000 10000

Project Name

BOWEN HILLS RESIDENTIAL

Project Address
19- 25 Campbell
Street, Bowen Hills


NORTH ELEVATION

Author: Checker: Sheet Size: Scale: 1:200

Drawing Number: Sheet Size: Scale: 1:200

11703_SK210

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Key Plar

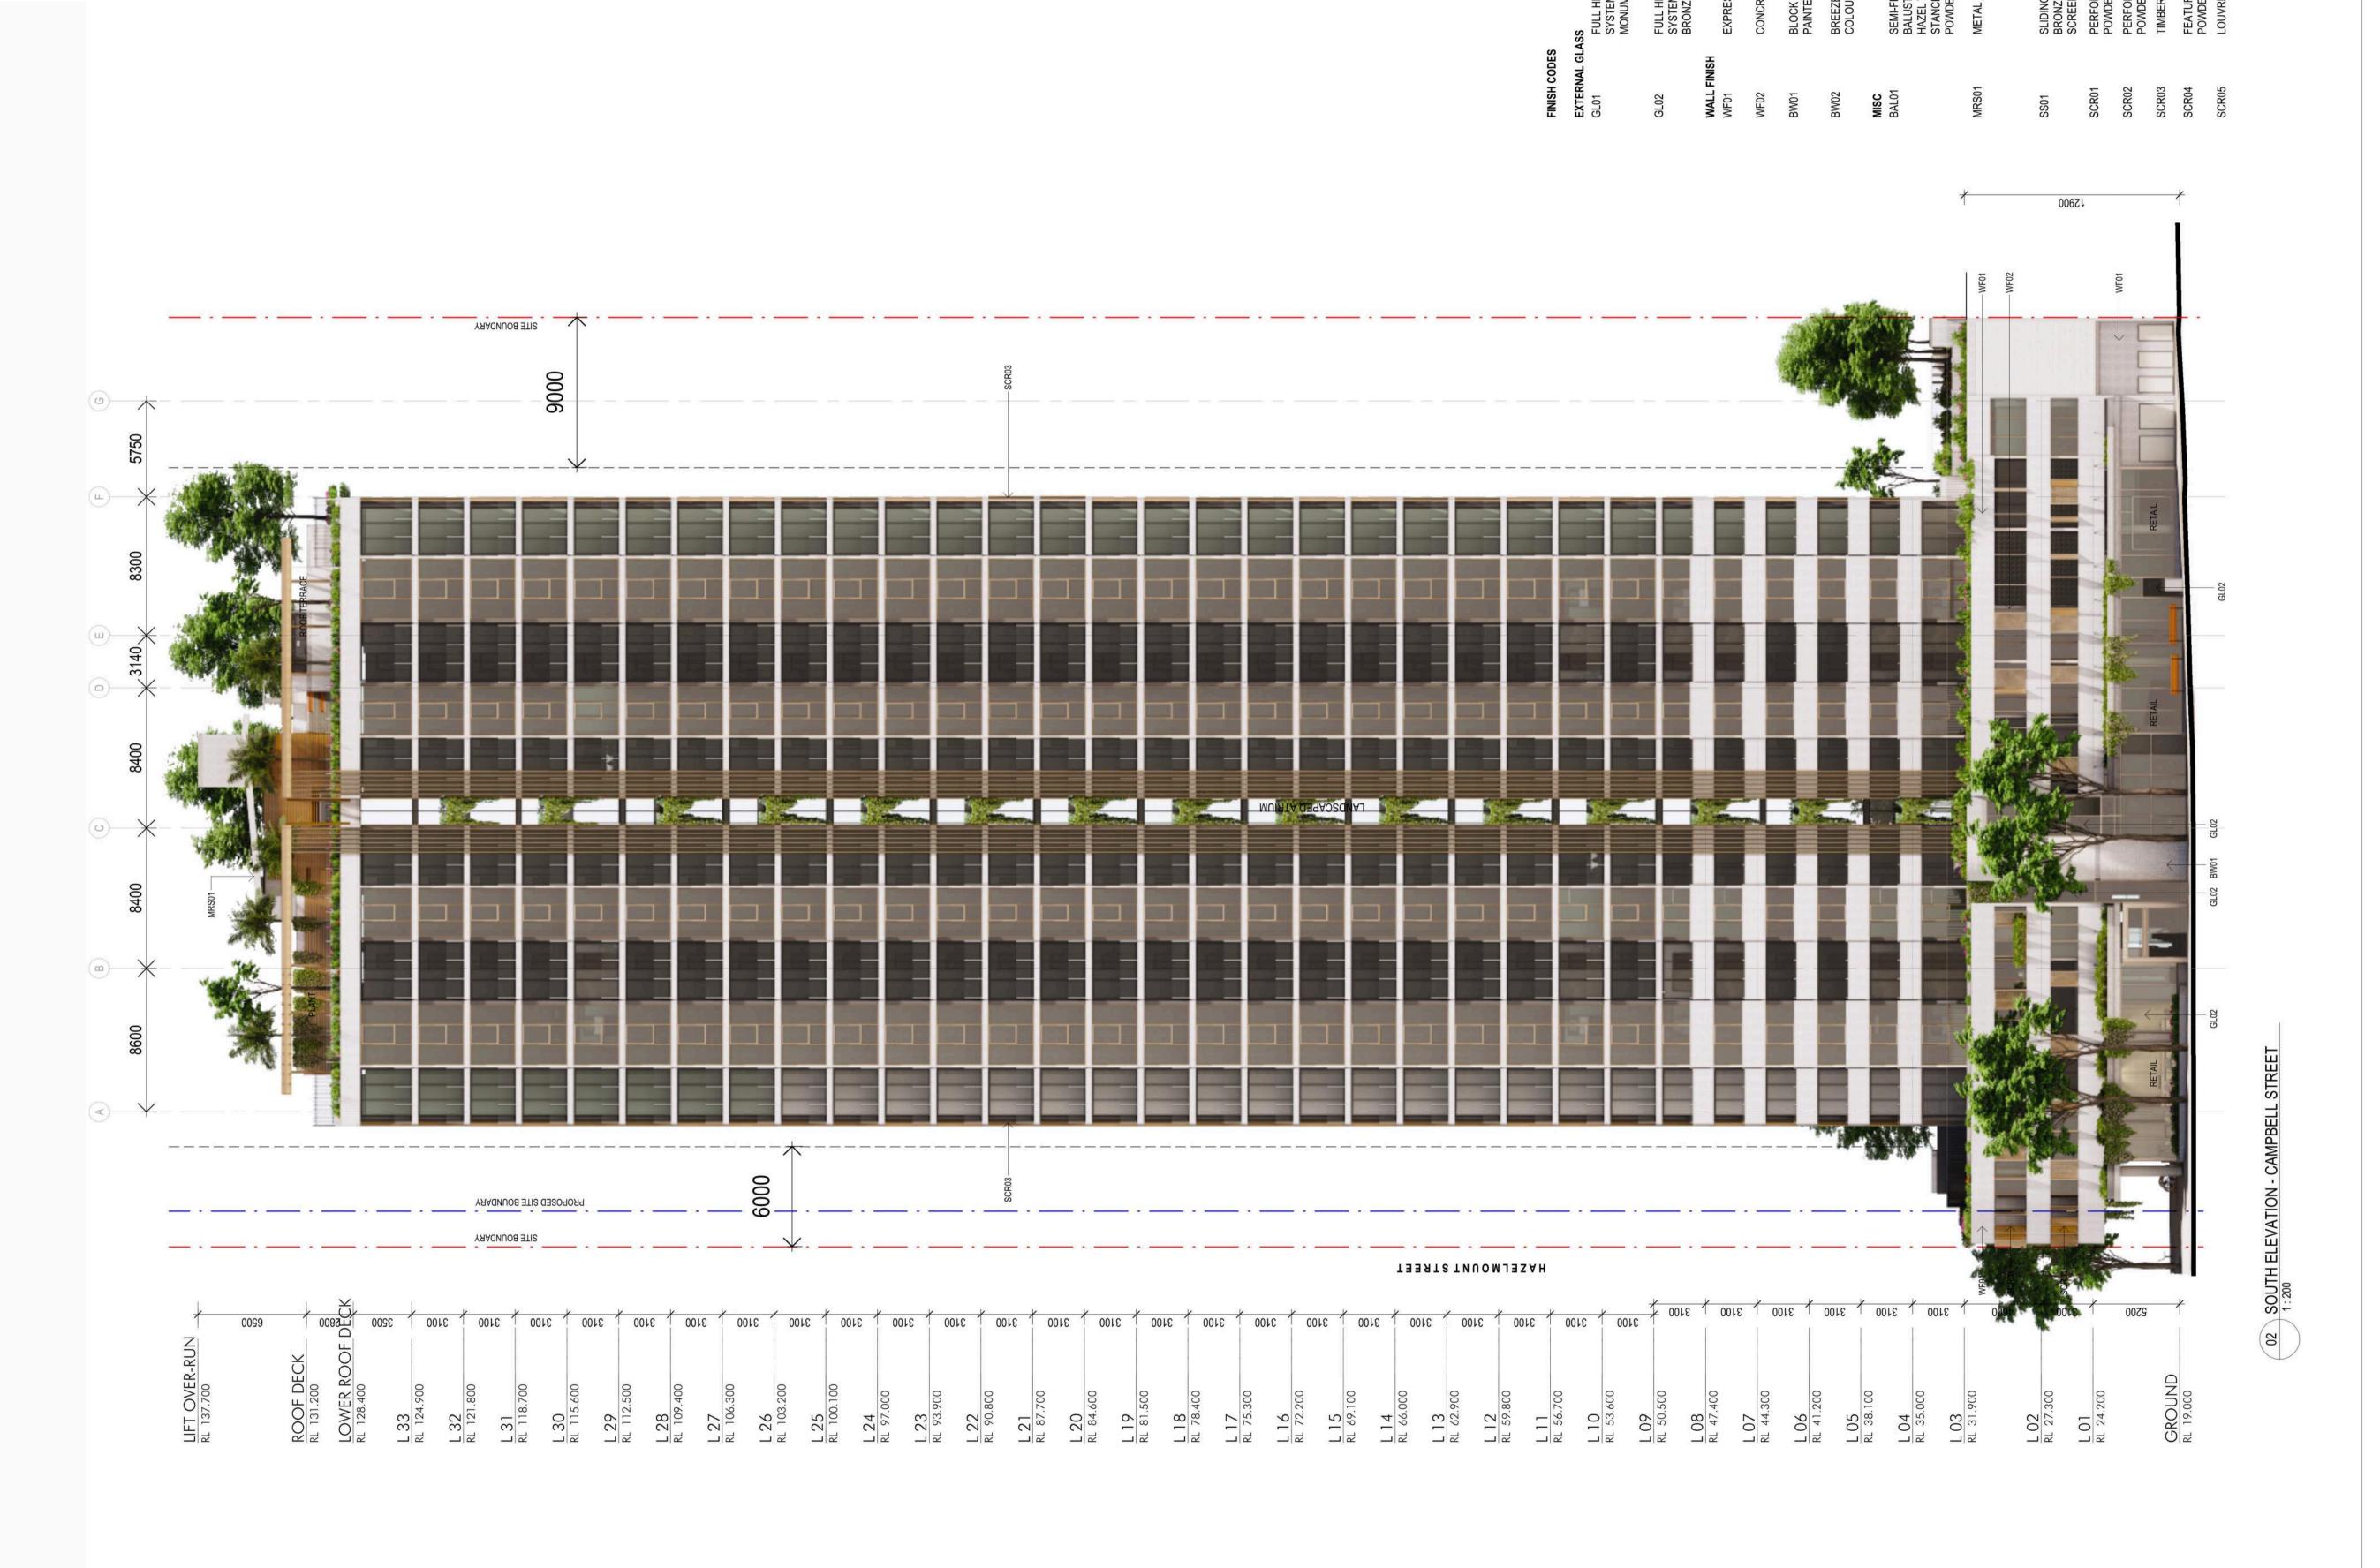4000 10000

Issue	Description	Date
4	DA ISSUE	16.08.2024
3	DA ISSUE	10.09.2021
2	ISSUE FOR DEVELOPMENT APPLICATION	07.05.2021
1	DRAFT DA	22.04.2021

Project Name
BOWEN HILLS
RESIDENTIAL

Project Address
19- 25 Campbell
Street, Bowen Hills

SOUTH ELEVATION

Author:	Checker:	Sheet Size:
NO	MH	A 1
Drawing Number	n.	
1170	13 SK	211

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Key Plan

4000 10000

ssue	Description	Date
4	DA ISSUE	16.08.2024
3	DA ISSUE	10.09.2021
2	ISSUE FOR DEVELOPMENT APPLICATION	07.05.2021
1	DRAFT DA	22.04.2021

Project Name
BOWEN HILLS
RESIDENTIAL

Project Address
19- 25 Campbell
Street, Bowen Hills


WEST ELEVATION

Author:	Checker:	Sheet Size
NO	MH	A1
Drawing Numbe	r.	

11703_SK212

nettletontribe

Scale: 1:200

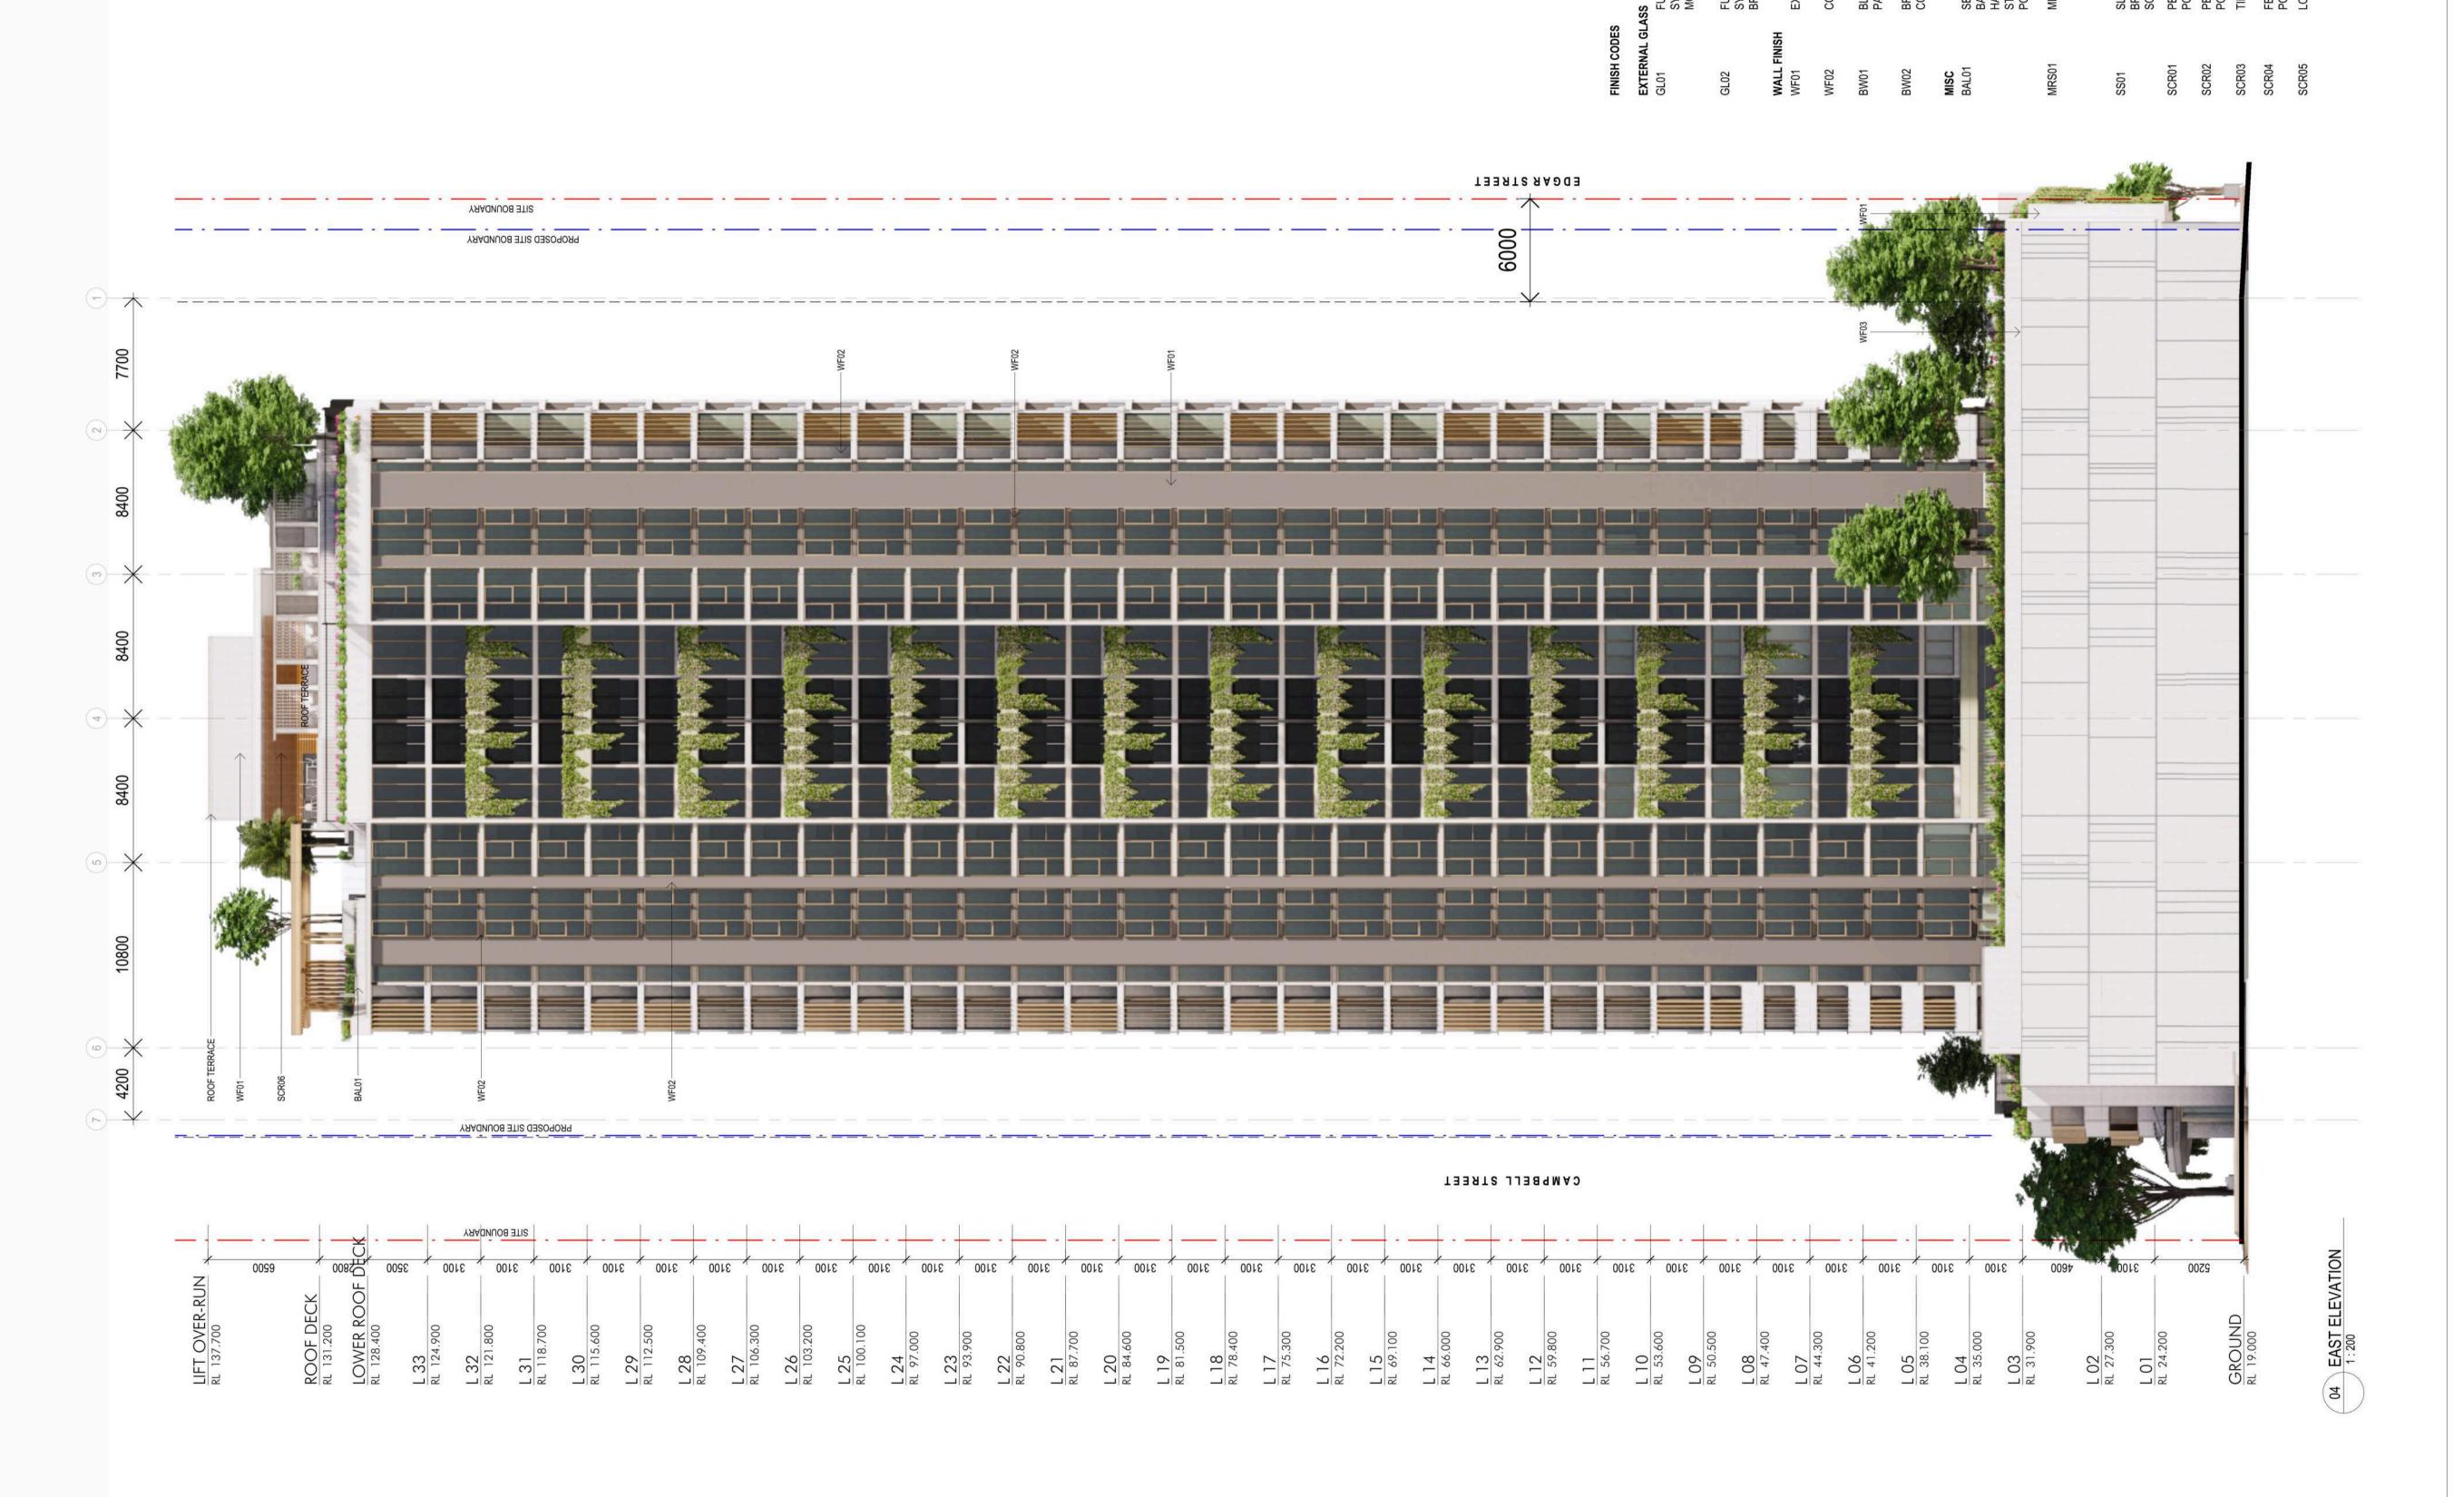


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Project Name **BOWEN HILLS** RESIDENTIAL Project Address
19- 25 Campbell
Street, Bowen Hills

Drawing Title EAST ELEVATION

Sheet Size: Scale: 1:200 11703_SK213

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Key Pl

2y Fiair 4000 10000

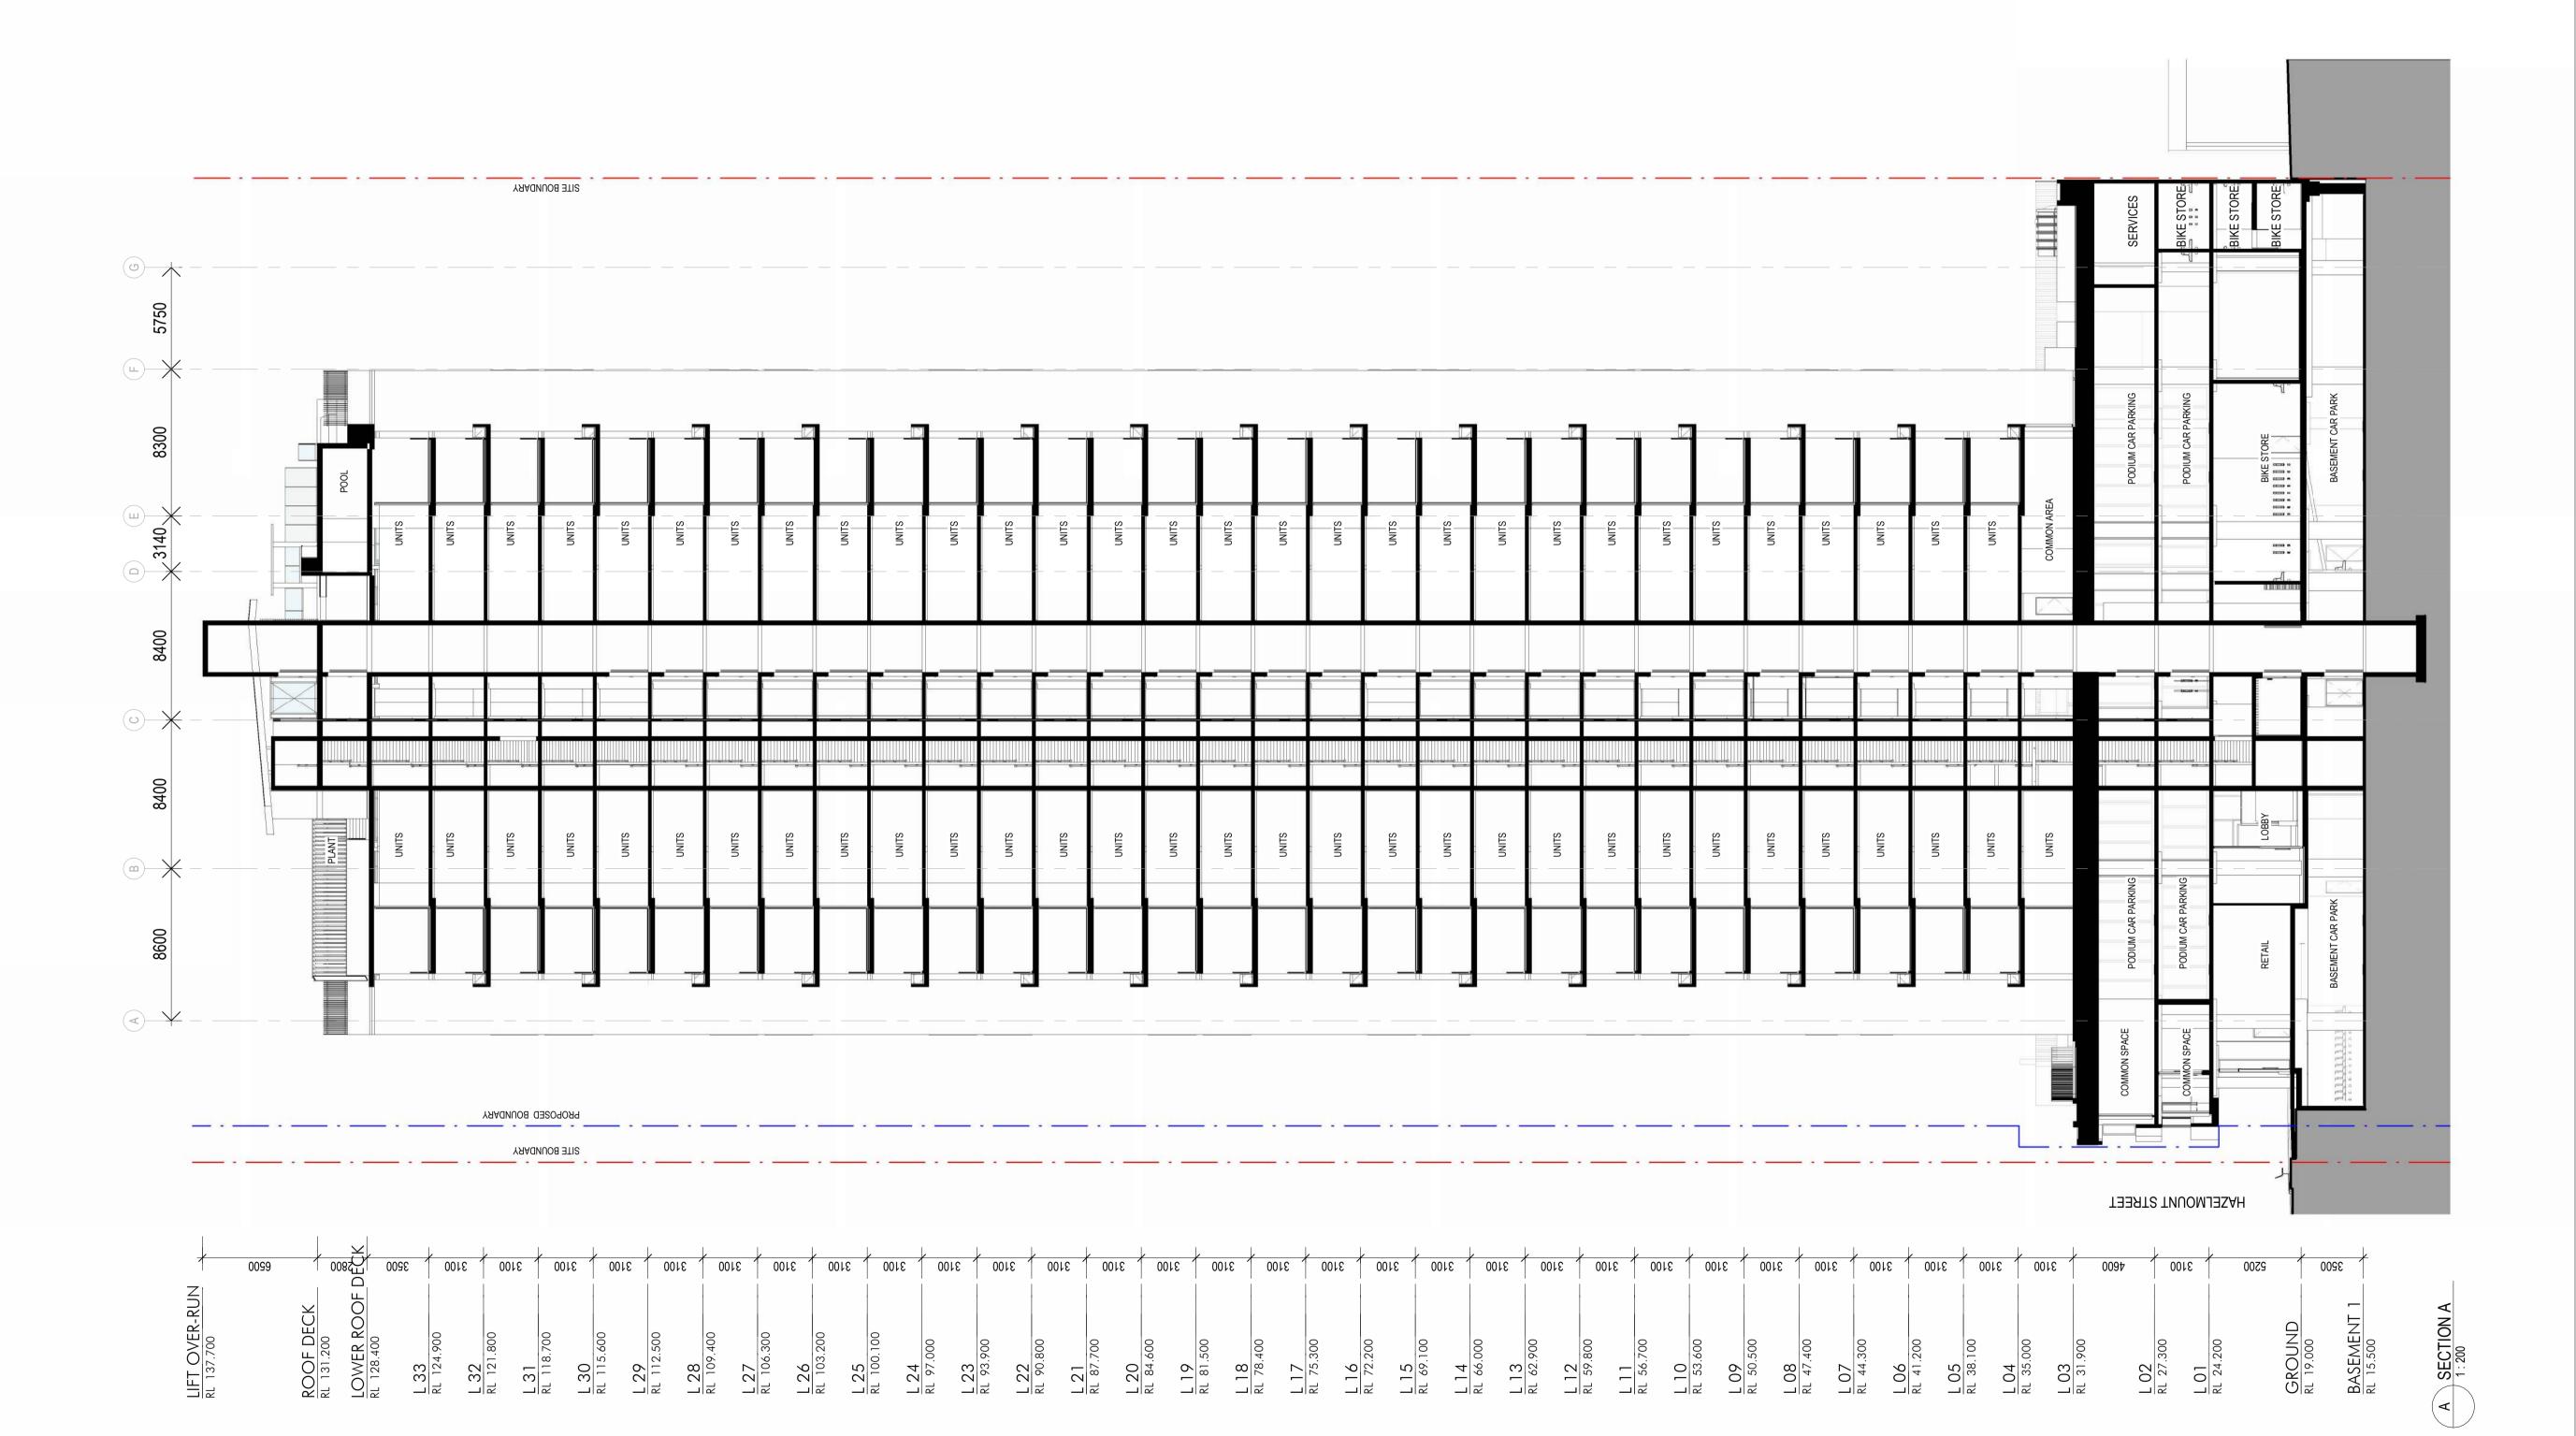Project Name

BOWEN HILLS

RESIDENTIAL

Project Address
19- 25 Campbell
Street, Bowen Hills

SECTION A-A


Author: Checker: Sheet Size: Scale: 1:200

Drawing Number: I 1703_SK302

Scale: 1:200

Issue: 3

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Project Name

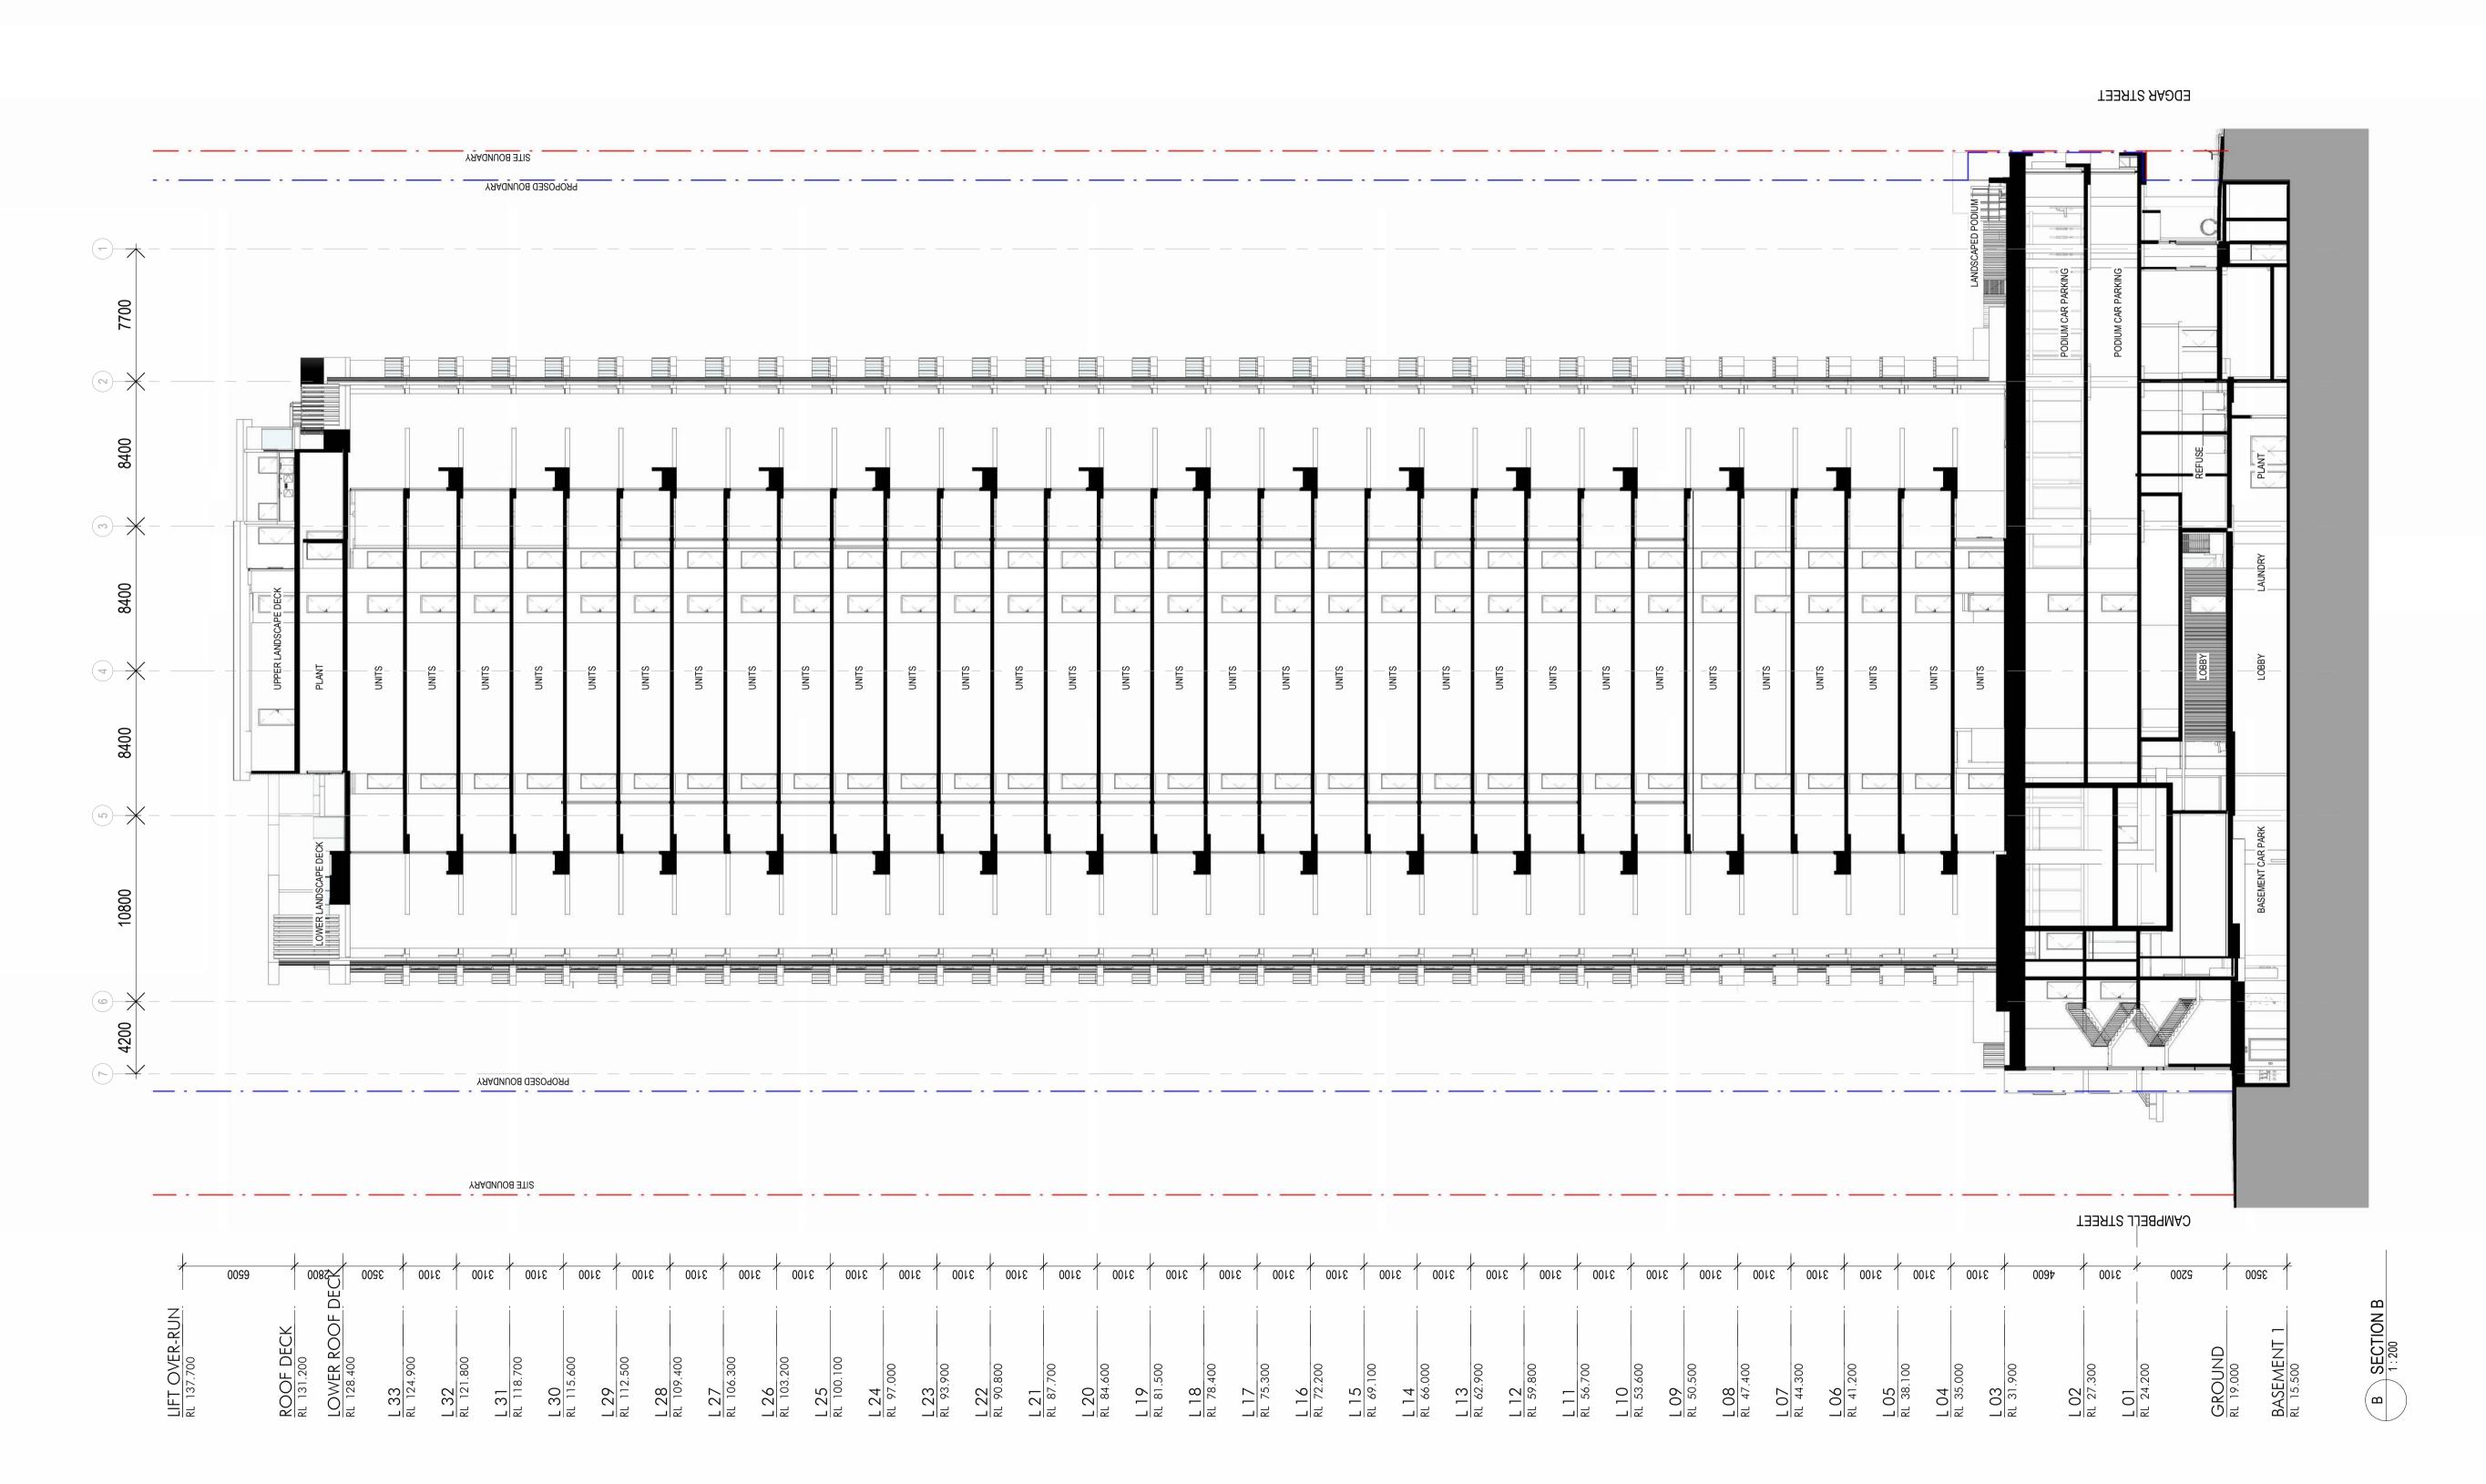BOWEN HILLS

RESIDENTIAL

Project Address
19- 25 Campbell
Street, Bowen Hills

SECTION B-B

 Author:
 Checker:
 Sheet Size:
 Scale:

 NO
 MH
 A1
 1:200


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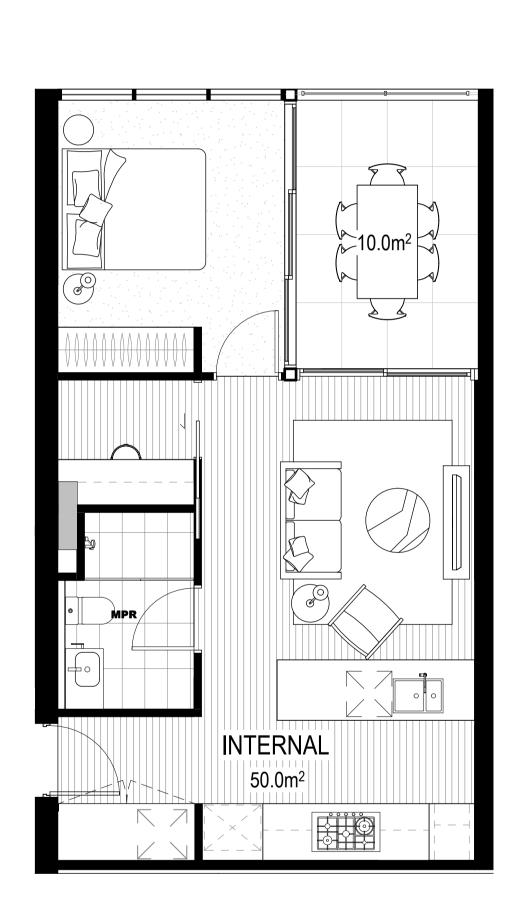
 11703_SK303
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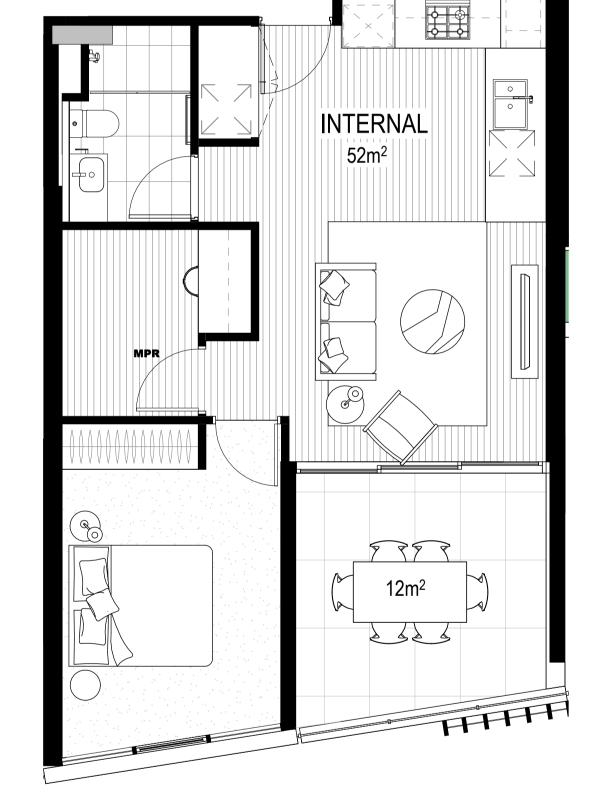
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e: brisbane@nettletontribe.com.au w: nettletontribe.com.au







2 UNIT 1B-B 1:50 3 UNIT 1B-C 1:50 Builder and/or subcontractors shall verify all project dimensions before commencing on-site work or off-site fabrication. Figured dimensions shall take precedence over scaled dimensions. This drawing is copyright and cannot be reproduced in whole or in part or by any medium without the written permission of Nettleton Tribe Partnership Pty Ltd.

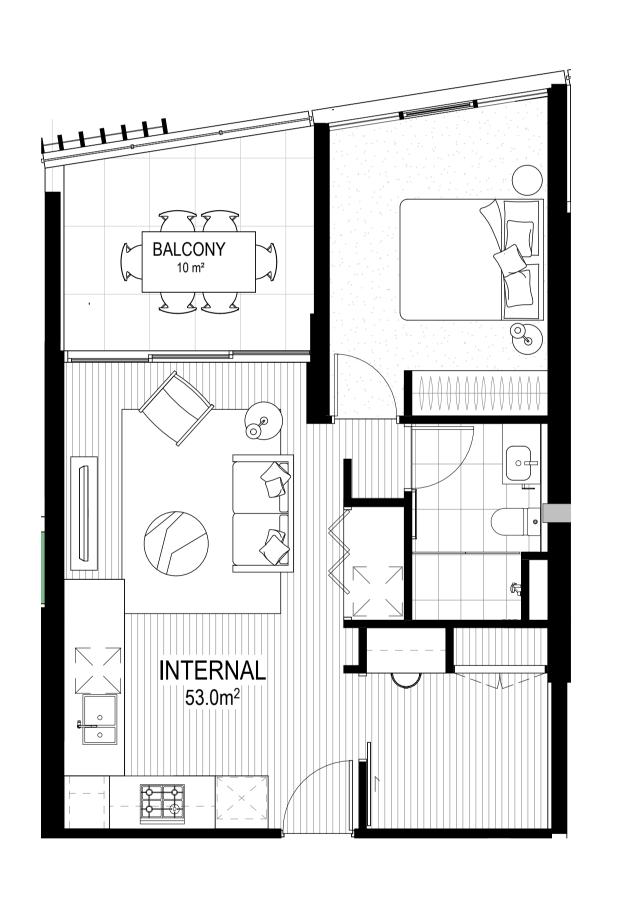Key Plan

1000 2500

Client

Builder

Project Name

BOWEN HILLS

RESIDENTIAL

Project Address
19- 25 Campbell
Street, Bowen Hills


Drawing Title APARTMENT LAYOUTS

Author: Checker: Sheet Size: NO MH A1


Drawing Number:

Drawing Number: 11703_SK501

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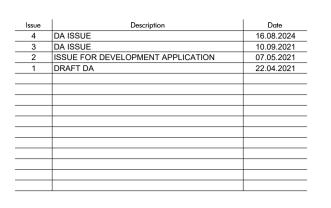


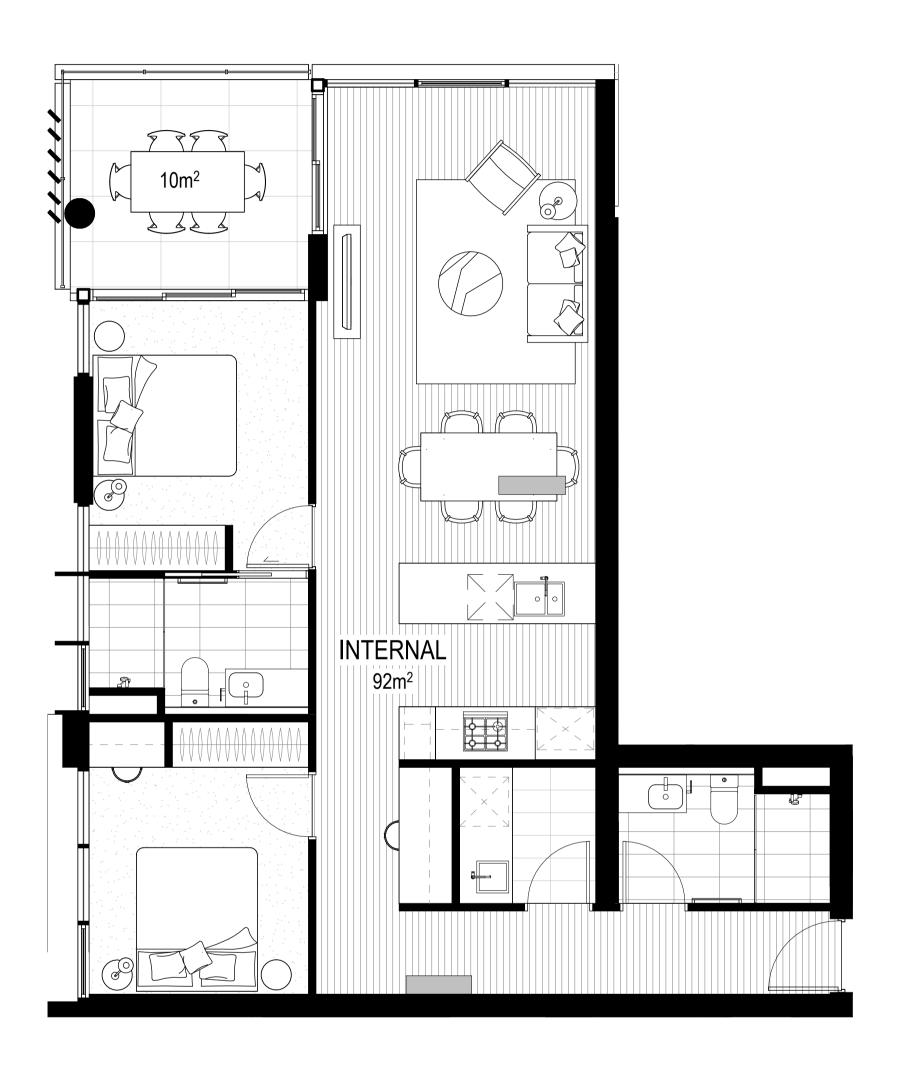1 UNIT 2B-A

2 UNIT 2B-B 1:50 3 UNIT 2B - C DD2001 1:50

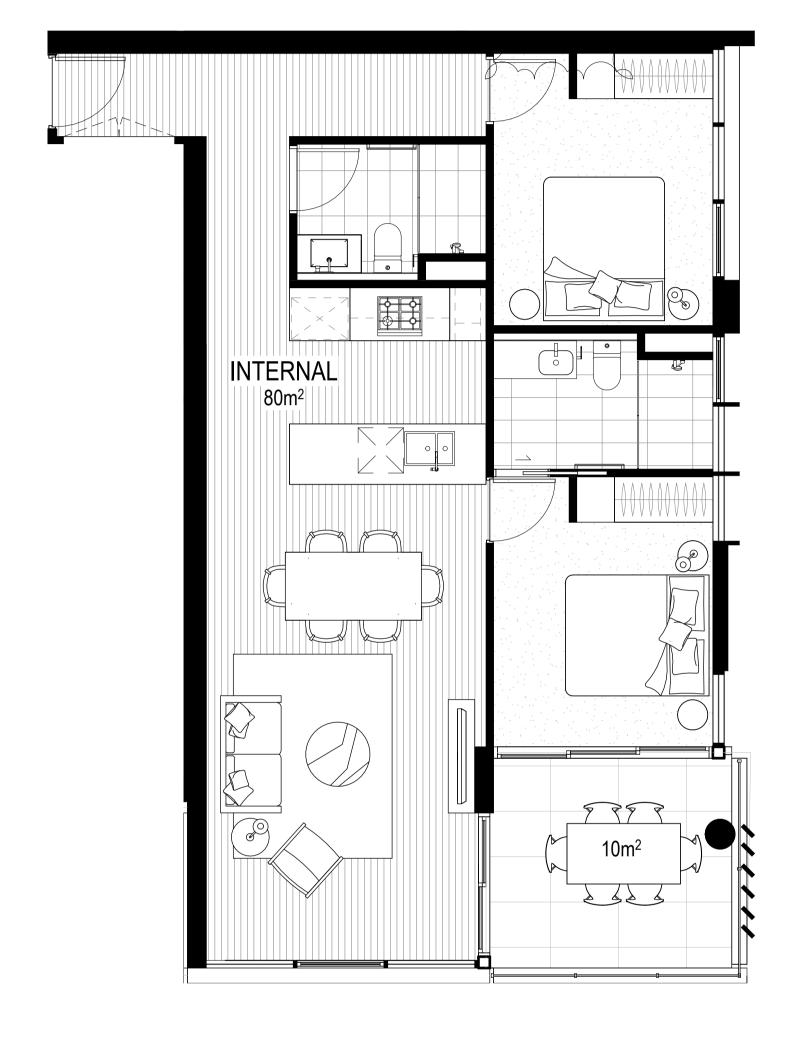Builder and/or subcontractors shall verify all project dimensions before commencing on-site work or off-site fabrication. Figured dimensions shall take precedence over scaled dimensions. This drawing is copyright and cannot be reproduced in whole or in part or by any medium without the written permission of Nettleton Tribe Partnership Pty Ltd.

Key Pla



Project Name
BOWEN HILLS
RESIDENTIAL

Client

Project Address
19- 25 Campbell
Street, Bowen Hills

APARTMENT LAYOUTS


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Drawing Number: 11703_SK504

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2 UNIT S - A

Builder and/or subcontractors shall verify all project dimensions before commencing on-site work or off-site fabrication. Figured dimensions shall take precedence over scaled dimensions. This drawing is copyright and cannot be reproduced in whole or in part or by any medium without the written permission of Nettleton Tribe Partnership Pty Ltd.

Key Plan

2000 5000

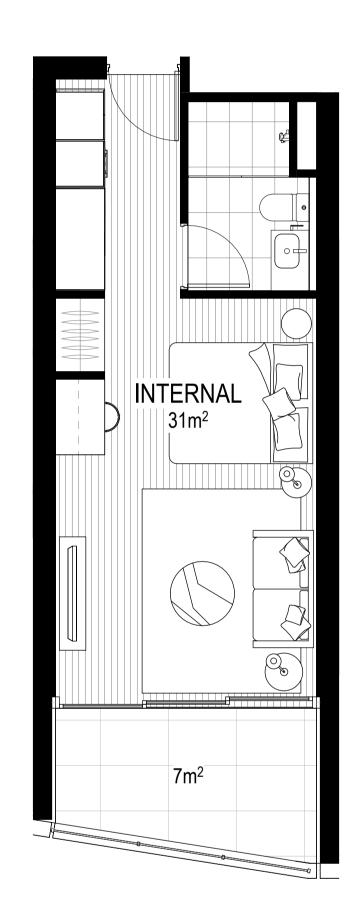16.08.20 10.09.20
10.09.20

Client

Project Name

BOWEN HILLS

RESIDENTIAL

Project Address
19- 25 Campbell
Street, Bowen Hills

Drawing Title
APARTMENT LAYOUTS


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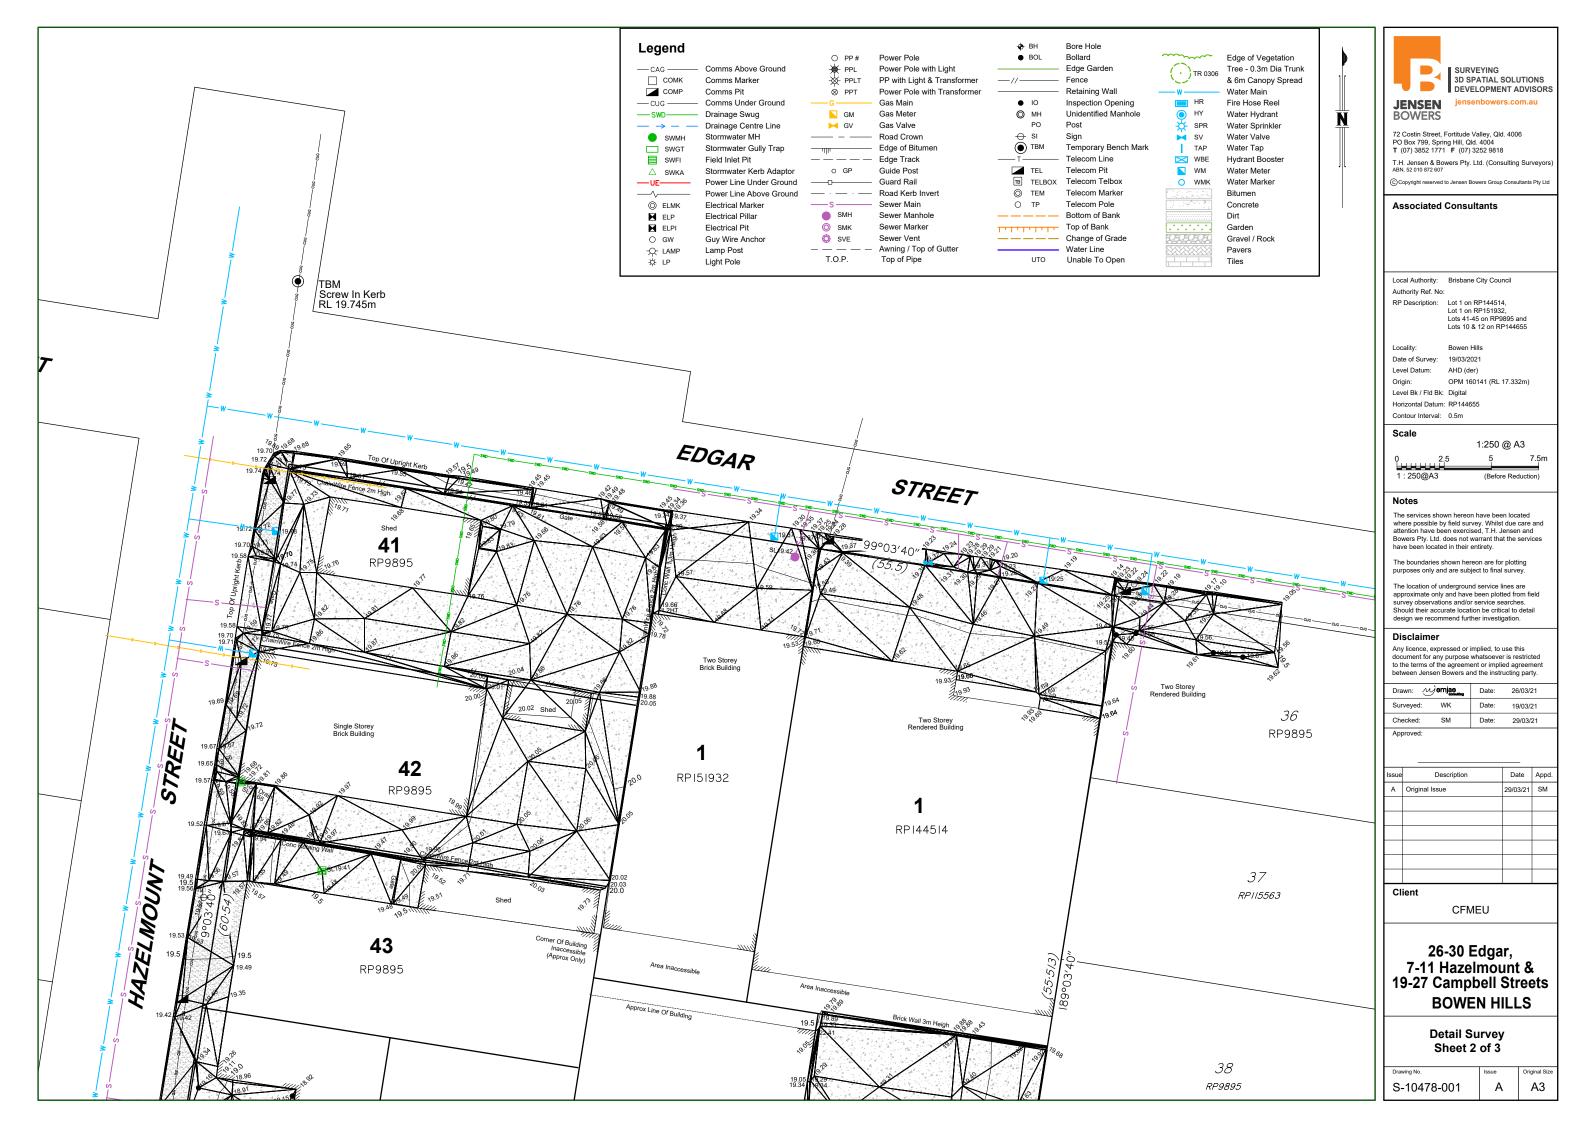
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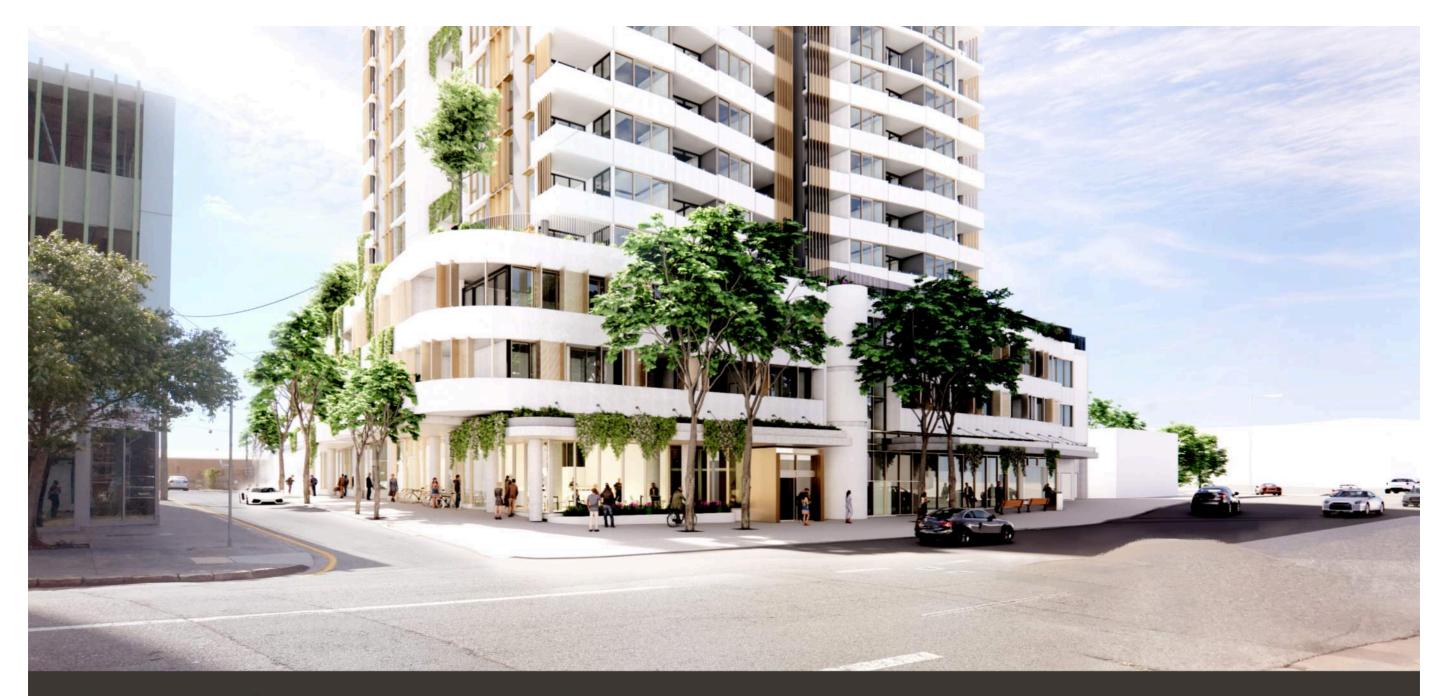
Appendix

B: Survey







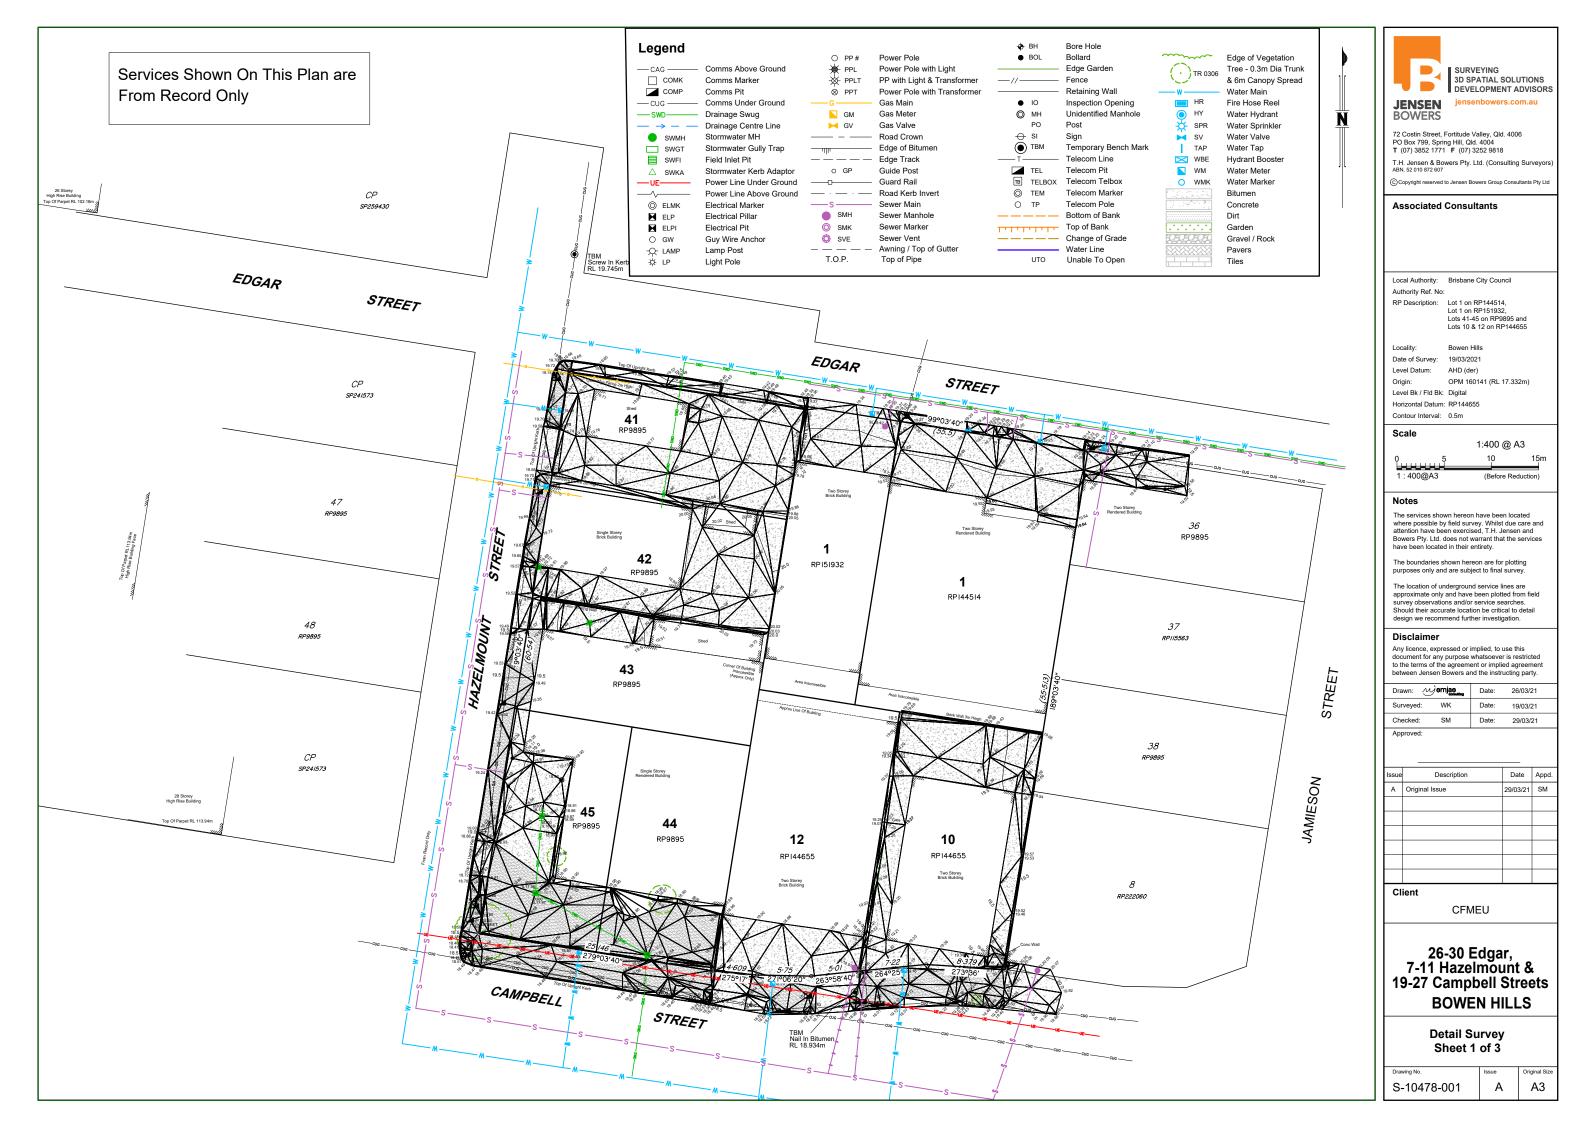

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