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APPROVAL FOR ISSUE

Name	Signature	Date
William Nuthun	Willey	04.08.23
Matthew Brown	Men	04.08.23

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1 INTRODUCTION

1.1 General

ADG Engineers (Aust.) Pty Ltd has been engaged by Fortezza Group to prepare an Engineering Services Report (ESR) in support of a Development Application associated with a proposed residential development, which is located within the Weinam Creek Priority Development Area (PDA) at 57 Banana Street, Redland Bay 4165 QLD, henceforth referred to as *the site*.

This ESR has been revised following changes to the site layout and the commencement of roadworks and service relocation surrounding the site, which necessitate modification to the engineering services strategy.

The development consists of a multi-storey apartment building over a basement carpark.

The purpose of this ESR is to provide advice as to the development proposal detailed in the Architectural drawings in Appendix A. The works described herein are subject to further Council approvals as wells as any nominated agencies and cover works required to service the proposed development with regards to earthworks, roadworks, stormwater drainage, sewerage and water supply, electricity, communications and gas.

1.2 Background

This report was compiled using information from the following sources:

- Architectural plans supplied by HAL Architects (refer to Appendix A);
- Detailed Surveys (refer to Appendix B);
- ADG Preliminary Civil Drawings (refer to Appendix C);
- Engineering Solutions Qld (ESQ) Approved Design Drawings for ongoing Weinam Creek Priority Development Area Stage 3A (refer to Appendix D);
- 'Dial Before You Dig' (DBYD) information (refer to Appendix E); and
- Google Maps and Nearmap Aerial Imagery.



2 THE SITE

2.1 Location

The site is located in Redland Bay, Queensland. The site is bound by existing residential lots to the north and south, Banana Street to the east and Outridge Street to the west. The existing vacant lot to the north of the site has been resumed and roadworks are presently underway that will result in construction of a new road (Hamilton Street) along the northern boundary of the site as shown in Figure 2.

The titles that make up the site are given in **Table 1**. Refer to the architectural drawings in **Appendix A** for further details. **Figure 1** displays the locality of the site.

Table 1 – Property Details

Lot Title	Lot 8 on RP80201
Street Address	57 Banana Street, Redland Bay 4165 QLD
Site Area	835m ²

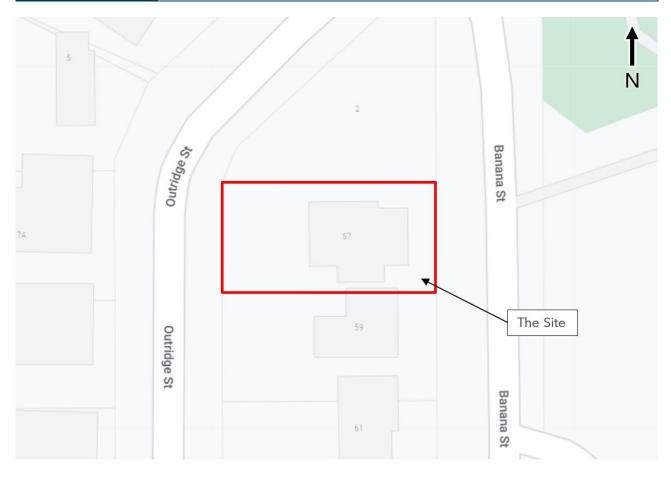


Figure 1 - Locality Map (Accessed on 01.06.2022 from Google Map)



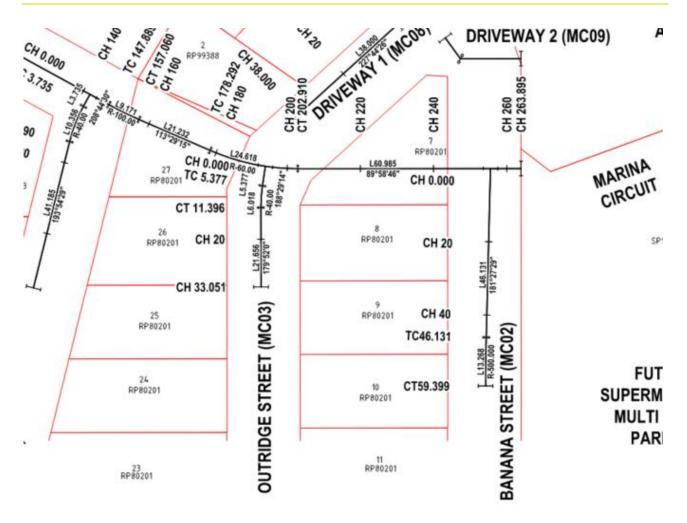


Figure 2 - New Road Alignment (EDQ Design Drawing C-1005[5], dated 06/10/2022)



3 PLAN OF DEVELOPMENT

3.1 The Proposal

The proposed development as described in the architectural drawings in **Appendix A** is for a multi-storey residential apartment building over basement carpark. **Figure 2** illustrates the proposed development.



Figure 3 - Proposed Development



4 CHARACTERISTICS OF THE LAND AND SURROUNDING AREA

4.1 Description

The site is currently occupied by a two-storey detached dwelling with existing access driveways to both Banana Street and Outridge Street, and is located within the Weinam Creek Priority Development Area.

4.2 Dimensions

The proposed development has an area of 835m² with a road frontage of 20.74m to both Banana Street to the east and Outridge Street to the west. The north and south boundaries of the site are 40.24m wide.

4.3 Topography

Based on Council topographic records, a single catchment has been identified across that site that generally falls from west to east towards Banana Street with an average grade of approximately 1%.

4.4 Features

The existing site is occupied by a multi-storey residential building and two driveways, and a small, planted garden located in the north-western corner of site. The balance of the site is characterised by good grass cover. The features described above result in an existing fraction impervious across the development site equal to approximately 36%. Figure 3 illustrate the existing site features.

4.5 Accessibility

Access to the site is currently gained via driveways to both Banana Street at the eastern site boundary and Outridge Street at the south-west site boundary. As a part of the proposed development one (1) new driveway will be constructed to suit the site layout and existing redundant crossovers are to be demolished. Refer to the architectural drawings in **Appendix A** for further detail. The primary vehicle access to the site will be gained via the western boundary of site to Outridge Street and will facilitate access to the proposed carparking areas.

4.6 Easements

No easements have been identified across the existing site.

4.7 Surrounding Land Use

As discussed in Section 2.1, the site bound by Outridge Street to the west, Banana Street to the east, and residential allotments to the south.

4.8 Coastal Erosion Hazard

Council's City Plan Coastal Erosion Hazard overlay mapping has identified the site as an erosion prone area. Refer to the Stormwater Management Plan by ADG Engineers (Report ID: 26164 SMP) for details regarding stormwater quality control, including erosion and sediment control.





Figure 4 – Site Condition (Nearmap Image dated 22.03.2022)



5 EARTHWORKS

5.1 Proposed Earthworks

The proposed development will require excavation to facilitate the construction of the basement car parking level that extend across the proposed development. Due to the proximity of the basement extent to the site boundaries shoring will be required to facilitate the basement construction.

Detailed earthworks drawings will be designed in accordance with specialist Geotechnical reports and will be provided as part of a future operational works application during detailed design.

5.2 Slope Stability

Council's City Plan has identified that the site is not located in an area subject to slope instability.

5.3 Acid Sulfate Soils

Acid Sulfate Soils are soils which contain iron sulphides generally found in low-lying coastal areas below 20m AHD. The levels across the site vary from a low point of 2.0m AHD to a high point of 2.75m AHD. These levels are below 20m AHD, indicating the site may be subject to Acid Sulfate Soils.

The development may encounter Acid Sulfate Soils during excavation of the basement. If Acid Sulfate Soils are encountered and Acid Sulfate Soils management plan will be prepared and enacted.



6 ROADWORKS

6.1 Existing Infrastructure

The site is fronted by Banana Street to the east and Outridge Street to the west. The existing vacant lot to the north of the site has been resumed and roadworks are presently underway that will result in construction of a new road (Hamilton Street) along the northern boundary of the site.

Banana Street consists of an approximately 12.50m wide road pavement which facilitates a 3.50m wide travel lane in each direction, and 2.75m parking lanes on both sides of the road. The pavement cross-section of Banana Street consists of a two-way cross fall and crown in the centre such that stormwater flows away from the crest towards a kerb and channel located on both sides of the road. The travel lanes on Banana Street are divided by a broken centre line opposite the site. A no-stopping zone extends across much of the site frontage on both sides of the road preventing on-street parking in some sections.

Outridge Street consists of an approximately 8m wide road pavement. The pavement cross-section of Outridge Street consists of a two-way cross fall and a crown in the centre such that stormwater flows away from the crest and towards a mountable kerb and channel located on both sides of the road. There is no line marking on Outridge Street opposite the site.

Refer to the detailed site survey in Appendix B for further information of the existing infrastructure.

6.2 Proposed Infrastructure

As discussed in Section 4.5, one (1) new driveway is proposed via the western boundary of site to Outridge Street and will facilitate access to the proposed carparking areas. Any existing redundant vehicular crossovers are to be removed and kerb and channel reinstated to match existing. No other roadworks are proposed as part of the development. Refer to Section 4.5 and the architectural drawings in **Appendix A** for further information.



7 WATER SUPPLY

7.1 Existing Infrastructure

The following water infrastructure assets have been identified in the vicinity of the site using the detailed site survey:

- A DN100 Asbestos Cement (AC) water main (Asset ID: 8245) runs parallel to the site boundary along the development side verge of Banana Street;
- A DN100 Asbestos Cement (AC) water main (Asset ID: 8244) runs parallel to the site boundary along the non-development side verge of Outridge Street.

EDQ Approved Design Drawings for ongoing Weinam Creek Priority Development Area Stage 3A has identified the following under construction water infrastructure within the vicinity of the site:

 A DN150 water main is presently being constructed parallel to the north, east and west site boundaries along the development side verges of Hamilton Street, Banana Street and Outridge Street.

Refer to the detailed site survey in **Appendix B** and EDQ Approved Design Drawings in **Appendix D** for more details on the existing water infrastructures.

7.2 Proposed Infrastructure

It is expected that the existing watermain along the development side of Hamilton Street will facilitate a new property connection. The proposed connection will be provided to the development site within a dedicated, on-site easement in accordance with the latest RCC standard drawings. The final size of the connection/s are to be confirmed by the hydraulic engineer at the detailed design phase. Any redundant connections found that remain following these works will be decommissioned in accordance with Council guidelines.

Council has advised that the existing water infrastructure has insufficient capacity to support the proposed development. ADG understand that EDQ and RCC are currently upgrading this infrastructure to cater to the Weinam Creek PDA. Once this infrastructure is in place the network will have sufficient capacity to service this development.

A preliminary layout of the proposed connection network prepared by ADG can be found on C50 in **Appendix C**. Detailed water reticulation drawings will be provided as part of future operational works application once the development has been approved.



8 SEWER RETICULATION

8.1 Existing Infrastructure

The following sewer infrastructure have been identified in the vicinity of the site using detailed site survey:

- A DN150 unplasticised Poly Vinyl Chloride (uPVC) gravity sewer main (Asset ID: 29600) located within the development side verge of Outridge Street flows north; and
- A DN100 uPVC property connection (Asset ID: 117304) services the site from the abovementioned sewer main, located in the south-west corner of the site.

EDQ Approved Design Drawings for ongoing Weinam Creek Priority Development Area Stage 3A has identified the following under construction sewer infrastructure within the vicinity of the site:

- A DN150 uPVC gravity sewer main located within the development side verge of Hamilton Street flows west to the below mentioned maintenance hole; and
- A DN1050 maintenance hole located adjacent to the north-western corner of the site.

Refer to the detailed site survey in **Appendix B** and EDQ Approved Design Drawings in **Appendix D** for more details on the existing water infrastructures.

8.2 Proposed Infrastructure

The minimum sewer property connection size for this development is likely to be DN150. It is proposed to connect to the abovementioned DN1050 maintenance hole located adjacent to the north-western corner of the site to service the development. The details of the proposed sewer connection will be confirmed during detailed design.

Council has advised that the existing sewer infrastructure has insufficient capacity to support the proposed development. ADG understand that EDQ and RCC are currently upgrading this infrastructure to cater to the Weinam Creek PDA. Once this infrastructure is in place the network will have sufficient capacity to service this development.

A preliminary layout of the proposed sewer connection prepared by ADG can be found on drawing C60 in **Appendix C**. Detailed sewer connection drawings will be provided as part of future operational works application once the development has been approved.



9 STORMWATER DRAINAGE

9.1 Existing Infrastructure

The detailed site survey has identified the following stormwater infrastructure within the vicinity of the site:

- A gully pit in the Outridge Street kerb & channel immediately west of the site;
- A DN300 Fibre Reinforced Concrete Pipe (FRC) flows from the abovementioned gully pit to a maintenance hole on the non-development side of Outridge Street;
- A DN450 Reinforced Concrete Pipe (RCP) flows from the abovementioned maintenance hole, to the north-east along Outridge Street to the intersection with Banana Street.

EDQ Approved Design Drawings for ongoing Weinam Creek Priority Development Area Stage 3A has identified the following under construction stormwater infrastructure within the vicinity of the site:

- The stormwater infrastructure on Outridge Street opposite the site is proposed to be replaced with larger pipes and structures in adjusted locations; and
- A new lip-in-line stormwater gully pit on Hamilton Street, over a DN450 SRCP CL3 pipe flowing north under the road, joining the stormwater infrastructure draining from Outridge Street.

Refer to the detailed survey in **Appendix B** and the EDQ Approved Design Drawings in **Appendix D** for more details on the existing stormwater infrastructures.

9.2 Proposed Infrastructure

A stormwater connection will be provided from the proposed development to the existing gully pit on the development side of Hamilton Street.

Refer to the Stormwater Management Plan (26164 C SMP) prepared by ADG, which demonstrates the proposed stormwater management measures required to meet relevant guidelines.

The drainage proposed within the development will comply with the following documents:

- RCC Stormwater Drainage Guidelines;
- Queensland Urban Drainage Manual (QUDM 2017); and
- AS 3500.3 Plumbing and Drainage Stormwater Drainage.

9.3 Flood Consideration

A review of RCC Flood and Storm Tide Hazard Overlay Map has identified that the site is affected by the 2016 and 2100 Storm Tide Inundation Areas. Refer to the Stormwater Management Plan by ADG Engineers (Report ID: 26164 SMP) which discusses flooding considerations in more detail with regard to the proposed development.

Pothole survey of the verge is recommended to ensure that this proposed stormwater connection will not clash with existing services in the verge.



10 ELECTRICAL SUPPLY

The Energex map provided by DBYD and site investigation has identified that there are currently overhead electrical cables which run in close proximity to the site which include:

- Overhead electrical infrastructure and streetlights running along the non-development side of Banana Street, with a single street light supplied with power by an overhead line located on the development side of the verge near the north-east corner of the site;
- Overhead electrical infrastructure on the development side of Outridge Street; and
- The site appears to be serviced by the abovementioned overhead electrical infrastructure on Outridge Street.

The Electrical Consultant will determine the extent of the upgrading and connection works that will be required to facilitate the required electrical reticulation for the proposed development at the detailed design stage.

Refer to the DYBD Information in Appendix E for further details on the existing electrical reticulation.

11 COMMUNICATION

The following telecommunication services have been identified in the vicinity of the site using DBYD search:

- A 50mm diameter Poly Vinyl Chloride (PVC) conduit owned by Telstra containing one cable runs from a size 5 pit on the non-development side of Banana Street to a size 5 pit opposite the northeast corner of site on the development side of Banana Street;
- A 50mm diameter PVC conduit owned by Telstra containing one cable continues north along Banana Street from the abovementioned 5 pit;
- A 15mm Other Carrier (OC) telecommunication cable runs along the development side verge of Outridge Street; and
- The site is serviced by an aerial cable from Outridge Street.

It is proposed that the telecommunications consultant will negotiate with the relevant carriers regarding the requirements of the proposed development telecommunications connection and the extent of any upgrading and possible relocation works to the system if necessary.

12 GAS

A DBYD search has not identified any gas services in the vicinity of the site.



13 CONCLUSION

The site appears to be adequately serviced by public utilities, however it is noted that there are issues with the existing sewer and water infrastructure. It is understood that EDQ and RCC are currently working through the process to upgrade this infrastructure. Information discussed in this report is inferred from detailed site survey and DBYD records.


It is proposed to provide a new water connection the water main being constructed adjacent to the site boundary within the Hamilton Street verge as a part of Stage 3A of the Weinam Creek PDA works.

It is proposed to provide a new sewer connection the DN1050 sewer maintenance hole being constructed adjacent to the north-western corner of the site as a part of Stage 3A of the Weinam Creek PDA works.

A stormwater connection will be provided from the proposed development to the gully pit on the development side of Hamilton Street being constructed as a part of Stage 3A of the Weinam Creek PDA works. Refer to the Stormwater Management Plan (26164 C SMP) prepared by ADG, which demonstrates the proposed stormwater management measures required to meet relevant guidelines.



Appendix A Architectural Drawings by HAL Architects

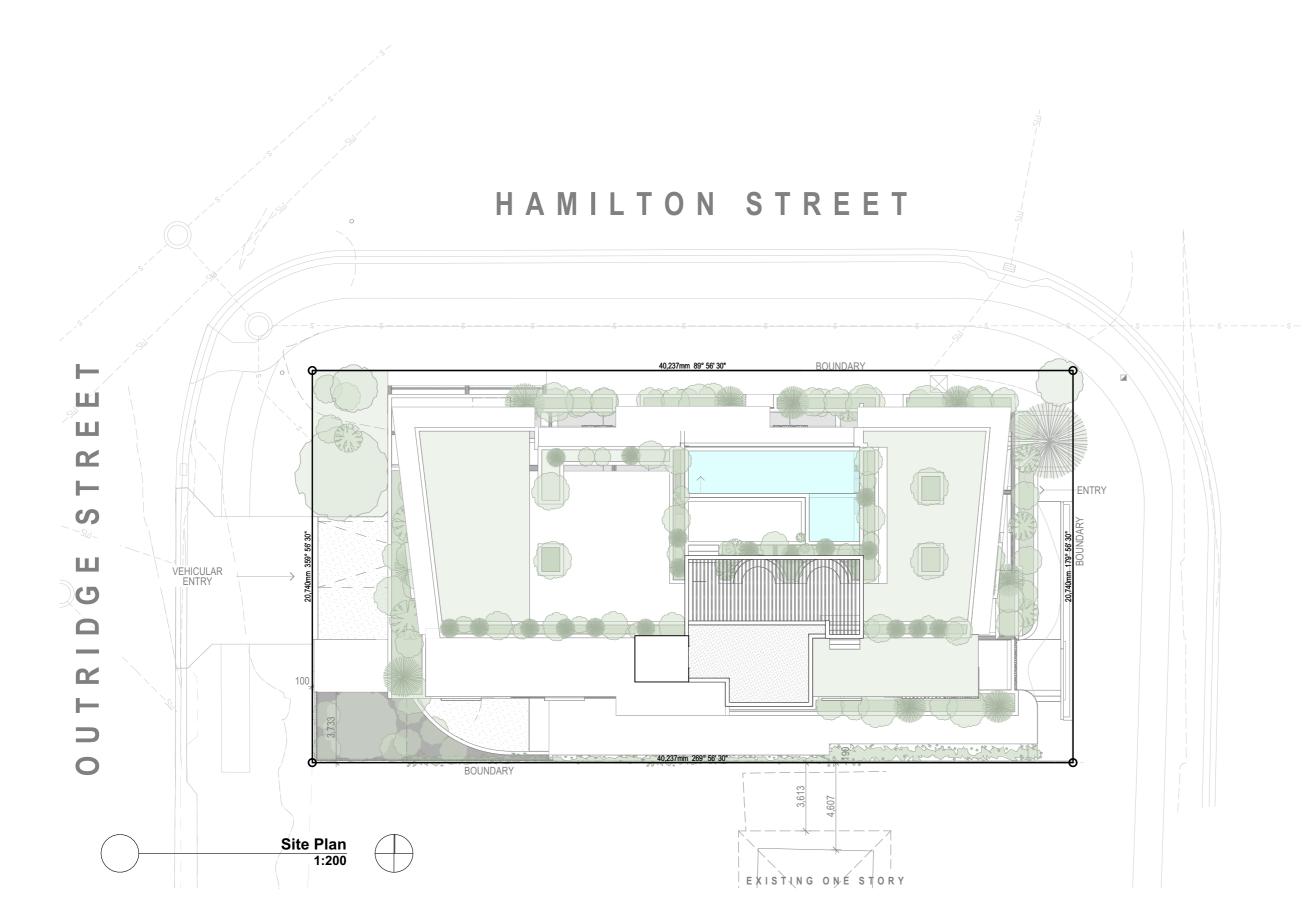

TOWN PLANNING DRAWINGS

General Notes

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Work to be carried out in a neat and appropriate manner.

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24/07/23	Р	SW Pit Added	RH
15/05/23	N	Revised Town Planning	ΕA
07/02/23	M	Roof Terrace Reconfiguration	ıΕΑ
01/02/23	L	Loft Removed	ΕA
22/12/22	K	Lvl 4-6 Kitchen Layout	ΕA
10/12/22	J	Revised Window Schedule	EΑ
10/12/22	1	TP Information Request	EΑ
30/11/22	Н	Window Schedule	EΑ
24/10/22	G	Futher Issues Response	EΑ
05/10/22	F	Futher Issues Response	EΑ
15/09/22	Ε	IR Response	ΕA
01/09/22	D	Prelim IR Response	EΑ
20/07/22	С	Updated Facade	EΑ
14/07/22	В	Detention tanks added	EΑ
09/06/22	Α	Lodgement Issue	EΑ
Date	Issue	Details Chec	ked
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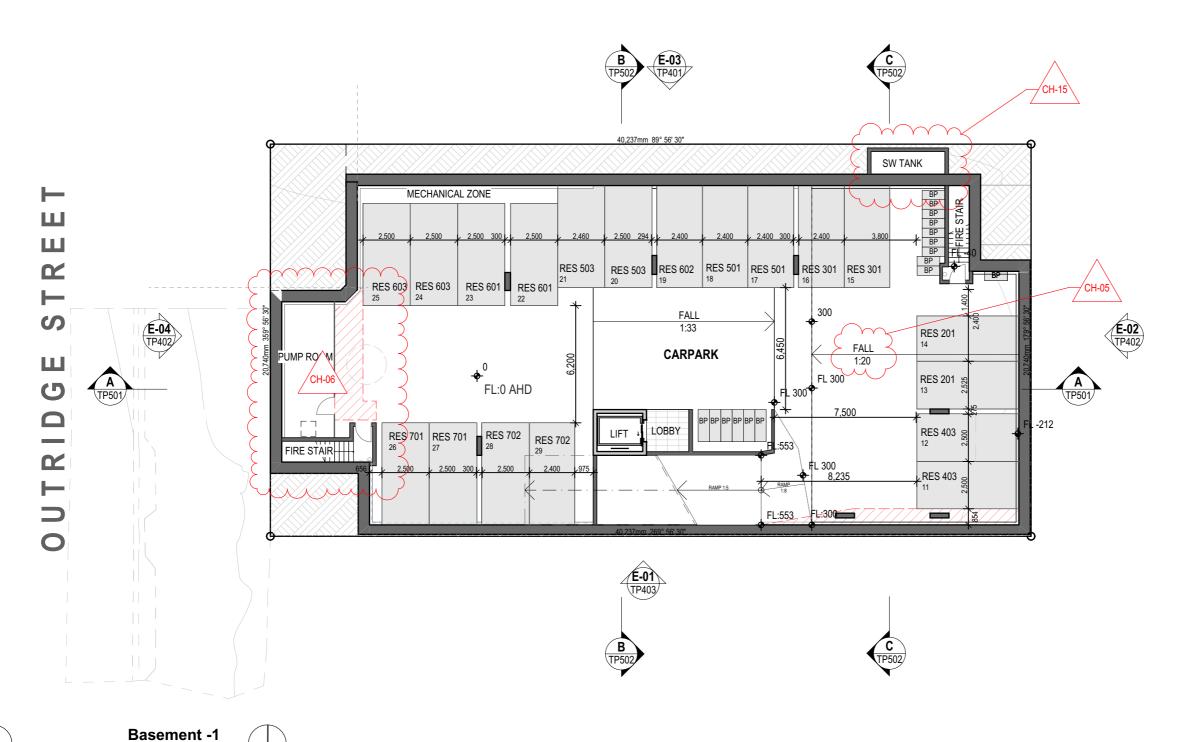
Apartment Development

57 Banana Street, Redland Bay, QLD 4165

Site Plan

Scale @ A3 Checked: 1:200 RH RH Project Number Drawing Number Issue H4474BAN TP104

HAMILTON STREET



ChID	Change Name
CH-05	Fall in Basement Added
CH-06	Pump Room and MSSB Moved
CH-15	SW Tank Added

1:200

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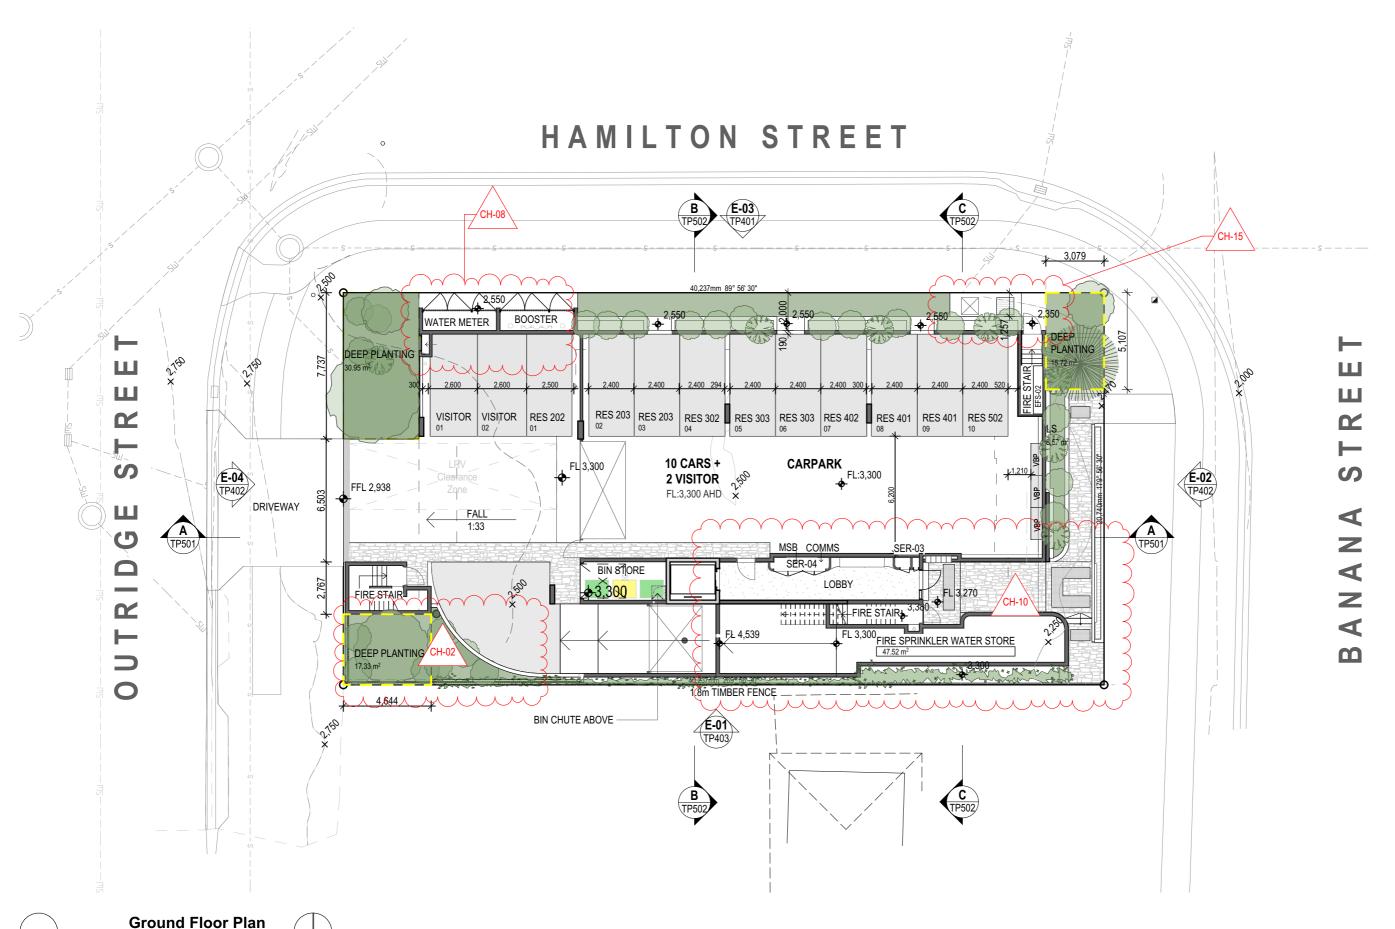


Apartment Development

57 Banana Street, Redland Bay, QLD 4165

Basement -1 Floor Plan

Scale @ A3	Drawn:	Checked
:200	RH	RH
Project Number	Drawing Number	Issue
14474BAN	TP201	Р



ChID	Change Name
CH-02	PMT area removed, added space for deep plenting
CH-08	Water Meter and Booster swapped and Mech Riser Added
CH-10	Services Reconfigured. Fire Sprinkler storage, MSB and Comms
CH-15	SW Tank Added

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Apartment Development

57 Banana Street, Redland Bay, QLD 4165

Ground Floor Plan

H4474BAN	TP202	Р
Project Number	Drawing Number	Issue
1:200	RH	RH
Scale @ A3	Drawn:	Checked:





ChID	Change Name

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07/02/23	M	Roof Terrace Reconfiguration	E
01/02/23	L	Loft Removed	E
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Apartment Development


57 Banana Street, Redland Bay, QLD 4165

Level 2 Floor Plan

Scale @ A3	Drawn:	Checke
1:200	RH	RH
Project Number	Drawing Number	Issue
H4474BAN	TP203	Р





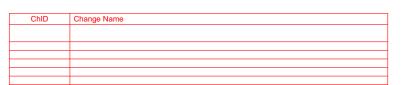

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04/07/00	_	OW D'S A LL L	_
24/07/23	-	SW Pit Added	RI
15/05/23	N	Revised Town Planning	E
07/02/23	M	Roof Terrace Reconfiguration	ıΕ
01/02/23	L	Loft Removed	E
22/12/22	K	Lvl 4-6 Kitchen Layout	E
10/12/22	J	Revised Window Schedule	E
10/12/22	1	TP Information Request	Ε
30/11/22	Н	Window Schedule	E
24/10/22	G	Futher Issues Response	Ε
05/10/22	F	Futher Issues Response	Ε
15/09/22	Ε	IR Response	E
01/09/22	D	Prelim IR Response	E
20/07/22	С	Updated Facade	E
14/07/22	В	Detention tanks added	E
09/06/22	Α	Lodgement Issue	E
Date	Issue	Details Chec	ke
		A	



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Apartment Development

57 Banana Street, Redland Bay, QLD 4165

Level 3 Floor Plan

H4474BAN	TP204	Issue P
Scale @ A3 1:200	Drawn:	Check RH







ChID	Change Name
_	

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		A	
Date	Issue	Details Chec	ke
09/06/22	Α	Lodgement Issue	E
14/07/22	В	Detention tanks added	E
20/07/22	С	Updated Facade	ΕÆ
01/09/22	D	Prelim IR Response	E
15/09/22	Е	IR Response	E
05/10/22	F	Futher Issues Response	ΕÆ
24/10/22	G	Futher Issues Response	ΕÆ
30/11/22	Н	Window Schedule	ΕÆ
10/12/22	1	TP Information Request	E
10/12/22	J	Revised Window Schedule	E
22/12/22	K	Lvl 4-6 Kitchen Layout	E
01/02/23	L	Loft Removed	E
07/02/23	М	Roof Terrace Reconfiguration	ıΕ
15/05/23		Revised Town Planning	E
24/07/23	-	SW Pit Added	RH



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Apartment Development

57 Banana Street, Redland Bay, QLD 4165

Level 4-6 Floor Plan

Scale @ A3	Drawn:	Checke
1:200	RH	RH
Project Number	Drawing Number	Issue
H4474BAN	TP205	Ρ







ChID	Change Name

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09/06/22 Date		Lodgement Issue Details Chec	E/
14/07/22		Detention tanks added	E
20/07/22	С	Updated Facade	ΕÆ
01/09/22	D	Prelim IR Response	E
15/09/22	Е	IR Response	ΕÆ
05/10/22	F	Futher Issues Response	E
24/10/22	G	Futher Issues Response	ΕÆ
30/11/22	Н	Window Schedule	E
10/12/22	-	TP Information Request	E/
10/12/22		Revised Window Schedule	E/
22/12/22	K	Lvl 4-6 Kitchen Layout	ΕÆ
01/02/23	L	Loft Removed	ΕÆ
07/02/23	M	Roof Terrace Reconfiguration	EΑ
15/05/23	N	Revised Town Planning	E
24/07/23	Р	SW Pit Added	Rŀ



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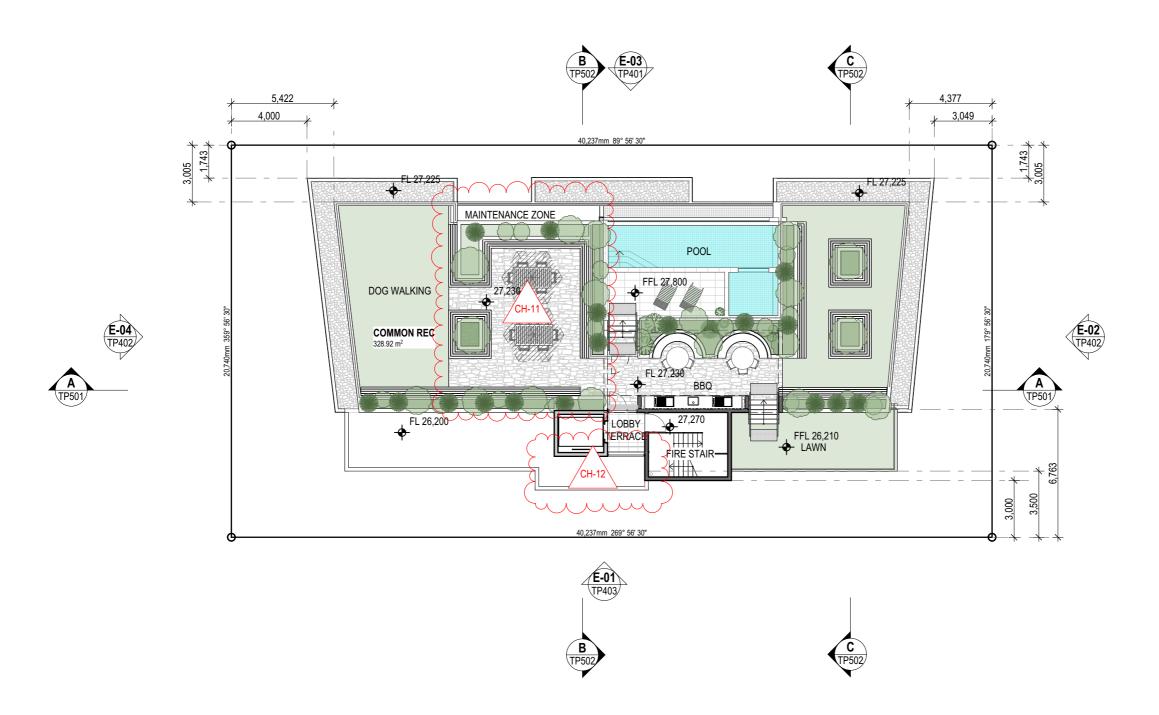


Apartment Development

57 Banana Street, Redland Bay, QLD 4165

Level 7 Floor Plan

Scale @ A3	Drawn:	Checke
1:200	RH	RH
Project Number	Drawing Number	Issue
H4474BAN	TP206	Р



Roof Terrace Floor Plan

ChID (Change Name
CH-11 F	Roof Communal Area reconfigured
CH-12	Screen Removed

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			A	
Date		Issue	Details Check	ked
09/06	6/22	Α	Lodgement Issue	EΑ
14/07	7/22	В	Detention tanks added	EΑ
20/07	7/22	С	Updated Facade	EΑ
01/09	9/22	D	Prelim IR Response	ΕA
15/09	9/22	Е	IR Response	ΕA
05/10)/22	F	Futher Issues Response	EΑ
24/10)/22	G	Futher Issues Response	EΑ
30/11	1/22	Н	Window Schedule	EΑ
10/12	2/22	1	TP Information Request	EΑ
10/12	2/22	J	Revised Window Schedule	EΑ
22/12	2/22	K	Lvl 4-6 Kitchen Layout	ΕA
01/02	2/23	L	Loft Removed	EΑ
07/02	2/23	M	Roof Terrace Reconfiguration	EΑ
15/05			Revised Town Planning	EΑ
24/07		-	SW Pit Added	RH



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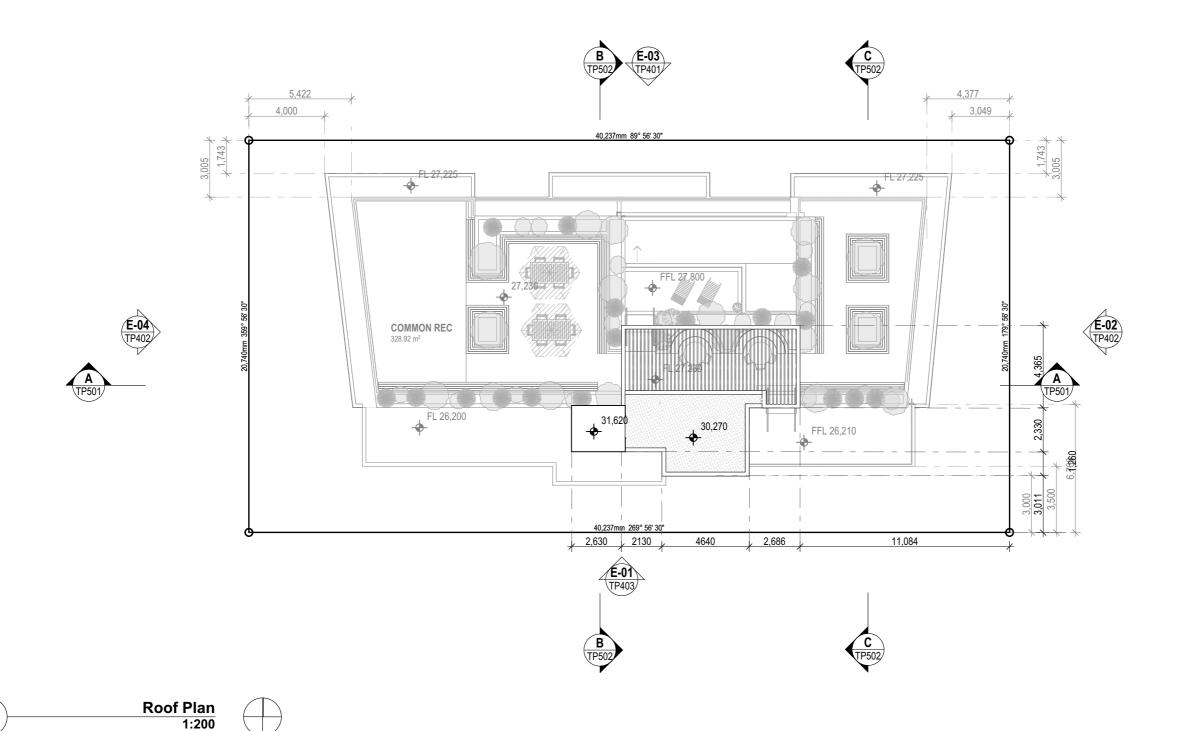


Apartment Development

57 Banana Street, Redland Bay, QLD 4165

Roof Terrace Plan

Project Number H4474BAN	Drawing Number TP207	Issue P
Scale @ A3	Drawn:	Checke
1:200	RH	RH



Change Name

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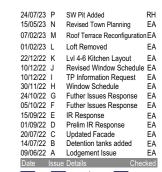
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Apartment Development

57 Banana Street, Redland Bay, QLD 4165

Roof Plan

Scale @ A3	Drawn:	Checke
1:200	RH	RH
Project Number	Drawing Number	Issue
H4474BAN	TP208	Р



CH-11

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24/07/23	Р	SW Pit Added	RH
15/05/23	N	Revised Town Planning	ΕA
07/02/23	M	Roof Terrace Reconfiguration	١EA
01/02/23	L	Loft Removed	ΕA
22/12/22	K	Lvl 4-6 Kitchen Layout	EΑ
10/12/22	J	Revised Window Schedule	ΕA
10/12/22	1	TP Information Request	EΑ
30/11/22	Н	Window Schedule	EΑ
24/10/22	G	Futher Issues Response	ΕA
05/10/22	F	Futher Issues Response	EΑ
15/09/22	Е	IR Response	EΑ
01/09/22	D	Prelim IR Response	EΑ
20/07/22	С	Updated Facade	EΑ
14/07/22	В	Detention tanks added	ΕA
09/06/22	Α	Lodgement Issue	ΕA
Date	Issue	Details Chec	ked
_			



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Apartment Development 57 Banana Street, Redland Bay,

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North Eleva		
Scale @ A3 1:200	Drawn:	Checke
Project Number	Drawing Number	Issue
H4474BAN	TP401	Р



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24/07/23	Р	SW Pit Added	RH
15/05/23	N	Revised Town Planning	EΑ
07/02/23	M	Roof Terrace Reconfiguration	EΑ
01/02/23	L	Loft Removed	ΕA
22/12/22	K	Lvl 4-6 Kitchen Layout	ΕA
10/12/22	J	Revised Window Schedule	EΑ
10/12/22	1	TP Information Request	EΑ
30/11/22	Н	Window Schedule	EΑ
24/10/22	G	Futher Issues Response	EΑ
05/10/22	F	Futher Issues Response	EΑ
15/09/22	Е	IR Response	EΑ
01/09/22	D	Prelim IR Response	ΕA
20/07/22	С	Updated Facade	ΕA
14/07/22	В	Detention tanks added	ΕA
09/06/22	Α	Lodgement Issue	EΑ
Date	Issue	Details Chec	ked



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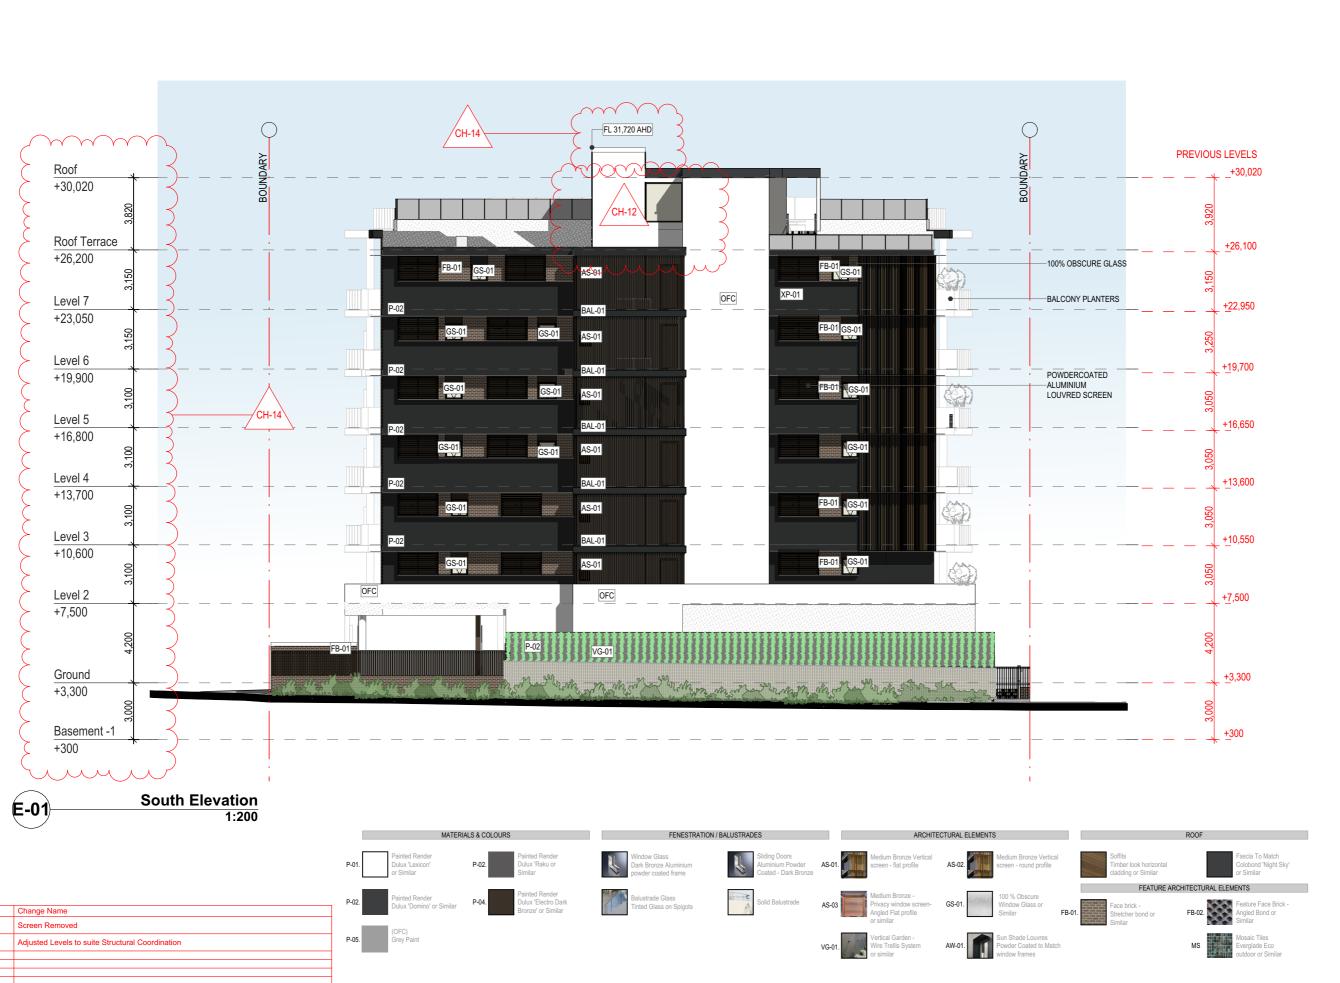


Apartment Development 57 Banana Street, Redland Bay,

QLD 4165

East & West Elevation

H4474BAN	TP402	Р
Project Number	Drawing Number	Issue
1:200	RH	RH
Scale @ A3	Drawn:	Checked



CH-12

TOWN PLANNING DRAWINGS

LEGEND

ALLUMINIUM PRIVACY SCREEN ALLUMINIUM AWNING TINTED GLASS BALUSTRADE

FEATURE STONE

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Date	Issue	Details Chec	ked
09/06/2		Lodgement Issue	ΕA
14/07/2		Detention tanks added	EΑ
20/07/2	2 C	Updated Facade	EΑ
01/09/2	2 D	Prelim IR Response	EΑ
15/09/2	2 E	IR Response	EΑ
05/10/2	2 F	Futher Issues Response	EΑ
24/10/2	2 G	Futher Issues Response	EΑ
30/11/2	2 H	Window Schedule	EΑ
10/12/2	2	TP Information Request	EΑ
10/12/2	2 J	Revised Window Schedule	EΑ
22/12/2	2 K	Lvl 4-6 Kitchen Layout	EΑ
01/02/2	3 L	Loft Removed	EΑ
07/02/2	3 M	Roof Terrace Reconfiguration	ıΕΑ
15/05/2	3 N	Revised Town Planning	EΑ
24/07/2		SW Pit Added	RH



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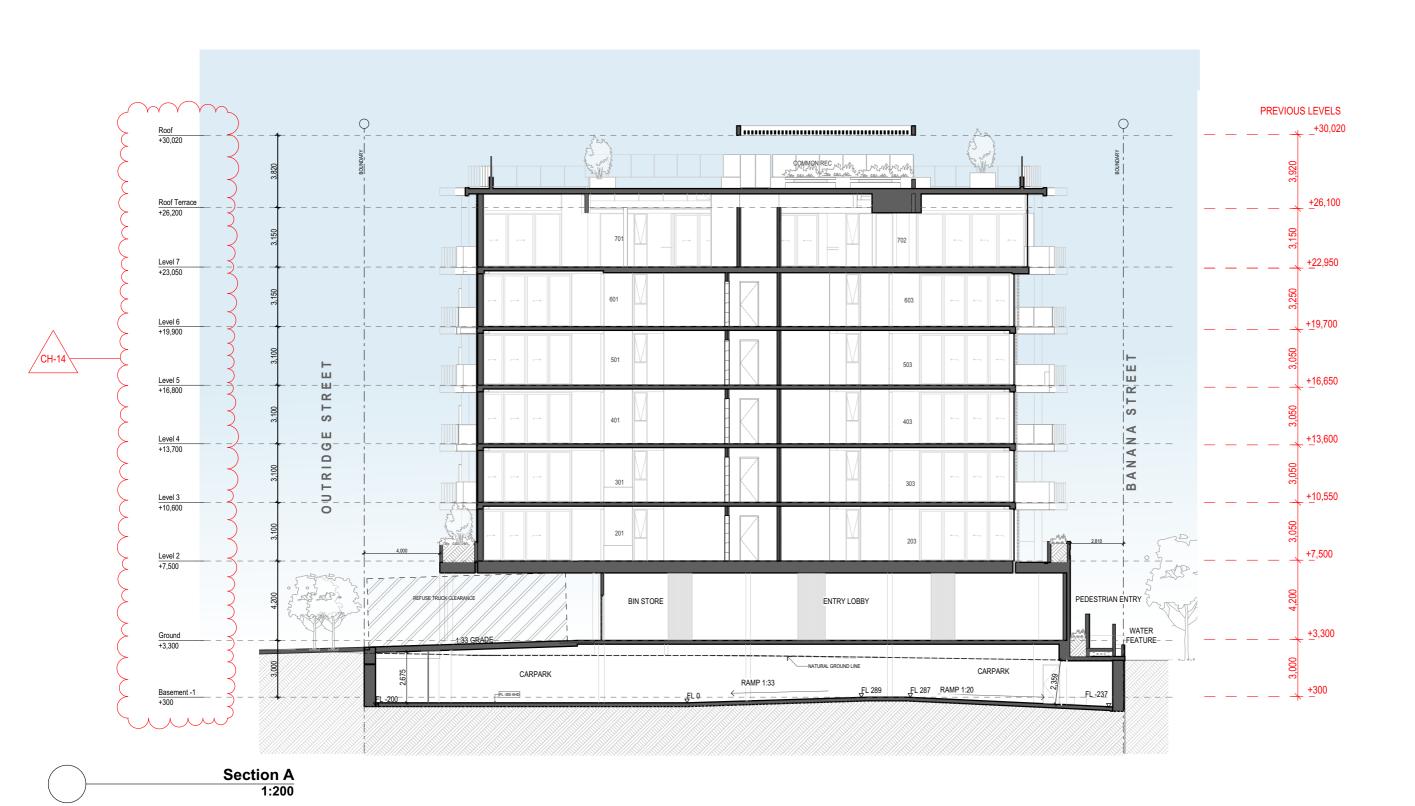


QLD 4165

Apartment Development 57 Banana Street, Redland Bay,

South Elevation

H4474BAN	TP403	Р
Project Number	Drawing Number	Issue
1:200	RH	RH
Scale @ A3	Drawn:	Check



ChID	Change Name
CH-14	Adjusted Levels to suite Structural Coordination

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24/07/23	Р	SW Pit Added	RH
15/05/23	N	Revised Town Planning	EΑ
07/02/23	M	Roof Terrace Reconfiguration	iΕΑ
01/02/23	L	Loft Removed	EΑ
22/12/22	K	Lvl 4-6 Kitchen Layout	EΑ
10/12/22	J	Revised Window Schedule	EΑ
10/12/22	1	TP Information Request	EΑ
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24/10/22	G	Futher Issues Response	EΑ
05/10/22	F	Futher Issues Response	EΑ
15/09/22	E	IR Response	EΑ
01/09/22	D	Prelim IR Response	EΑ
20/07/22	С	Updated Facade	EΑ
14/07/22	В	Detention tanks added	EΑ
09/06/22	Α	Lodgement Issue	EΑ
Date	Issue	Details Chec	ked



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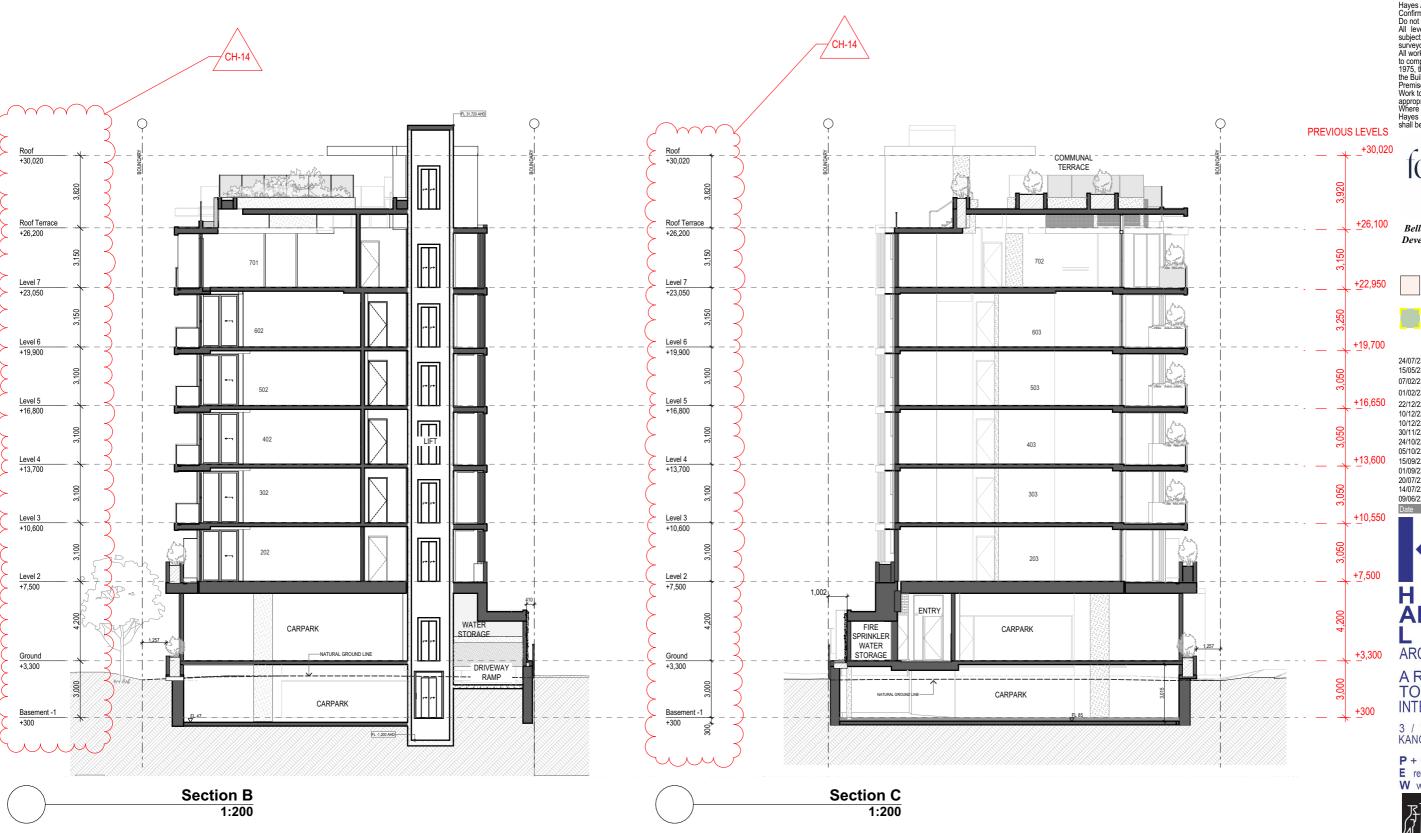


Apartment Development

57 Banana Street, Redland Bay, QLD 4165

Sections

Scale @ A3	Drawn:	Checke
1:200	RH	RH
Project Number	Drawing Number	Issue
H4474BAN	TP501	Р



CH-14 Adjusted Levels to suite Structural Coordination

NOTE:

Boundary, contours, levels, and site services information is shown indicatively only, based on eBimap. It is subject to confirmation by a licensed Surveyor in the form of an Identification Survey

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24/07/23	Ρ	SW Pit Added	RH
15/05/23	N	Revised Town Planning	EΑ
07/02/23	M	Roof Terrace Reconfiguration	iΕΑ
01/02/23	L	Loft Removed	EΑ
22/12/22	K	Lvl 4-6 Kitchen Layout	EΑ
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15/09/22	Е	IR Response	EΑ
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20/07/22	С	Updated Facade	EΑ
14/07/22	В	Detention tanks added	EΑ
09/06/22	Α	Lodgement Issue	EΑ
Date	Issue	Details Chec	ked



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Apartment Development


57 Banana Street, Redland Bay, QLD 4165

Sections

H4474BAN	TP502	Р
Project Number	Drawing Number	Issue
1:200	RH	RH
Scale @ A3	Drawn:	Checked



Appendix B Detailed Site Surveys

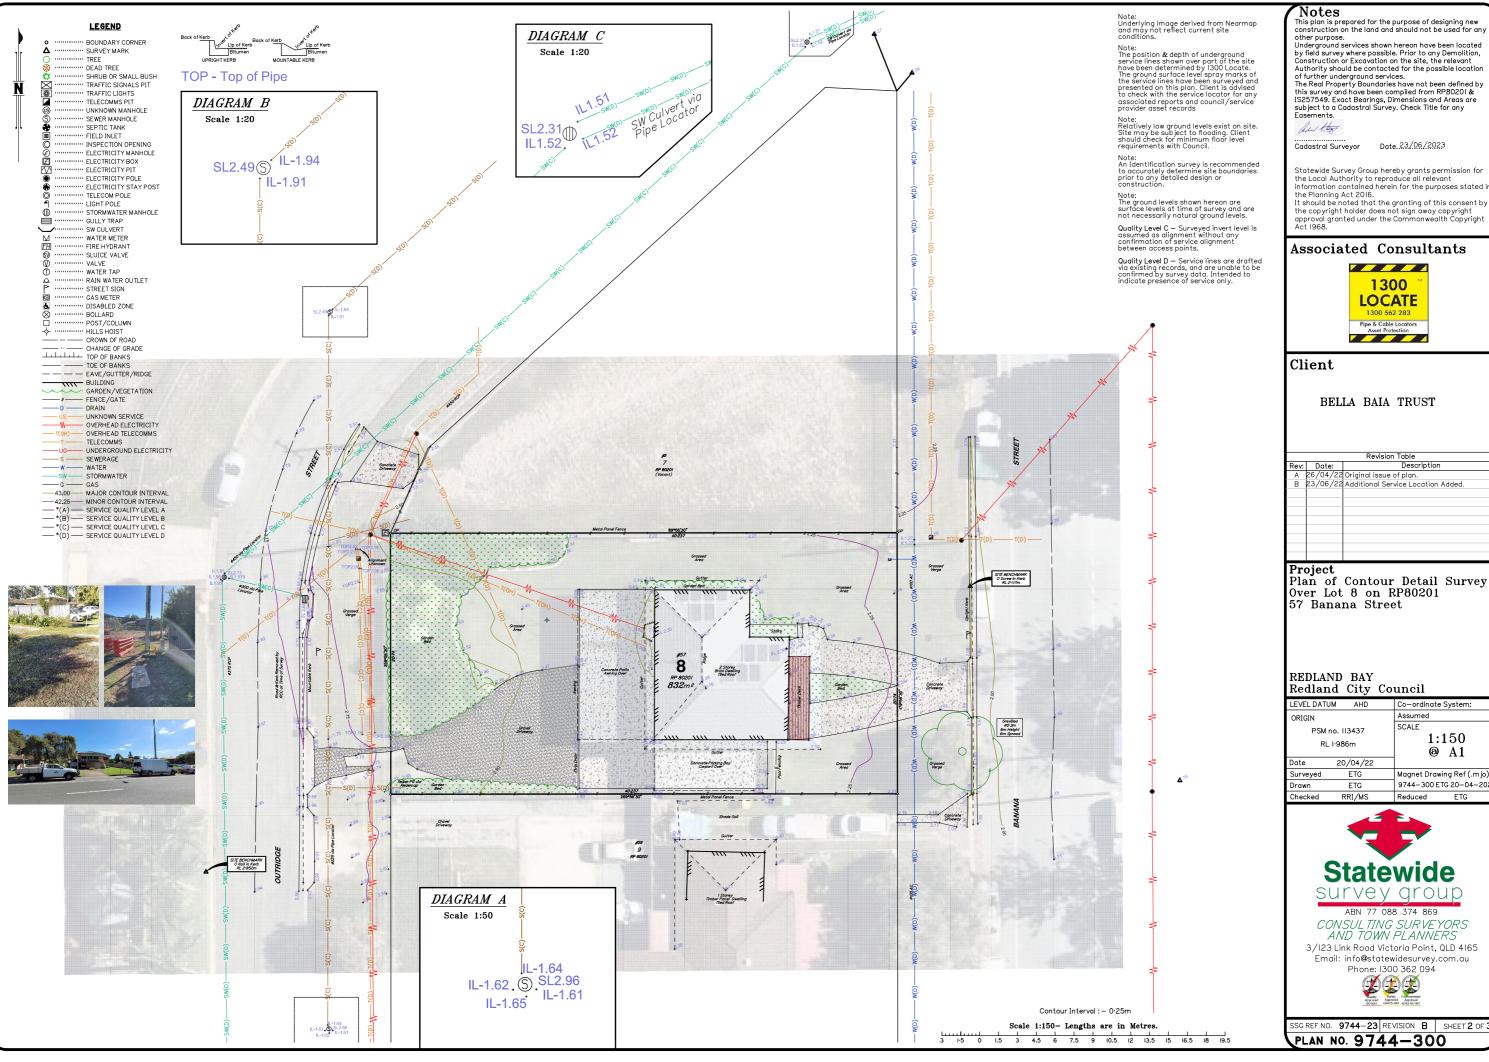

other purpose.
Underground services shown hereon have been located by field survey where possible. Prior to any Demolition, Construction or Excavation on the site, the relevant Authority should be contacted for the possible location

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Revision Table				
Rev:	Date:	Description		
Α	26/04/22	Original issue of plan.		
В	23/06/22	Additional Service Location Added.		

Project Plan of Contour Detail Survey Over Lot 8 on RP80201

Redland City Council

ORIGIN		Assumed	
	no. 113437 I·986m	1:150	
Date	20/04/22		
Surveyed	ETG	Magnet Drawing Ref (.mjo):	
Drawn	ETG	9744-300 ETG 20-04-2022	
A	DDI (440	D 1 1 5TO	




ABN 77 088 374 869 CONSULTING SURVEYORS AND TOWN PLANNERS

3/I23 Link Road Victoria Point, QLD 4I65 Email: info@statewidesurvey.com.au Phone: I300 362 094




SSG REF NO. 9744-23 REVISION B SHEET 2 OF 3

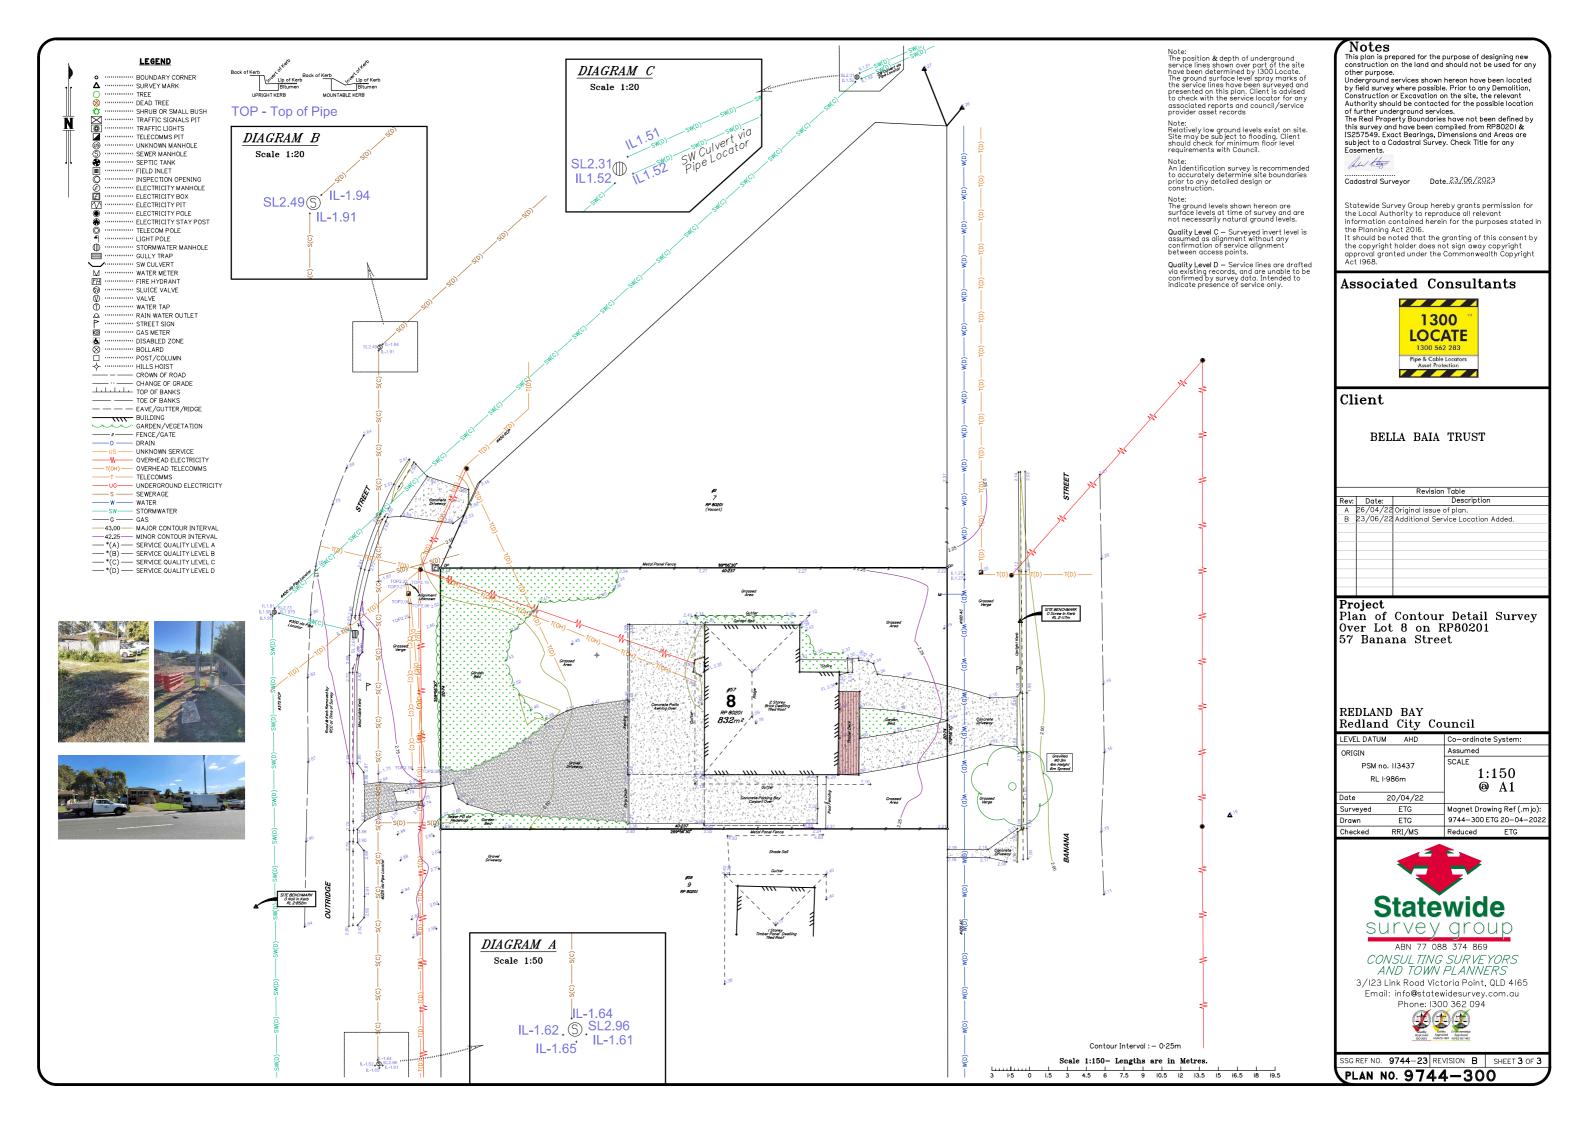



Appendix C ADG Preliminary Civil Drawings

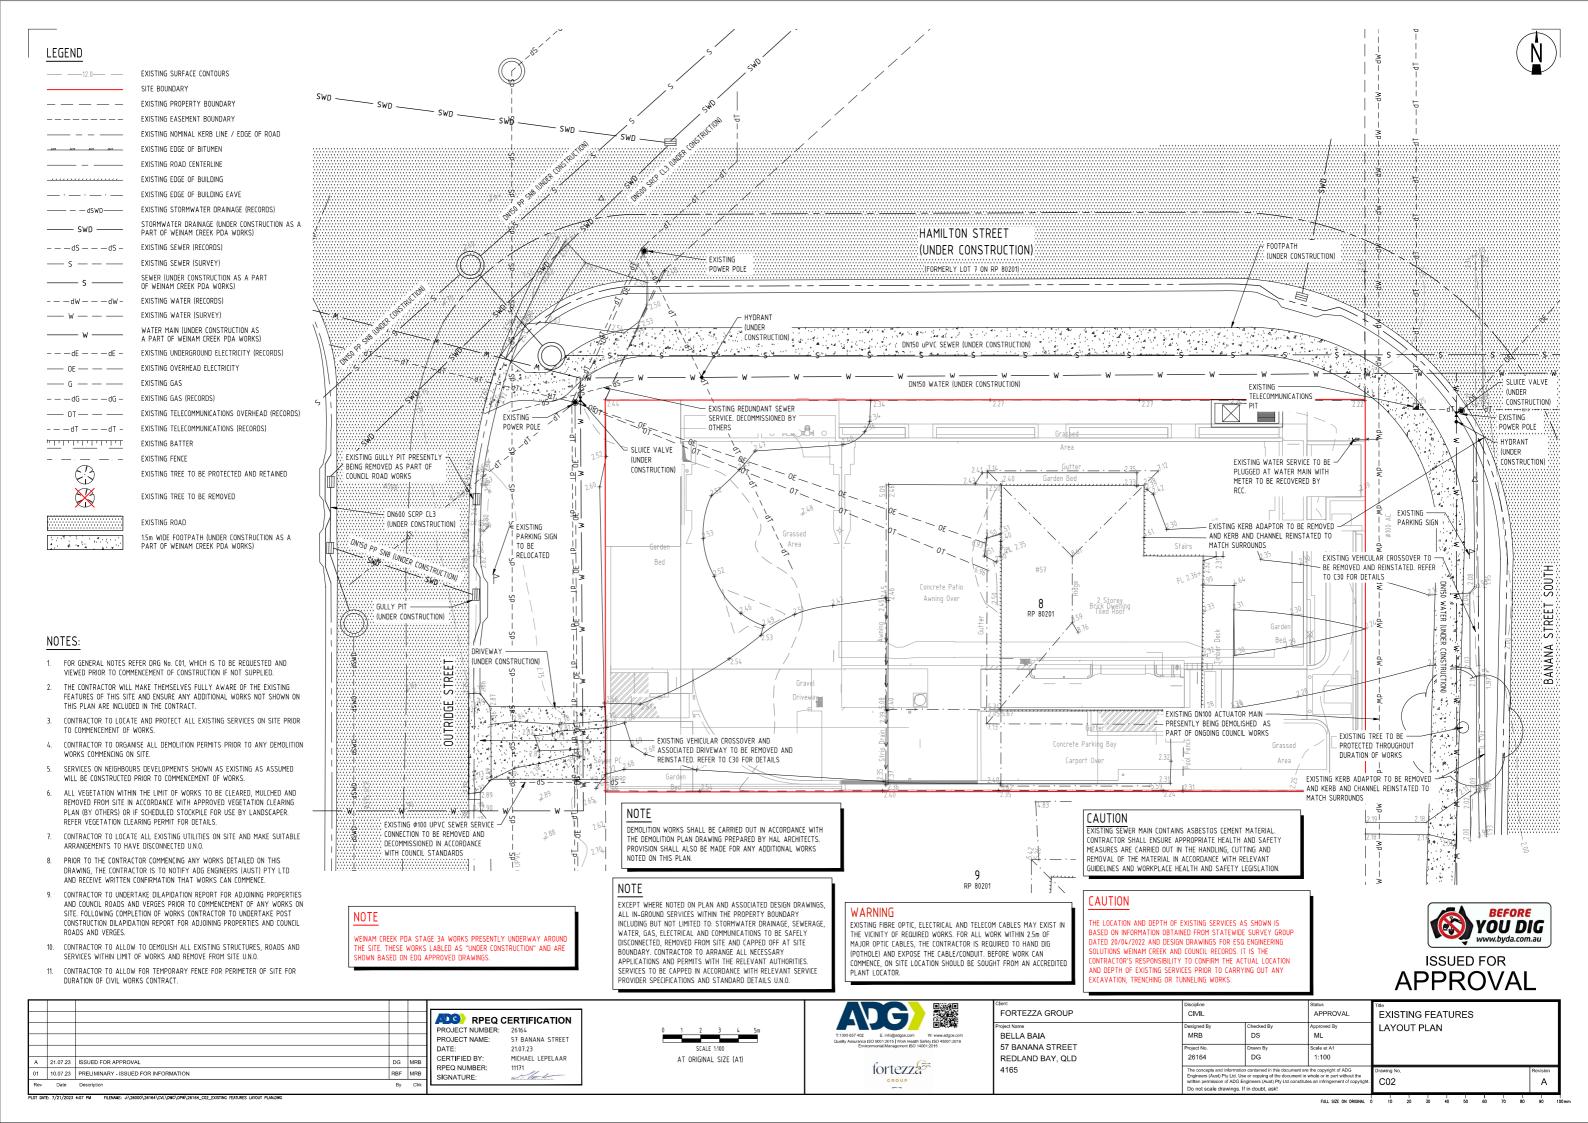

LEGEND

SITE BOUNDARY EXISTING PROPERTY BOUNDARY EXISTING EASEMENT BOUNDARY EXISTING SURFACE CONTOURS EARTHWORKS CONTOURS EXISTING SURFACE LEVEL **≭** 3.42 FINISHED SURFACE LEVEL **≭** 3.42 RETW HT 6.40m RETAINING WALL HEIGHT EXISTING NOMINAL KERB LINE EXISTING EDGE OF BITUMEN LINE EXISTING ROAD CENTERLINE EXISTING EDGE OF BUILDING EXISTING EDGE OF BUILDING EAVE PROPOSED NOMINAL KERB LINE EXISTING STORMWATER DRAINAGE (RECORDS) STORMWATER DRAINAGE (UNDER CONSTRUCTION AS A PART OF WEINAM CREEK PDA WORKS) EXISTING SEWER (RECORDS) EXISTING SEWER (SURVEY) SEWER (UNDER CONSTRUCTION AS A PART OF WEINAM CREEK PDA WORKS) EXISTING WATER (RECORDS) --dW---dWWATER MAIN (UNDER CONSTRUCTION AS A PART OF WEINAM CREEK PDA WORKS) EXISTING UNDERGROUND ELECTRICITY (RECORDS) EXISTING OVERHEAD ELECTRICITY EXISTING GAS (RECORDS) - - - dG - - - dG -EXISTING TELECOMMUNICATIONS OVERHEAD (RECORDS) EXISTING TELECOMMUNICATIONS (RECORDS) <u> 111111111111</u> EXISTING BATTER EXISTING FENCE PROPOSED BATTER PROPOSED EARTHWORKS CUT PROPOSED EARTHWORKS FILL

FOR SITE SECTIONS REFER DRG No. C21

BASEMENT EXCAVATION

CUT TO SPOIL: NO STOCKPILE OF SOILS IS ALLOWED FOR. ALL EXCAVATION IS TO BE TAKEN OFF SITE AND DISPOSED IMMEDIATELY U.N.O.

NOTE

WEINAM CREEK PDA STAGE 3A WORKS PRESENTLY UNDERWAY AROUNT THE SITE. THESE WORKS LABLED AS "UNDER CONSTRUCTION" AND ARE HOWN BASED ON EDQ APPROVED DRAWINGS

PROPOSED SHORING SYSTEM REFER

EARTHWORKS NOTES

FOR GENERAL NOTES REFER DRG No. CO1, WHICH IS TO BE REQUESTED AND VIEWED PRIOR TO COMMENCEMENT OF CONSTRUCTION IF NOT SUPPLIED.

出

- GRASS AND TOPSOIL SHALL BE STRIPPED TO A MINIMUM DEPTH OF 100MM OVER THE EXTENT OF THE WORKS UNLESS DIRECTED OTHERWISE AND REMOVE FROM SITE.
- CONTRACTOR TO ALLOW FOR ALL COSTS ASSOCIATED WITH ROCK EXCAVATION WITHIN CONTRACT RATES COMPACT THE EXPOSED SUBGRADE OR LOOSE TOP LEVEL MATERIAL TO A MINIMUM 98%

STREET

OUTRIDGE

- STANDARD MAXIMUM DRY DENSITY TO AS1289 5.11. ANY "SOFT SPOTS" IDENTIFIED BY THE PROOF ROLLING SHALL BE REMOVED AND REPLACED WITH A COMPACTED IMPORTED GENERAL FILL MATERIAL TO THE ABOVE COMPACTION REQUIREMENTS. IMPORTED GENERAL FILL MATERIAL SHALL BE SUPPLIED AND COMPACTED WHERE NECESSARY TO OBTAIN SUBGRADE/PLATFORM LEVEL. IMPORTED GENERAL FILL MATERIAL SHALL BE CLEAN
- GRADED MATERIAL FREE OF ORGANIC MATTER AND STONES GREATER THAN 150mm AND CAPABLE OF BEING COMPACTED INTO COHERENT FILLING TO THE SPECIFIED STANDARD. THE MATERIAL SHALL HAVE A LINEAR SHRINKAGE NOT GREATER THAN 1.5% AND A MINIMUM C.B.R. OF 10%.
- ANY PROPOSED RETAINING WALL WORKS MUST BE WHOLLY WITHIN THE PROPERTY BOUNDARY OF THE SUBJECT SITE, INCLUDING REAR OF RETAINING WALL DRAINAGE INFRASTRUCTURE FOR RETAINING WALLS IN CUT.
- REFER ARCHITECT/LANDSCAPE ARCHITECT DRAWINGS FOR CONFIRMATION OF RETAINING WALL COLOUR AND FINISH.
- ALL RETAINING WALL STRUCTURAL DESIGN AND CONSTRUCTION CERTIFICATION BY MANUFACTURER / INSTALLER.
- ALL EARTHWORKS OPERATIONS SHALL BE CARRIED OUT WITH 'LEVEL 1' SOIL ENGINEERING SUPERVISION IN ACCORDANCE WITH APPENDIX B OF AS 3798. THE NOMINATED GEOTECHNICAL TESTING AUTHORITY SHALL PROVIDE CERTIFICATION THAT ALL GENERAL EARTHWORKS OPERATIONS HAVE BEEN CARRIED OUT IN ACCORDANCE WITH THE DRAWINGS AND SPECIFICATIONS AND THE CONTROLLED FILL IS SUITABLE FOR PURPOSE WITH A MINIMUM 150KPA BEARING CAPACITY UNDER THE PLATFORM/STRUCTURES.
- 10. ALL EARTHWORKS FILL AND EXCAVATED AREAS SHALL BE COMPACTED TO 98% STANDARD MAXIMUM DRY DENSITY (AS 1289 5.1.1) IN LAYERS NOT EXCEEDING 150MM COMPACTED
- THE NOMINATED GEOTECHNICAL TESTING AUTHORITY SHALL PROVIDE CERTIFICATION THAT ALL GENERAL EARTHWORKS OPERATIONS HAVE BEEN CARRIED OUT IN ACCORDANCE WITH THE
- CONTRACTOR TO UNDERTAKE ALL EARTHWORKS TESTING TO COMPLY WITH THE PROJECT SPECIFICATION AND LOCAL AUTHORITY REQUIREMENTS.

- 13. FINISHED SURFACES TO ALL DISTURBED AREAS ARE TO BE TREATED IN ACCORDANCE WITH
- 15. ALL NEW WORKS TO MATCH NEATLY INTO EXISTING

36

Driveway

VY X

- 16 ALL WORKS TO BE CONSTRUCTED IN ACCORDANCE WITH APPROVED MANAGEMENT PLANS
- 17 CONTRACTOR TO ENSURE SUITABLE FROSION CONTROL MEASURES ARE INSTALLED INCLUDING
- 18. ADEQUATE SAFETY FENCING/BARRIERS TO BE APPLIED TO ALL BATTERS OR RETAINING WALLS
- TRACKS AND STOCKPILES AT A SUFFICIENT LEVEL TO SUPPRESS DUST GENERATION ADDITIONALLY CONTRACTORS ARE TO COVER OR ENCLOSE STOCKPILES WHERE REASONABLY
- CONTRACTOR IS TO NOTIFY ADG ENGINEERS (AUST) PTY LTD AND RECEIVE WRITTEN CONFIRMATION THAT WORKS CAN COMMENCE
- GEOTECHNICAL ENGINEER. CONTRACTOR TO ALLOW FOR ALL KEYING/STEPPING AS REQUIRED.
- 22. ALL TEMPORARY AND FINAL BATTER SLOPES ARE TO BE INSPECTED AND APPROVED BY FECHNICAL ENGINEER. CERTIFICATION OF LONG TERM STABILITY TO BE PROVIDED BY GEOTECHNICAL ENGINEER PRIOR TO PRACTICAL COMPLETION
- CONSTRUCTED EARTHWORKS BATTERS AND RETAINING STRUCTURES ACHIEVE ADEQUATE STABILITY, WITH APPROPRIATE FACTOR OF SAFETY COMPLYING WITH RELEVANT STANDARDS AND COUNCIL REQUIREMENTS.
- CARPARK LEVELS ETC. REFER STRUCTURAL ENGINEERING DRAWINGS FOR BUILDING SLAB REQUIRED BULK EARTHWORKS SURFACE.
- PACIFIC GEOTECH DATED OCTOBER 2022. IT IS RECOMMENDED THAT THE GEOTECHNICAL CONSULTANT BE CONTACTED TO CONFIRM THE SOIL CONDITIONS PRIOR TO EARTHWORKS
- 26. ACID SULPHATE SOILS TO BE TREATED IN ACCORDANCE WITH REQUIREMENTS IDENTIFIED IN THE

LANDSCAPE DRAWINGS. 14. ALL EARTHWORKS TO BE CARRIED OUT AT +/- 2% OPTIMUM MOISTURE CONTENT.

BUT NOT LIMITED TO SHAKE DOWNS, SILT FENCE ETC.

(TEMPORARY OR PERMANENT) AS PER RELEVANT AUSTRALIAN STANDARDS AND LEGISLATION 19. DUST CONTROL MEASURES ARE TO INCLUDE SPRAYING WATER ON UNPAVED ROADS, ACCESS

- PRACTICAL TO RESTRICT DUST MOVEMENT. 20. PRIOR TO THE CONTRACTOR COMMENCING ANY WORKS DETAILED ON THIS DRAWING, THE
- 21. ALL BATTERS TO BE KEYED/STEPPED INTO EXISTING MATERIAL AS DIRECTED BY
- 23. CONTRACTOR SHALL ENGAGE A SUITABLY QUALIFIED GEOTECHNICAL ENGINEER TO CONFIRM
- 24. EARTHWORKS LEVELS SHOWN ARE FINISHED SURFACE LEVELS INCLUSIVE OF TOPSOIL LAYER, THICKNESSES AND HYDRAULIC DRAWINGS FOR SUB-FLOOR DRAINAGE FOR DETERMINATION OF
- 25. FOR DETAILED GEOTECHNICAL INFORMATION, REFER GEOTECHNICAL INVESTIGATION REPORT BY
- ACID SULPHATE MANAGEMENT PLAN IF REQUIRED.
- 27. REFER ARCHITECTURAL DRAWINGS FOR BUILDING SETOUT

AS INDICATED ON PLANS REFER TO STRUCTURAL DRAWINGS -FOR SLAB THICKNESS (EARTHWORKS LEVEL)


N. W.

TYPICAL STRUCTURAL SLAB SETOUT

FINISHED SURFACE LEVEL

SOUTH


BANANA STREET

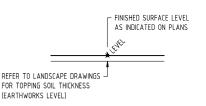

TYPICAL LANDSCAPE EARTHWORKS SETOUT SCALE 1:50


ISSUED FOR APPROVAL

FORTEZZA GROUP CIVII APPROVAL **EARTHWORKS** RPEQ CERTIFICATION LAYOUT PLAN PROJECT NUMBER BELLA BAIA MRB DS MI PROJECT NAME: 57 BANANA STREET 57 BANANA STREET 21.07.23 DG CERTIFIED BY: MICHAEL LEPELAAR AT ORIGINAL SIZE (A1) REDLAND BAY, QLD 26164 1:100 21.07.23 ISSUED FOR APPROVAL RPEQ NUMBER: 11171 fortezza 4165 10.07.23 PRELIMINARY - ISSUED FOR INFORMATION RBF MRB SIGNATURE: C20

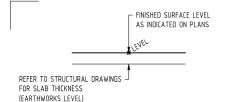


TYPICAL STRUCTURAL SLAB SETOUT

SCALE 1-50

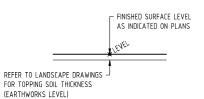


TYPICAL LANDSCAPE EARTHWORKS SETOUT

SCALE 1:50

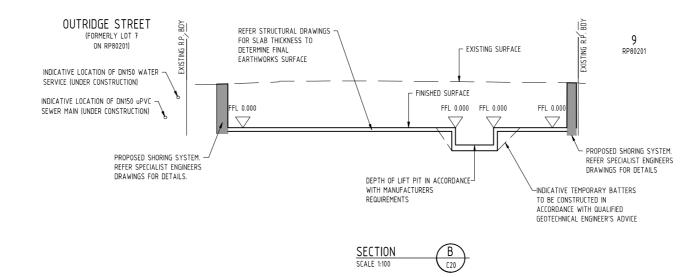

NOT


REFER ARCHITECTS DRAWINGS FOR FINAL BASEMENT LEVELS AND GRADING.

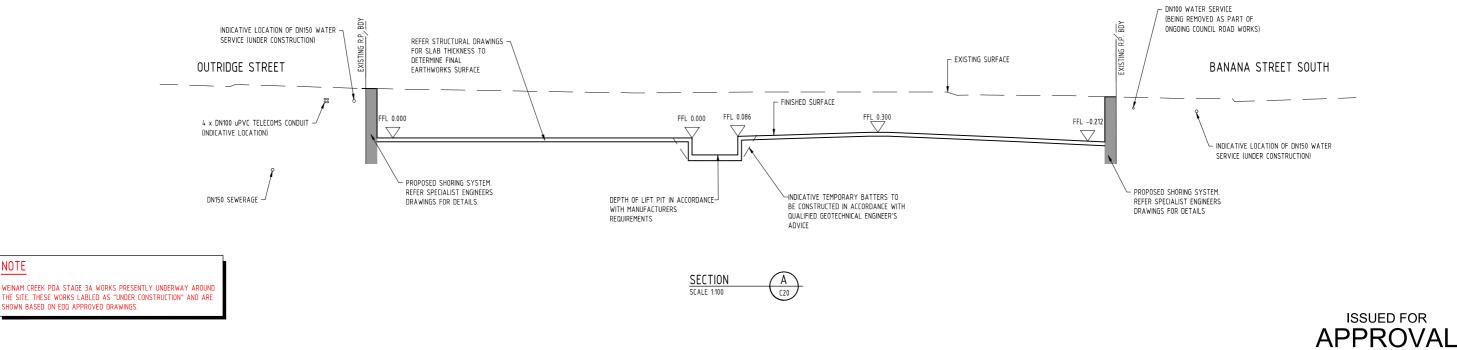



FORTEZZA GROUP CIVIL APPROVAL EARTHWORKS RPEQ CERTIFICATION PROJECT NUMBER: 26164 SITE SECTIONS MRB DS М BELLA BAIA PROJECT NAME: 57 BANANA STREET 57 BANANA STREET 21.07.23 Drawn B 1:100 MICHAEL LEPELAAR AT ORIGINAL SIZE (A1) 26164 CERTIFIED BY: REDLAND BAY, QLD A 21.07.23 ISSUED FOR APPROVAL RPEQ NUMBER: 11171 fortezza 4165 01 10.07.23 PRELIMINARY - ISSUED FOR INFORMATION RBF MRB SIGNATURE: C21


FULL SIZE ON ORIGINAL 0

N ORIGINAL D 10 20 30 40 50 60 70 80 90

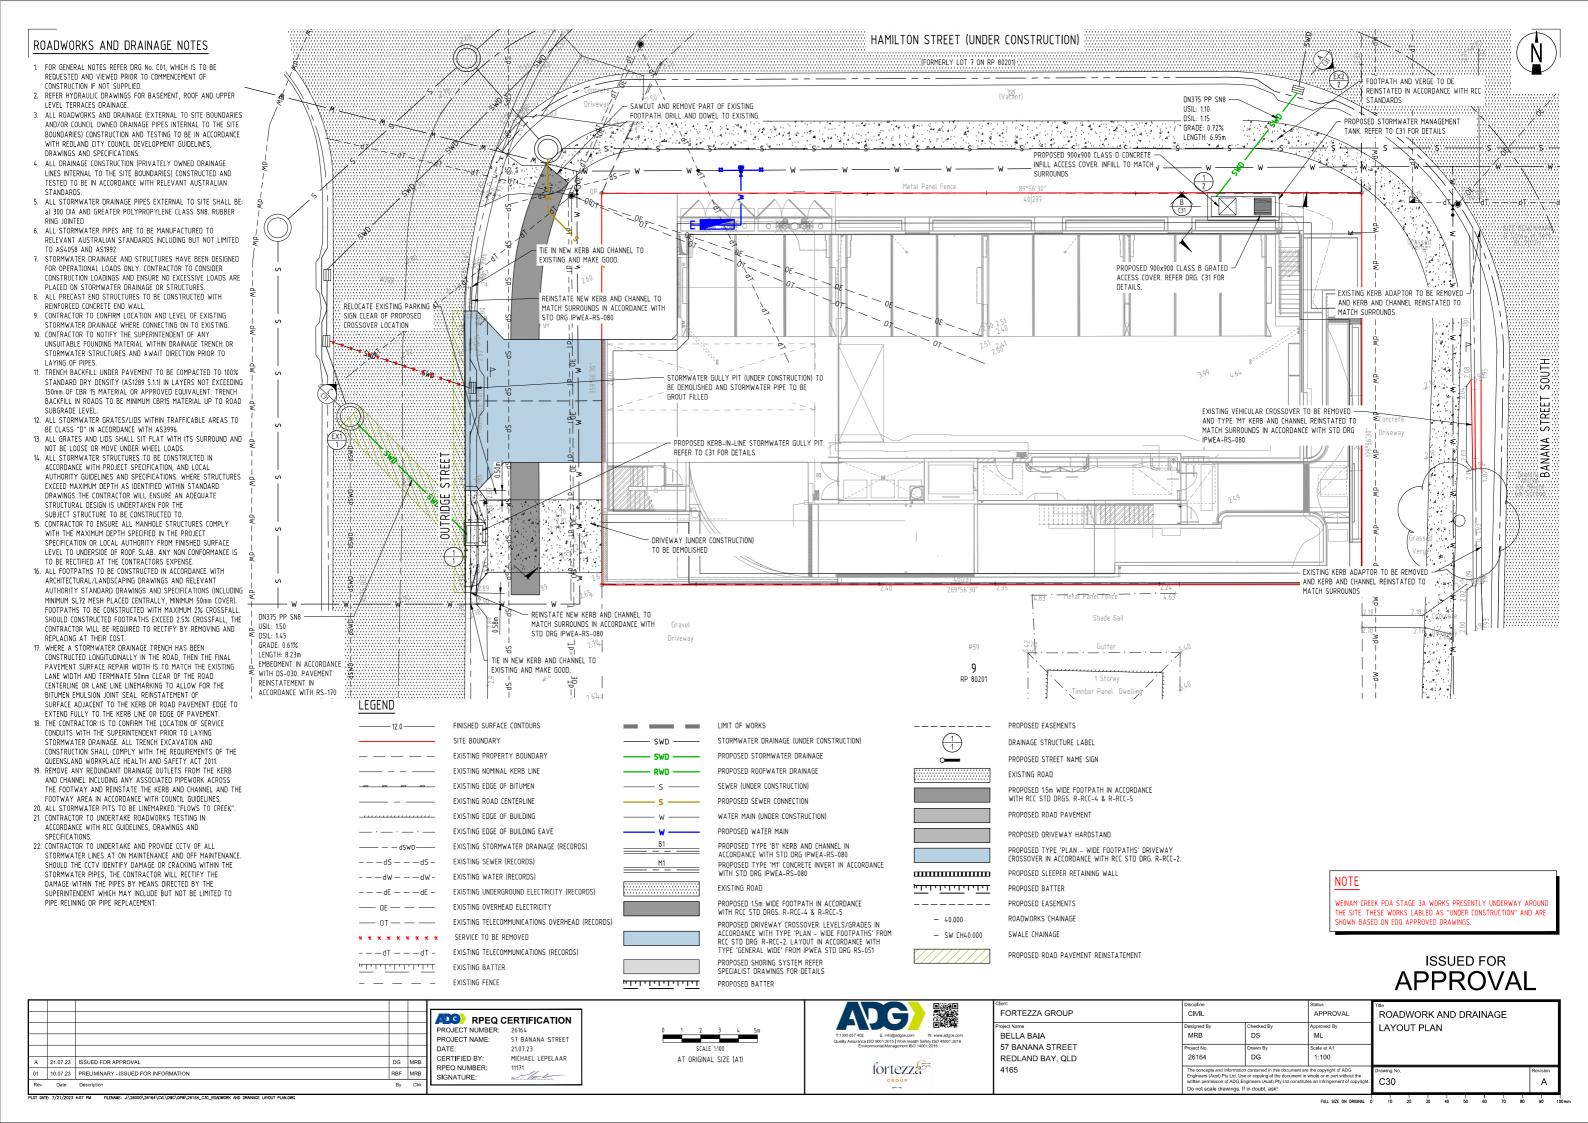

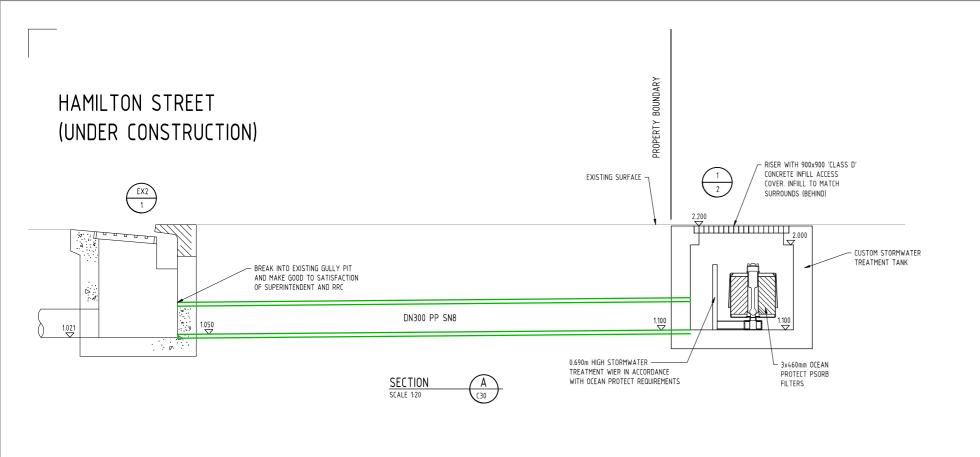

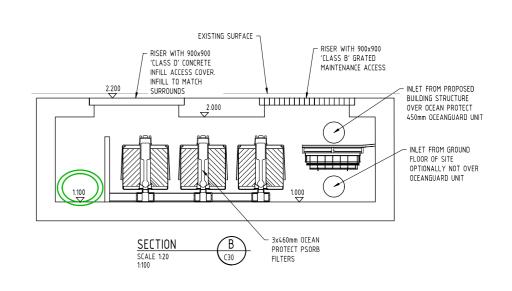

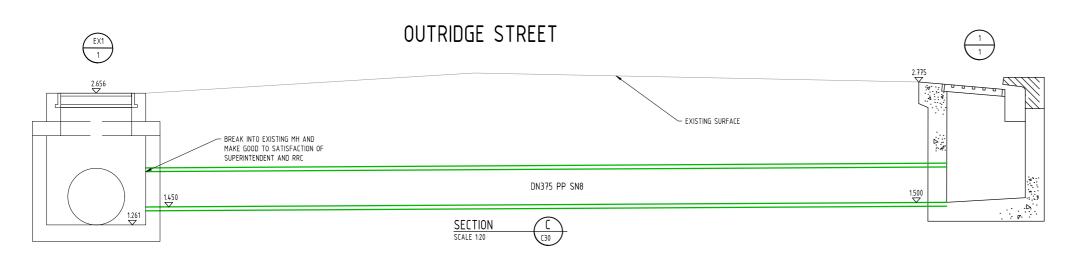

RPEQ CERTIFICATION
PROJECT NUMBER: 26164

PROJECT NAME:

CERTIFIED BY:

RPEQ NUMBER:

SIGNATURE:

RBF MRB

57 BANANA STREET

21.07.23 MICHAEL LEPELAAR



AT ORIGINAL SIZE (A1)

STD IPWEA GULLY PIT 1/1 SETOUT DETAILS (LIL - ON-GRADE PIT - M1 KERB)

SCALE 1:25 @ A1

NOTE: DIMENSIONS IN MILLIMETRES

A 21.07.23 ISSUED FOR APPROVAL

01 10.07.23 PRELIMINARY - ISSUED FOR INFORMATION

TYPICAL KERB REPLACEMENT DETAIL

A	G	
	E: info@adgce.com 9 9001:2015 Work Health : nental Management ISO 14	
	fortezza	à.

Client	Discipline		Status	Title
FORTEZZA GROUP	CIVIL		APPROVAL	R
Project Name	Designed By	Checked By	Approved By	lΝ
BELLA BAIA	MRB	DS	ML	· ·
57 BANANA STREET	Project No.	Drawn By	Scale at A1	1
REDLAND BAY, QLD	26164	DG	1:100	
4165		n contained in this document are		Draw


ROADWORK AND DRAINAGE NOTES AND DETAILS C31


ISSUED FOR **APPROVAL**

LEGEND SITE BOUNDARY EXISTING PROPERTY BOUNDARY EXISTING EASEMENT BOUNDARY FINISHED SURFACE CONTOURS **≭** 3.42 EXISTING SURFACE LEVEL **≭** 3.42 FINISHED SURFACE LEVEL EXISTING NOMINAL KERR LINE EXISTING EDGE OF BITUMEN EXISTING ROAD CENTERLINE EXISTING EDGE OF BUILDING EXISTING EDGE OF BUILDING EAVE EXISTING STORMWATER DRAINAGE EXISTING STORMWATER DRAINAGE (RECORDS) EXISTING SEWER (RECORDS) EXISTING SEWER RISING MAIN EXISTING SEWER RISING MAIN DBYD EXISTING WATER (RECORDS) EXISTING UNDERGROUND ELECTRICITY EXISTING UNDERGROUND ELECTRICITY (RECORDS) EXISTING OVERHEAD ELECTRICITY EXISTING GAS (RECORDS) - - - dG - - - dG -EXISTING NBN EXISTING NBN (RECORDS) —— — — dNBN —— EXISTING TELECOMMUNICATIONS EXISTING TELECOMMUNICATIONS (RECORDS) - Th— — Th— — -EXISTING FIBER OPTIC (RECORDS) - - -d0F ----EXISTING COMMUNICATIONS ABANDONED SERVICE EXISTING BATTER EXISTING FENCE LIMIT OF WORKS STORMWATER DRAINAGE (UNDER CONSTRUCTION) PROPOSED STORMWATER DRAINAGE PROPOSED ROOFWATER DRAINAGE SEWER (UNDER CONSTRUCTION) PROPOSED SEWER WATER MAIN (UNDER CONSTRUCTION) PROPOSED WATER MAIN PROPOSED TYPE 'B1' KERB AND CHANNEL IN ACCORDANCE WITH STD DRG IPWEA-RS-080 PROPOSED TYPE 'M1' CONCRETE INVERT IN ACCORDANCE WITH STD DRG IPWEA-RS-080 PROPOSED ROAD CENTRE LINE $\begin{pmatrix} 1 \\ 1 \end{pmatrix}$ DRAINAGE STRUCTURE LABEL PROPOSED STREET NAME SIGN

NOTES

- 1. FOR GENERAL NOTES REFER DRG No. CO1, WHICH IS TO BE REQUESTED AND VIEWED PRIOR TO COMMENCEMENT OF CONSTRUCTION IF NOT SUPPLIED.
- 2. FOR ROADWORKS NOTES AND DETAILS REFER DRG No. C30
- ALL ROADWORKS AND DRAINAGE CONSTRUCTION AND TESTING TO BE IN ACCORDANCE WITH REDLAND CITY COUNCIL DEVELOPMENT GUIDELINES, DRAWINGS AND SPECIFICATIONS.
- TRENCH BACKFILL UNDER PAVEMENT TO BE COMPACTED TO 100% STANDARD DRY DENSITY (AS1289 5.1.1) IN LAYERS NOT EXCEEDING 150mm OF CBR 15 MATERIAL OR APPROVED EQUIVALENT.
- 5. ALL FOOTPATHS TO BE CONSTRUCTED IN ACCORDANCE WITH ARCHITECTURAL/LANDSCAPING DRAWINGS REDLAND CITY COUNCIL STD DRG R-RCC-4 & R-RCC-5

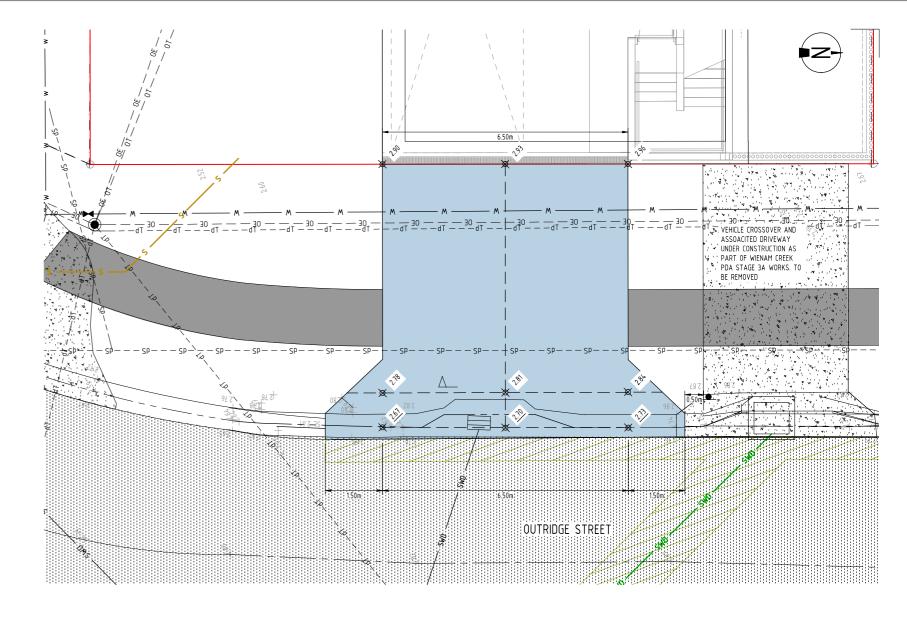

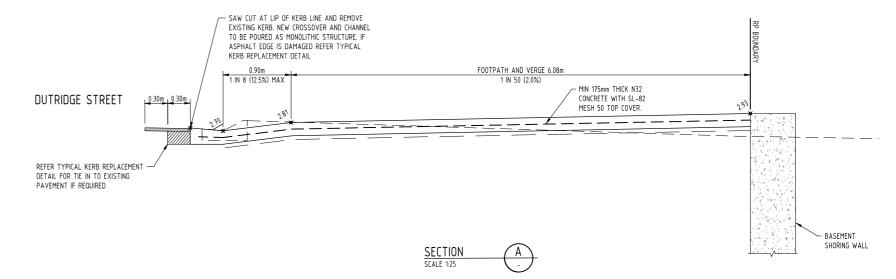

APPROVAL

| A 21.07.23 | ISSUED FOR APPROVAL | DG | MRB | DATE: CERTIFIED BY: RPEQ NUMBER: SIGNATURE: SIGNATURE:

WEINAM CREEK PDA STAGE 3A WORKS PRESENTLY UNDERWAY AROUNT

HOWN BASED ON FDQ APPROVED DRAWINGS

PROPOSED 1.5m WIDE FOOTPATH IN ACCORDANCE WITH RCC STD DRG. R-RCC-4 & R-RCC-5.

PROPOSED DRIVEWAY CROSSOVER. LEVELS/GRADES IN ACCORDANCE WITH TYPE 'PLAN - WIDE FOOTPATHS' FROM RCC STD DRG. R-RCC-2. LAYOUT IN ACCORDANCE WITH

TYPE 'GENERAL WIDE' FROM IPWEA STD DRG RS-051

PROPOSED EASEMENTS
ROADWORKS CHAINAGE

CH40.000


ACCORDANCE WITH STD DRG R-RRC-2.

CROSSOVER LAYOUT TO BE IN ACCORDANCE WITH IPWEA STI

DRG RS-051 IN LIEU OF RCC STD DRG R-RCC-2 TO PROVIDE CLEARANCE TO PROPOSED GULLY PIT. GRADES/LEVELS IN

PROJECT NAME: 2107.23
CERTIFICATION
PROJECT NAME: 256164
PROJECT NAME: 27 BANANA STREET
DATE: 2107.23
CERTIFIED BY: MICHAEL LEPELAAR

11171

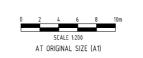



FORTEZZA GROUP	Discipline CIVIL		Status APPROVAL	DRIVEWAY CROSSOVER
Project Name BELLA BAIA 57 BANANA STREET REDLAND BAY, QLD	Designed By MRB Project No. 26164	Checked By DS Drawn By DG	Approved By ML Scale at A1 1:50	DETAILS
4165	Engineers (Aust) Pty written permission of	ormation contained in this doc. Ltd. Use or copying of the doc ADG Engineers (Aust) Pty Ltd ings. If in doubt, ask!	Drawing No. C32	

LEGEND FINISHED SURFACE CONTOURS SITE BOUNDARY EXISTING PROPERTY BOUNDARY EXISTING NOMINAL KERB LINE EXISTING EDGE OF BITUMEN EXISTING ROAD CENTERLINE EXISTING EDGE OF BUILDING EXISTING EDGE OF BUILDING EAVE EXISTING STORMWATER DRAINAGE (RECORDS — dSWD-EXISTING SEWER (RECORDS) ---dS---dS-- - - dW - - - dW -EXISTING WATER (RECORDS) EXISTING UNDERGROUND ELECTRICITY (RECORDS) ---dE---dE-EXISTING OVERHEAD ELECTRICITY EXISTING TELECOMMUNICATIONS OVERHEAD (RECORDS) SERVICE TO BE REMOVED EXISTING TELECOMMUNICATIONS (RECORDS) - Th- - - Th- - -EXISTING BATTER EXISTING FENCE LIMIT OF WORKS STORMWATER DRAINAGE (UNDER CONSTRUCTION) SWD PROPOSED STORMWATER DRAINAGE SEWER (UNDER CONSTRUCTION)

WATER CONNECTION NOTES:

1 ALL WORKS AND MATERIALS SHALL BE IN ACCORDANCE WITH CURRENT SED DESIGN $\label{eq:and_construction_code} \text{AND CONSTRUCTION CODE REQUIREMENTS}.$

PROPOSED SEWER

PROPOSED WATER MAIN

PROPOSED EASEMENTS

WATER MAIN (UNDER CONSTRUCTION)

PROPOSED ROAD PAVEMENT REINSTATEMENT

- 2. EXISTING SERVICES HAVE BEEN PLOTTED FROM SUPPLIED DATA AND AS SUCH THEIR ACCURACY CANNOT BE GUARANTEED IT IS THE RESPONSIBILITY OF THE CONTRACTOR TO ESTABLISH THE LOCATION AND LEVEL OF ALL EXISTING SERVICES PRIOR TO THE COMMENCEMENT OF ANY WORK. ANY DISCREPANCIES SHALL BE REPORTED TO THE SUPERINTENDENT.
- 3. CONTRACTOR SHALL OBTAIN THE LOCATION OF ALL SERVICES AND PROTECT THESE SERVICES PRIOR TO WORKING IN THE VICINITY. CONTRACTOR SHALL BE RESPONSIBLE FOR REPAIR OF ANY DAMAGE TO COUNCIL'S INFRASTRUCTURE. SUCH REPAIR OR REINSTATEMENT TO BE CARRIED OUT IMMEDIATELY TO THE SATISFACTION OF LOCAL COUNCIL AT CONTRACTORS EXPENSE.
- ALL MATERIALS USED IN THE WORKS SHALL COMPLY WITH THE SEQ-SP'S ACCEPTED PRODUCTS AND MATERIALS LIST OR BE APPROPRIATELY SHOWN LISTED AND DEFINED N THE ENGINEERING SUBMISSION SO THAT THE ALTERNATIVE PRODUCT OR MATERIAL CAN BE ASSESSED AND IE APPROPRIATE APPROVED BY THE SEC-SP
- 5. UNLESS SPECIFIED OTHERWISE ALL MATERIALS AND WORK SHALL COMPLY WITH THE RELEVANT AUSTRALIAN STANDARDS
- 6. COVER ON MAINS FROM PERMANENT LEVEL TO BE AS FOLLOWS: 100 & 150 (DN63, 125 & 180 FOR PE100) - 600
- 200, 250 & 300 (DN250, 315 & 355 FOR PE100) 1000mm
- 7. CONDUITS TO BE INSTALLED IN ACCORDANCE WITH SEQ SPECIFICATIONS.
- 8. A WATER METER SUPPLIED AT THE DEVELOPER'S COST, IS TO BE INSTALLED AT THE SERVICE POINT OF EACH LOT IN ACCORDANCE WITH THE STANDARD DRAWING FOR THE SEQ-SP.
- mpvc pipes shall be series 2 class pn16 and comply with as/n2s4765. Fittings shall be cement lined grey iron in accordance with a.s. 2554, or ductile iron CEMENT LINED (DICL) IN ACCORDANCE WITH A.S. 2280. DUCTILE IRON CEMENT LINED (DICL) PIPES AND FITTINGS SHALL BE CLASS PN35 AND COMPLY WITH A.S. 2280. PIPES AND FITTINGS SHALL BE POLYETHYLENE SLEEVED.
- MILD STEEL (MSCL) PIPES SHALL COMPLY WITH A.S. 1579 AND BE CEMENT LINED IN ACCORDANCE WITH A.S. 1281. PIPE COATING SHALL COMPLY WITH A.S. 4321 (SINTAKOTE
- POLYETHYLENE PIPES AND FITTING SHALL BE CLASS PN16 PE100 AND COMPLY WITH A.S. 4130 AND A.S. 4129.
- 10. ALL CONCRETE FOOTPATHS TO BE CLEAR OF WATER MAINS.
- 11. THE CONSTRUCTION OF THE WATER RETICULATION WORK SHOWN IN THIS DRAWING MUST BE SUPERVISED BY AN ENGINEER WHO HAS RPEQ REGISTRATION. WORKS NOT COMPLYING WITH THIS REQUIREMENT WILL NOT BE PERMITTED TO CONNECT INTO RCC'S RETICULATION SYSTEM.
- 12. CONTRACTOR TO UNDERTAKE TESTING AND AS CONSTRUCTED DRAWINGS AS REQUIRED

EQUIVALENT PIPE SIZES (DN) PVC/DICL/MSCI 32 40 50 N/A 110 100 125 N/A 160 150 180 200 250 225 250 250 315 300 355 375 450

DN FOR PE REFERS TO OUTSIDE DIA

ABBREVIATIONS

- CAST IRON CEMENT LINED CISL - CAST IRON SPUN LINED

CONCRETE REINFORCED

. CONCRETE LIN_PEINEORCED DUCTILE IRON

- DUCTILE IRON CEMENT LINED - DIAMETER NOMINAL - EARTHENWARE - FIRE HYDRANT


- MAINTENANCE HOLE - MODIFIED POLYVINYL CHLORIDE MSBW - MILD STEEL BUTT WELD

- MILD STEEL CEMENT LINED MSCL - POLYETHYLENE - ROTATE TO SUIT

STOP COCK/WATER METER - UNPLASTICISED POLYVINYL CHLORIDE uPVC

VITRIFIED CLAY

RCC - REDLAND CITY COUNCIL

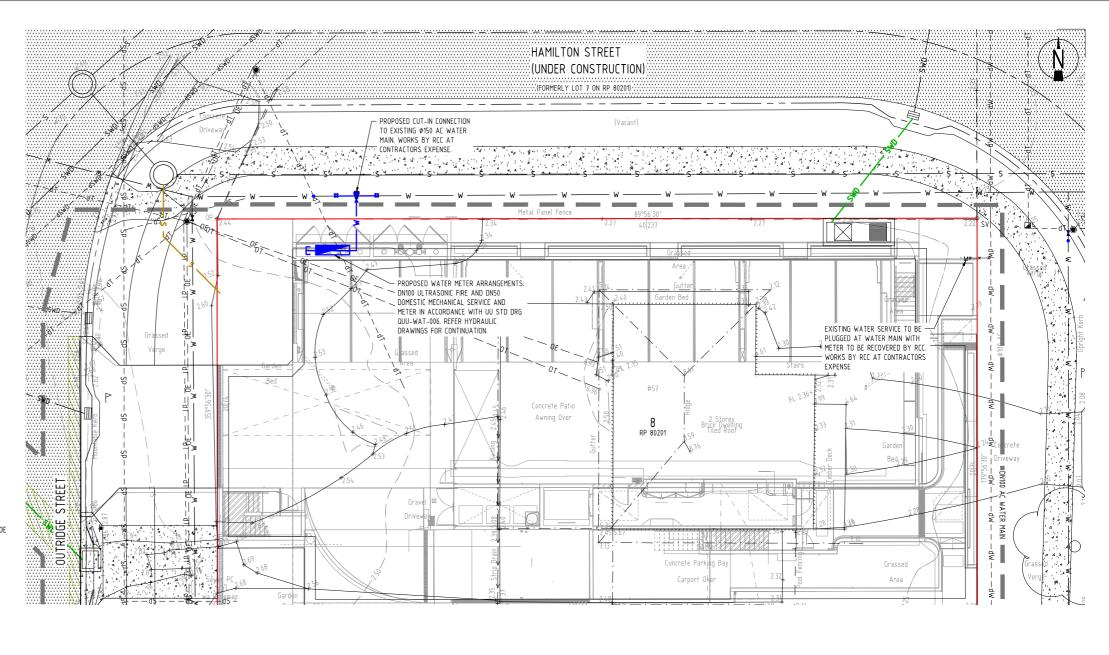

SITE DESCRIPTION EXISTING LOT 08 ON RP80201

VACUUM EXCAVATION NOTE

AT ALL PROPOSED SERVICE CROSSING, SERVICE LOCATION IS TO BE DONE BY NON-DESTRUCTIVE EXCAVATION TO FULLY EXPOSE ALL SERVICES, IN A MINIMUM 10 DAYS PRIOR TO THE START OF WORKS ON SITE SERVICE LOCATION TO BE QUALITY LEVEL A IN ACCORDANCE WITH THE WORKPLACE HEALTH AND SAFETY (EXCAVATION WORK) CODE OF PRACTICE 2015 AND AS5488-2013.

RCC METER ASSEMBLIES

IN THE NOMINATED LOCATIONS SHOWN ON PLANS A RCC APPROVED WATER METER ASSEMBLY SUPPLIED AT THE DEVELOPER'S COST AND DELIVERED TO SITE BY RCC IS TO E INSTALLED AT THE SERVICE POINT OF EACH LOT BY CONTRACTOR IN ACCORDANCE WITH THE STANDARD DRAWING

RCC METER ASSEMBLIES ARE OWNED BY RCC.

ALL WATER CONSTRUCTION WORK SHALL COMPLY WITH THE REQUIREMENTS OF QUIEFNSLAND WORK HEALTH AND SAFETY ACT 2011. CONTACT THE DIVISION OF WORKPLACE HEALTH AND SAFFTY FOR INFORMATION PHONE 1300 362 128

EXISTING SERVICES NOTE

EXISTING SERVICES MAY BE PLOTTED FROM REDLAND CITY COUNCIL RECORDS AND 'D.B.Y.D'. LOCATION AND LEVEL OF ALL EXISTING SERVICES ARE ASSUMED AND ARE TO BE RECONFIRMED ON SITE PRIOR TO CONSTRUCTION. CONTRACTOR TO CONTACT 'DIAL BEFORE YOU DIG' FOR THE LOCATION OF EXISTING PUBLIC UTILITIES PRIOR TO EXCAVATION. ANY DAMAGE TO EXISTING SERVICES WILL BE REPAIRED BY AUTHORITIES AT THE CONTRACTORS EXPENSE.

CONTRACTOR TO ALLOW FOR VACUUM STRIP EXCAVATION & ASSOCIATED SLIRVEY FOR ADG REVIEW TO ENABLE RELEASE OF 'FOR CONSTRUCTION' DRAWINGS

CAUTION EXISTING FIBRE OPTIC, ELECTRICAL & TELECOM CABLES MAY EXIST IN THE VICINITY OF REQUIRED WORKS. FOR ALL WORK WITHIN 2.5m OF MAJOR OPTIC CABLES, THE CONTRACTOR IS REQUIRED TO HAND DIG (POTHOLE) AND EXPOSE THE CABLE/CONDUIT. BEFORE WORK CAN COMMENCE, ON SITE LOCATION SHOULD BE SOUGHT FROM AN ACCREDITED PLANT

WEINAM CREEK PDA STAGE 3A WORKS PRESENTLY UNDERWAY AROUNT THE SITE. THESE WORKS LABLED AS "UNDER CONSTRUCTION" AND ARE OWN BASED ON EDQ APPROVED DRAWINGS.

ASSET REGISTER - WATER INFRASTRUCTURE								
MAINS	DIAMETER	MAT DESIGN	ERIAL CONST	LEN DESIGN	GTH CONST			
	63mm	MDPE						
	100mm	DICL						
	150mm	UPVC DICL MSCL						
SERVICES	DIAMETER	MAT DESIGN	MATERIAL DESIGN CONST		GTH CONST			
	20	PE						
	25	PE						
	100	DICL		~1.5m				
METERS	DIAMETER	NUMBER						
	20							
	50	1						
	100	1						

ISSUED FOR APPROVAL

FORTEZZA GROUP CIVII APPROVAL WATER PROPERTY CONNECTION RPEQ CERTIFICATION LOCALITY PLAN AND NOTES PROJECT NUMBER BELLA BAIA MRB DS MI PROJECT NAME: 57 BANANA STREET Assurance ISO 5001 2015 LWork Health Safety ISO 49 57 BANANA STREET 21.07.23 DATE DG NTS CERTIFIED BY: MICHAEL LEPELAAR REDLAND BAY, QLD 26164 A 21.07.23 ISSUED FOR APPROVAL AT ORIGINAL SIZE (A1) CERT RPEQ NUMBER: 11171 RPEC fortezza 4165 01 10.07.23 PRELIMINARY - ISSUED FOR INFORMATION RBF MRB SIGNATURE: C50 SIGN/

LEGEND FINISHED SURFACE CONTOURS SITE BOUNDARY EXISTING PROPERTY BOUNDARY EXISTING NOMINAL KERB LINE EXISTING EDGE OF BITUMEN EXISTING ROAD CENTERLINE EXISTING EDGE OF BUILDING EXISTING STORMWATER DRAINAGE (RECORDS) — — — dSWD—— EXISTING SEWER (RECORDS) ---dS---dS-EXISTING WATER (RECORDS) - — — dW — — — dW -EXISTING OVERHEAD ELECTRICITY EXISTING TELECOMMUNICATIONS (RECORDS) - Tb- - - Tb- - -ARANDONED SERVICE EXISTING BATTER EXISTING FENCE LIMIT OF WORKS - SWD -----STORMWATER DRAINAGE (UNDER CONSTRUCTION) · SWD · PROPOSED STORMWATER DRAINAGE PROPOSED ROOFWATER DRAINAGE SEWER (UNDER CONSTRUCTION) PROPOSED SEWER WATER MAIN (UNDER CONSTRUCTION) PROPOSED WATER MAIN PROPOSED NOMINAL KERB LINE STRUCTURE LABEL PROPOSED RETAINING WALL PROPOSED EASEMENTS

ABB	REVIATIONS	EQUIVALENT PI	PE SIZES (DN)
AC	- ASBESTOS CEMENT	PVC/DICL/MSCL	PE
CICL	- CAST IRON CEMENT LINED	N/A	110
CISL CR	- CAST IRON SPUN LINED - CONCRETE REINFORCED	100	125
CTS	- CUT TO SUIT	N/A	160
CUR	- CONCRETE UN-REINFORCED	150	180
DI	- DUCTILE IRON	200	250
DICL DN	- DUCTILE IRON CEMENT LINED - DIAMETER NOMINAL	225	250
EW	- EARTHENWARE	250	315
FH	- FIRE HYDRANT	300	355
MH	- MAINTENANCE HOLE	375	450
mPVC MSBW	- MODIFIED POLYVINYL CHLORIDE - MILD STEEL BUTT WELD	NOTES:	

MSCL PE

- MILD STEEL CEMENT LINED - POLYETHYLENE

- ROTATE TO SUIT - STOP COCK/WATER METER

- VITRIFIED CLAY

- URBAN UTILITIES

- UNPLASTICISED POLYVINYL CHLORIDE

_							
ASSET REGISTER - SEWER INFRASTRUCTURE							
SEW MAINS	DIAMETER	MATERIAL DESIGN CONST		LEN DESIGN	GTH CONST		
	-	-		-			
SEW SERVICES	DIAMETER	MATERIAL DESIGN CONST		LEN DESIGN	GTH CONST		
	DN100/110mm	-		-			
	DN150/160mm	uPVC		~6.5m			
	DN225/250mm	-		-			
SEW MH'S			MH TYP	E & NO.			
JEM IIII J		G	F	Х	MS		

UIVALENT P	IPE SIZES (DN)
C/DICL/MSCL	PE
N/A	110
100	125
N/A	160
150	180
200	250
225	250

THESE SERVICES PRIOR TO WORKING IN THE VICINITY, ANY DAMAGE WILL BE THE SOLE RESPONSIBILITY OF THE CONTRACTOR.

NOTES:

1. DN FOR PE REFERS TO OUTSIDE DIA.
2. MIN. DIA. SUD SEWER PC FOR RCC IS 110
3. MIN. DIA. MUD SEWER PC FOR RCC IS 160 5. THE CONTRACTOR SHALL HAVE PROPERTY BOUNDARIES PEGGED AND THE LOCATION OF HOUSE CONNECTIONS CONFIRMED PRIOR TO COMMENCING CONSTRUCTION OF HOUSE CONNECTION BRANCHES.

WS&S D&C CODE AND STANDARD DRAWINGS

1. ALL WORKS AND MATERIALS TO BE IN ACCORDANCE WITH THE GRAVITY

SEWERAGE CODE OF AUSTRALIA SOUTH EAST QUEENSLAND SERVICE PROVIDERS EDITION (WSA 02-2014-3.1) AS RELEVANT TO REDLAND CITY COUNCIL (RCC).

CONSTRUCTED IN ACCORDANCE WITH THE REQUIREMENTS OF WSA 03-2011 AND SEQ.

2. ALL SEWER MAINS SHALL BE PVC-U SN8 RRJ UNLESS OTHERWISE APPROVED.

4. THE CONTRACTOR SHALL OBTAIN THE LOCATION OF ALL SERVICES AND PROTECT

3. THRUST BLOCKS, TRENCH STOPS AND CONCRETE BULK HEADS SHALL BE

SEWER NOTES:

6. NOTWITHSTANDING THE LEVELS SHOWN ON THE LONGITUDINAL SECTIONS THE CONTRACTOR SHALL ENSURE THE HOUSE CONNECTION INSPECTION TEE IS LOCATED AT A DEPTH TO FSL OF BETWEEN 0.50M AND 1.5M. IF THIS REQUIRES RAISING OF THE HC FROM DESIGN INVERT LEVEL, THEN THE CONTRACTOR MUST CONSULT THE SUPERINTENDANT PRIOR TO CONSTRUCTION.

7. FINISHED SURFACE LEVELS SHOWN ON LONGITUDINAL SECTIONS ARE INDICATIVE ONLY AND MANHOLE LIDS SHALL FINISH TO THE GRADE OF THE SURROUNDING LEVELS IN ACCORDANCE WITH THE REQUIREMENTS OF STANDARDS DRAWING

8. SEWER TRENCHES TO BE CONSTRUCTED, COMPACTED AND TESTED IN ACCORDANCE WITH THE SEQ WS&S D&C CODE AND RELEVANT TO RCC. ALL TEST RESULTS SUBJECT TO APPROVAL BY RCC AND ALL NO CONFORMANCES WILL BE RECTIFIED AT THE CONTRACTORS EXPENSE.

9. ANY WORKS ASSOCIATED WITH LIVE SEWERS TO BE CARRIED OUT UNDER THE SUPERVISION OF RCC. CONTRACTOR IS RESPONSIBLE FOR ALL RELEVANT PERMITS AND REQUIREMENTS & COSTS ASSOCIATED WITH OBTAINING SAID PERMITS.

SEWER PROPERTY CONNECTIONS:

TYPE "A" FULL DEPTH (CAPPED END OF P.C. WHERE SEWER MAIN DEPTI

	SEWER LIVE WORKS TABLE								
No.	DESCRIPTION	LOT No.	DIA. SEW	MH No.	MH TYPE	COVER TYPE	F.S.L.	<u>I.L.</u>	DEPTH
1A	REDLAND CITY COUNCIL TO LOCATE AND REMOVE EXISTING SEWER CONNECTION	-	-	-	-	-	-	-	-
1B	REDLAND CITY COUNCIL TO INSTALL NEW 'X TYPE' INTERNAL DROP IN MH EX1/1 AT CORRECT INVERT LEVEL AND PLUG IN MAINTENANCE HOLE		DN150 SN8 uPVC	EX1/1	A	D	~2.590	-0.397	~2.987
2A	REDLAND CITY COUNCIL TO LAY NEW SEWER PROPERTY CONNECTION FROM MH EX1/1 TO 2/1 AND TEMPORARILY CAP FOR FUTURE CONNECTION BY HYDRAULIC ENGINEER		DN150 SN8 uPVC						
3A	ON COMPLETION OF NEW SEWER CONSTRUCTION, CONTRACTOR TO UNDERTAKE TESTING OF SEWER AS REQUIRED BY SEQ D&C CODE								
4.A	ON SUCCESSFUL TESTING AND COMPLETION OF MAINTENANCE INSPECTION, REDLAND CITY COUNCIL TO REMOVE PLUG ON PROPERTY CONNECTION IN MH EX1/1								


CONTRACTOR TO ALLOW FOR VACUUM STRIP EXCAVATION & ASSOCIATED SURVEY FOR ADG REVIEW TO ENABLE RELEASE OF 'FOR CONSTRUCTION' DRAWINGS

FOR SEWER NOTES


REFER TO ADD ENGINEERING DRG No. C60.

EXISTING SERVICES NOTE EXISTING SERVICES MAY BE PLOTTED FROM REDLAND CITY COUNCIL RECORDS AND 'D.B.Y.D'. LOCATION AND LEVEL OF ALL EXISTING SERVICES ARE ASSUMED AND ARE TO BE RECONFIRMED ON SITE PRIOR TO CONSTRUCTION, CONTRACTOR EXISTING PUBLIC LITHLITIES PRIOR TO EXCAVATION ANY DAMAGE TO EXISTING SERVICES WILL BE REPAIRED BY AUTHORITIES AT THE CONTRACTORS EXPENSE

WEINAM CREEK PDA STAGE 3A WORKS PRESENTLY UNDERWAY AROUND HE SITE. THESE WORKS LABLED AS "UNDER CONSTRUCTION" AND ARE HOWN BASED ON EDQ APPROVED DRAWINGS.

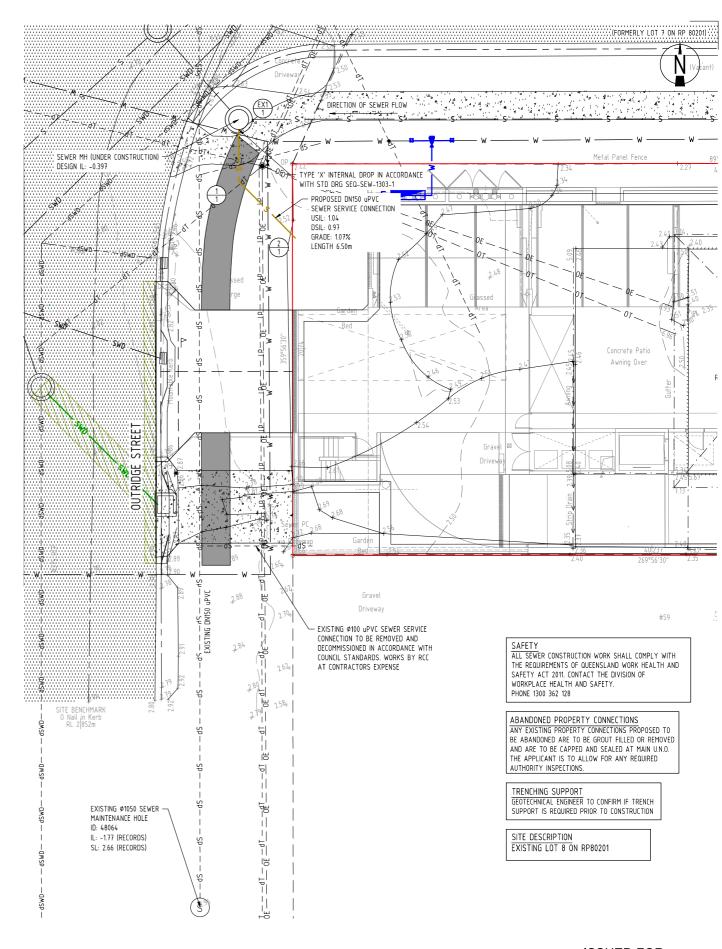

ISSUED FOR APPROVAL

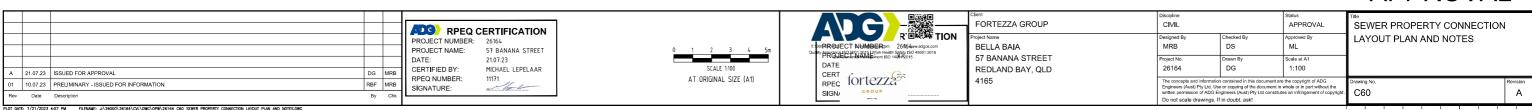



Appendix D EDQ Approved Design Drawings

C-1108

C-1109

C-1110

C-1111

C-1112

C-1113

C-1114

C-1115

C-1116

C-1200

R-RCC-1

R-RCC-2

R-RCC-3

R-RCC-4

R-RCC-5

R-RCC-6


WEINAM CREEK PRIORITY DEVELOPMENT

PLANS AND DOCUMENTS referred to in the PDA **DEVELOPMENT APPROVAL**

AREA - STAGE 3A

WEINAM CREEK, REDLAND BAY. FOR REDLAND INVESTMENT CORPORATION.

LOCALITY PLAN & DRAWING INDEX C-1002 ESTATE PLAN C-1003 KEY PLAN EXISTING SITE FEATURES C-1004 CONTROL LINE SETOUT SHEET-1 C-1006 CONTROL LINE SETOUT SHEET-2 C-1007 CONTROL LINE SETOUT SHEET-3 C-1008 CONTROL LINE SETOUT SHEET-4 C-1009 CONTROL LINE SETOUT SHEET-5 C-1010 CONTROL LINE SETOUT SHEET-6 C-1011 CONTROL LINE SETOUT SHEET-7 C-1012 CONTROL LINE SETOUT SHEET-8 CONTROL LINE SETOUT SHEET-9 C-1013 C-1014 CONTROL LINE SETOUT SHEET-10 C-1015 RETAINING WALL (RW01) CONTROL LINE SETOUT C-1016 RETAINING WALL (RW01) & (RW02) CONTROL LINE SETOUT DRIVEWAY CONTROL LINE & SETOUT TABLE C-1017 C-1018 FOOTPATH CONTROL LINE & SETOUT TABLE C-1019 TYPICAL SECTIONS & STANDARD NOTES - SHEET 1 C-1020 TYPICAL SECTIONS & STANDARD NOTES - SHEET 2 C-1021 DETAILS DEMOLITION PLAN - SHEET 1 C-1022 DETAILS DEMOLITION PLAN - SHEET 2 DETAILS DEMOLITION PLAN - SHEET 3 C-1023 DETAILS DEMOLITION PLAN - SHEET 4 DETAILS DEMOLITION PLAN - SHEET 5 C-1025 C-1026 DETAILS DEMOLITION PLAN - SHEET 6 C-1027 DETAILS DEMOLITION PLAN - SHEET 7 DETAILS DEMOLITION PLAN - SHEET 8 C-1028 C-1100 MC01 LONGITUDINAL SECTIONS - SHEET C-1101 MC01 LONGITUDINAL SECTIONS - SHEET 2 C-1102 MC02 & MC03 LONGITUDINAL SECTIONS C-1103 MC04 & MC05 LONGITUDINAL SECTIONS C-1104 MC06 LONGITUDINAL SECTIONS RETAINING WALL (RW01) LONGITUDINAL SECTIONS C-1105 RETAINING WALL (RW02) LONGITUDINAL SECTIONS C-1106 C-1107 RETAINING WALL (RW03) LONGITUDINAL SECTIONS

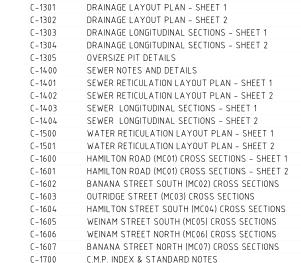

CONSTRUCTION MANAGEMENT PLAN

EROSION & SEDIMENT CONTROL PLAN

EROSION & SEDIMENT CONTROL STANDARD NOTES

STANDARD EMBEDMENT ALL PIPE TYPES

DRAINAGE NOTES AND DETAILS

STANDARD DRAWINGS - W.S.A.A.

C-1701

C-1703

WAT-1201


WAT-1205	THRUST BLOCK DETAILS CONCRETE BLOCKS
WAT-1207	THRUST AND ANCHOR BLOCKS GATE VALVES AND VERTICAL BENDS
WAT-1300	VALVE AND HYDRANT IDENTIFICATION MARKERS & MARKER POSTS
WAT-1301	TYPICAL VALVE & HYDRANT INSTALLATION VALVE ARRANGEMENT
WAT-1302	TYPICAL VALVE & HYDRANT INSTALLATION HYDRANTS AND AIR
	RELIEF VALVES
WAT-1303	TYPICAL SURFACE FITTING INSTALLATION GATE VALVE SURFACE
	BOXES NON TRAFFICABLE
WAT-1305	TYPICAL SURFACE FITTING INSTALLATION HYDRANT SURFACE BOXES
	TRAFFICABLE AND NON-TRAFFICABLE
WAT-1313	FLANGED JOINTS BOLTING DETAILS

EMBEDMENT & TRENCHFILL TYPICAL ARRANGEMENT

STANDARD DRAWINGS - IPWEAQ

D3-010	STORTIWATER ACCESS CHAINDER DETAIL 1030 TO 2100 DIAMETER	DR0-5-0025	P 11
DS-011	ACCESS CHAMBER ROOF SLABS DIA 1050 – 2100	22 2 2.22	INT
DS-013	ACCESS CHAMBER ROOF SLAB - RECTANGULAR STANDARD REINFORCEMENT		
DS-019	MANHOLE COVER (ROADWAY) 1050 TO 2100 DIAMETER		
DS-030	BEDDING AND BACKFILLING - EXCAVATION, BEDDING AND BACKFILLING OF CONVERT-FIBR	E REINFORCED DRAINAGE	PIPES
DS-040	SEDIMENT CONTROL DEVICES SEDIMENT FENCE, ENTRY/EXIT SEDIMENT TRAP		
DS-041	SEDIMENT CONTROL DEVICES KERB AND FIELD INLETS – CHECK DAMS & STRAW BALES		
DS-050	DRAINAGE PITS FIELD INLET TYPE 1 AND TYPE 2		
DS-063	DRAINAGE PITS KERB INLET-LIP IN LINE GENERAL ARRANGEMENT		
RS-080	KERB AND CHANNEL – PROFILES AND DIMENSIONS		
RS-090	KERB RAMPS – RAMPED PEDESTRIAN CROSSINGS		
RS-094	KERB RAMPS - LOCATIONS AND CONFIGURATIONS		

Approval no: DEV2022/1279

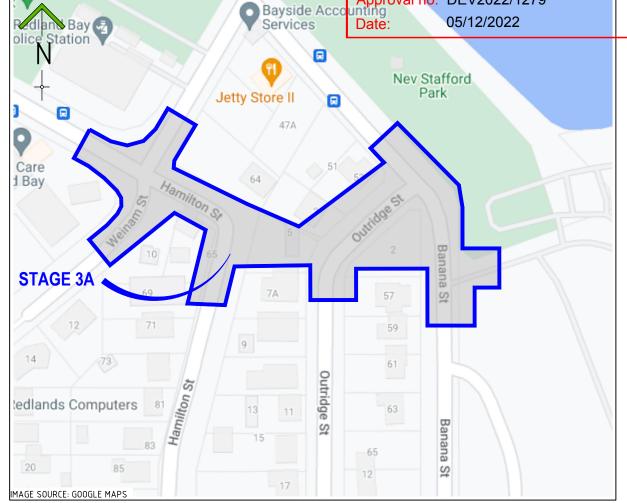

LOCALITY PLAN

STANDARD DRAWINGS - TMR

SCALE: NTS

PIPE CULVERTS - WINGWALLS, HEADWALLS AND APRON FOR PIPE DIAMETER 750 TO 2400 - DRAWING 1 OF 2 TO 2 OF 2 SD-1305 PIPE CULVERTS - HEADWALL AND APRON FOR PIPE DIAMETER 375 TO 675 ACCESS CHAMBER - ROOF SLABS 1050 TO 2100 SD-1308 ROAD EDGE AND GUIDE POSTS - TIMBER AND TUBULAR STEEL POST AND INSTALLATION DETAILS CULVERTS - INSTALLATION, BEDDING AND FILLING/BACKFILLING AGAINST/OVER CULVERTS

STANDARD DRAWINGS - TRANSLINK

PTIM, BUS STOP INFRASTRUCTURE CHAPTER DRG-5-0022 INTERMEDIATE STOP - SITE LAYOUT - WITH INDENTED BUS BAY

PTIM, BUS STOP INFRASTRUCTURE CHAPTER INTERMEDIATE STOP - SITE LAYOUT - ACCESS EXAMPLES

THE ORIGINAL PLANS OF THIS PLAN SET WERE PRODUCED USING COLOUR FOR GREATER CLARITY AND OBJECT DEFINITION. WORKING WITH A BLACK AND WHITE COPY MAY CAUSE ERRORS. IF THESE DRAWINGS ARE NOT IN COLOUR THEN YOU **DO NOT** HAVE THE CORRECT PRESENTATION AND SHOULD SEEK ADVICE.

NOTWITHSTANDING THAT EXISTING SERVICES MAY OR MAY NOT BE SHOWN ON THESE DRAWINGS, NO RESPONSIBILITY IS TAKEN BY ESQ FOR THIS INFORMATION, WHICH HAS BEEN SUPPLIED BY OTHERS, EXISTING SERVICES ARE PROVIDED FOR INFORMATION ONLY. NO CONSTRUCTION WORK SHALL BE UNDERTAKEN UNTIL SERVICE LOCATIONS HAVE BEEN CONFIRMED ON SITE WITH THE RELEVANT AUTHORITY.

	REVISIONS	ISSUE DATE	SCALE:
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2			
1	RFI RESPONSE	06/10/2022	
0	ISSUE FOR APPROVAL	8/8/2022	DO NOT SCALE FROM PLAN

DESIGN DETAIL - SHEET 1

DESIGN DETAIL - SHEET 2

DESIGN DETAIL - SHEET 3

DESIGN DETAIL - SHEET 4

DESIGN DETAIL - SHEET 5

DESIGN DETAIL - SHEET 6

DESIGN DETAIL - SHEET 7

DESIGN DETAIL - SHEET 8

FOOTPATH AND DRIVEWAY SETOUT TABLE

STANDARD DRAWINGS - REDLAND CITY COUNCIL

FOOTPATH PROFILE

LINE MARKING AND SINAGE DRAWING - SHEET 1

LINE MARKING AND SINAGE DRAWING - SHEET 2

DOMESTIC DRIVEWAY CROSSOVER

DRIVEWAY CROSSOVER (TYPE A)

COMMERCIAL/INDUSTRIAL/MULTIPLE DWELLING/APARTMENT BUILDING

PUBLIC UTILITIES IN ROAD RESERVE - CORRIDORS AND ALIGNMENTS

COMMERCIAL/INDUSTRIAL DRIVEWAY CROSSOVER (TYPE B)

PUBLIC UTILITIES IN ROAD RESERVE - CONDUIT SECTIONS

CONCRETE FOOTPATH AND SHARED USE PATHS

FOR APPROVAL





ROAD FURNITURE - TRAFFIC SIGN INSTALLATION DETAILS

SUBSOIL DRAINS - DETAILS AND LOCATION

PAVEMENT EXTENSION - TRENCHING AND WIDENING

ROAD FURNITURE - STREET NAME SIGN AND LOCATION (FINGERBOARD)



TITLE: LOCALITY PLAN & DRAWING INDEX

WEINAM CREEK PRIORITY DEVELOPMENT AREA STAGE 3A WEINAM CREEK REDLAND BAY FOR REDLAND INVESTMENT CORPORATION

No. 1 of 72 DRAWINGS DWG No. FC-22-014-3A C-1001 0 1 2 3 4 5



APPROVED DATE: 06/10/22

RS-130

RS-131

RS-140

RS-170

PLANS AND DOCUMENTS referred to in the PDA **DEVELOPMENT APPROVAL**



Approval no: DEV2022/1279


05/12/2022



- ALL BOUNDARIES SHOWN ON THIS PLAN ARE SUBJECT TO FINAL SURVEY
- CONTOURS SHOWN DEPICT EXISTING
- SURFACE AND ARE AT 0.25m INTERVALS.

NOTWITHSTANDING THAT EXISTING SERVICES MAY OR MAY NOT BE SHOWN ON THESE DRAWINGS. NO RESPONSIBILITY IS TAKEN BY ESQ FOR THIS INFORMATION, WHICH HAS BEEN SUPPLIED BY OTHERS. EXISTING SERVICES ARE PROVIDED FOR INFORMATION ONLY. NO CONSTRUCTION WORK SHALL BE UNDERTAKEN UNTIL SERVICE LOCATIONS HAVE BEEN CONFIRMED ON SITE WITH THE RELEVANT AUTHORITY

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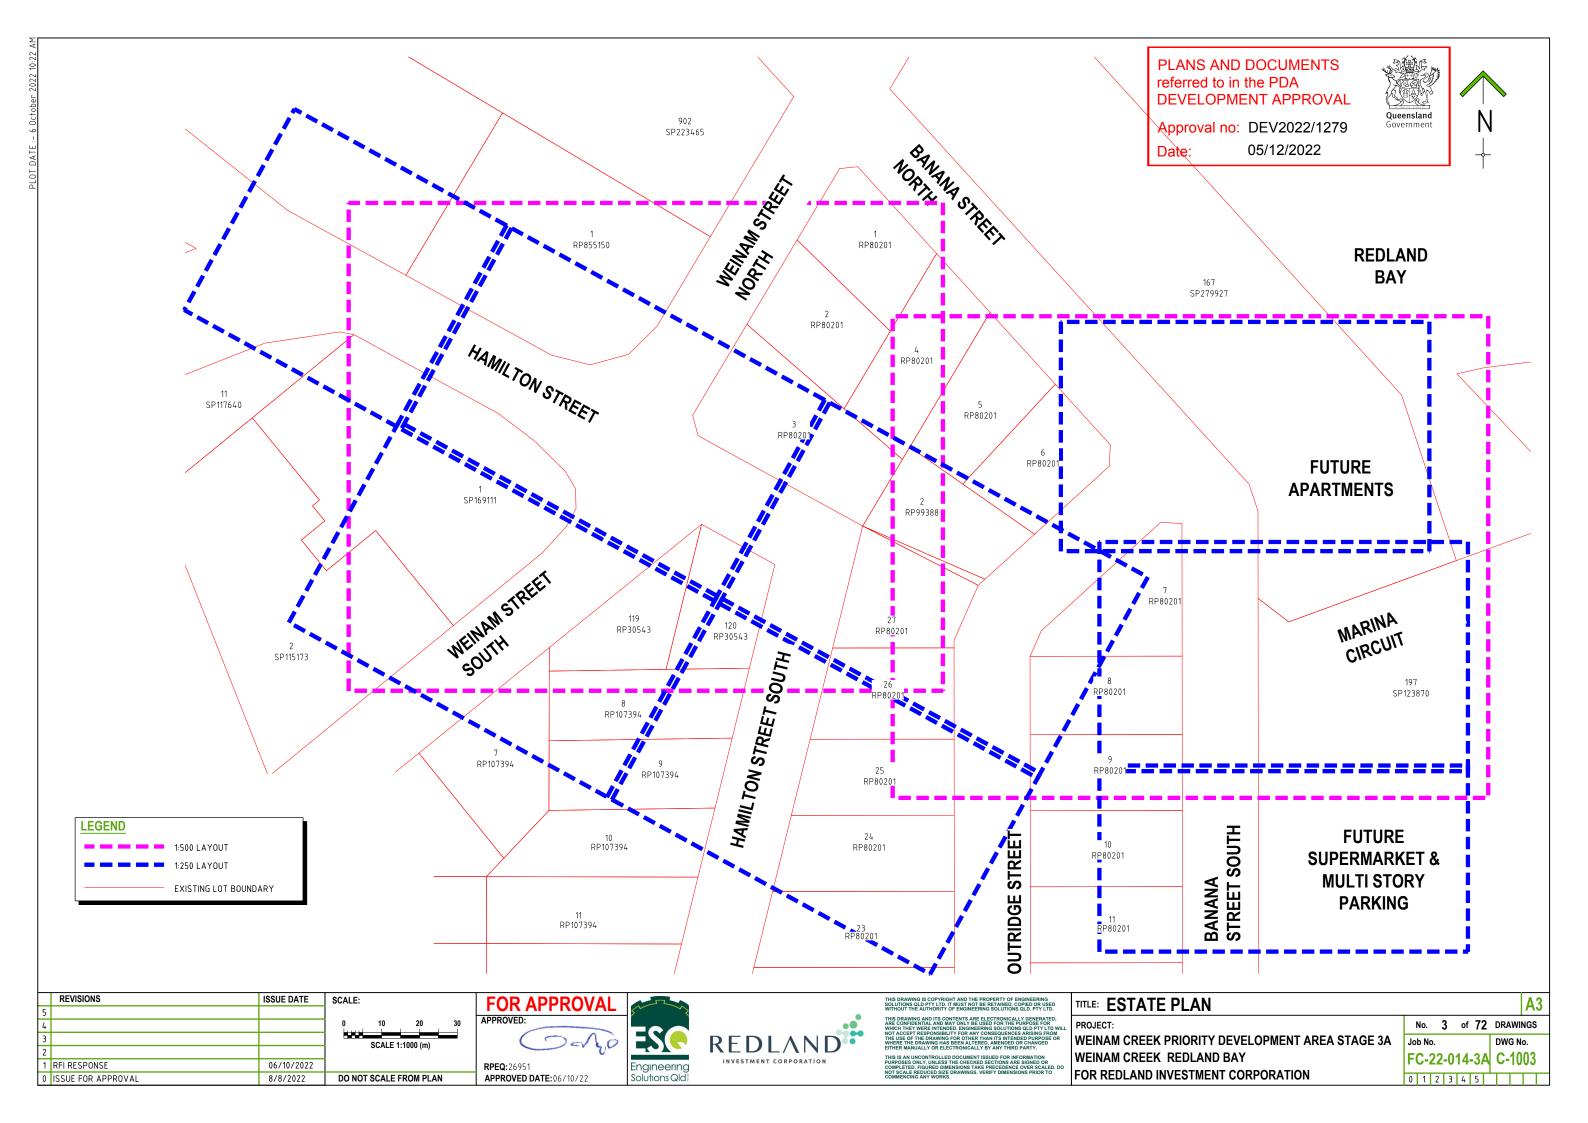
APPROVED DATE: 06/10/22

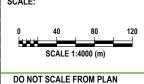






WEINAM CREEK PRIORITY DEVELOPMENT AREA STAGE 3A WEINAM CREEK REDLAND BAY FOR REDLAND INVESTMENT CORPORATION

					<i>_</i>
No.	2	of	72	DRAWI	NGS
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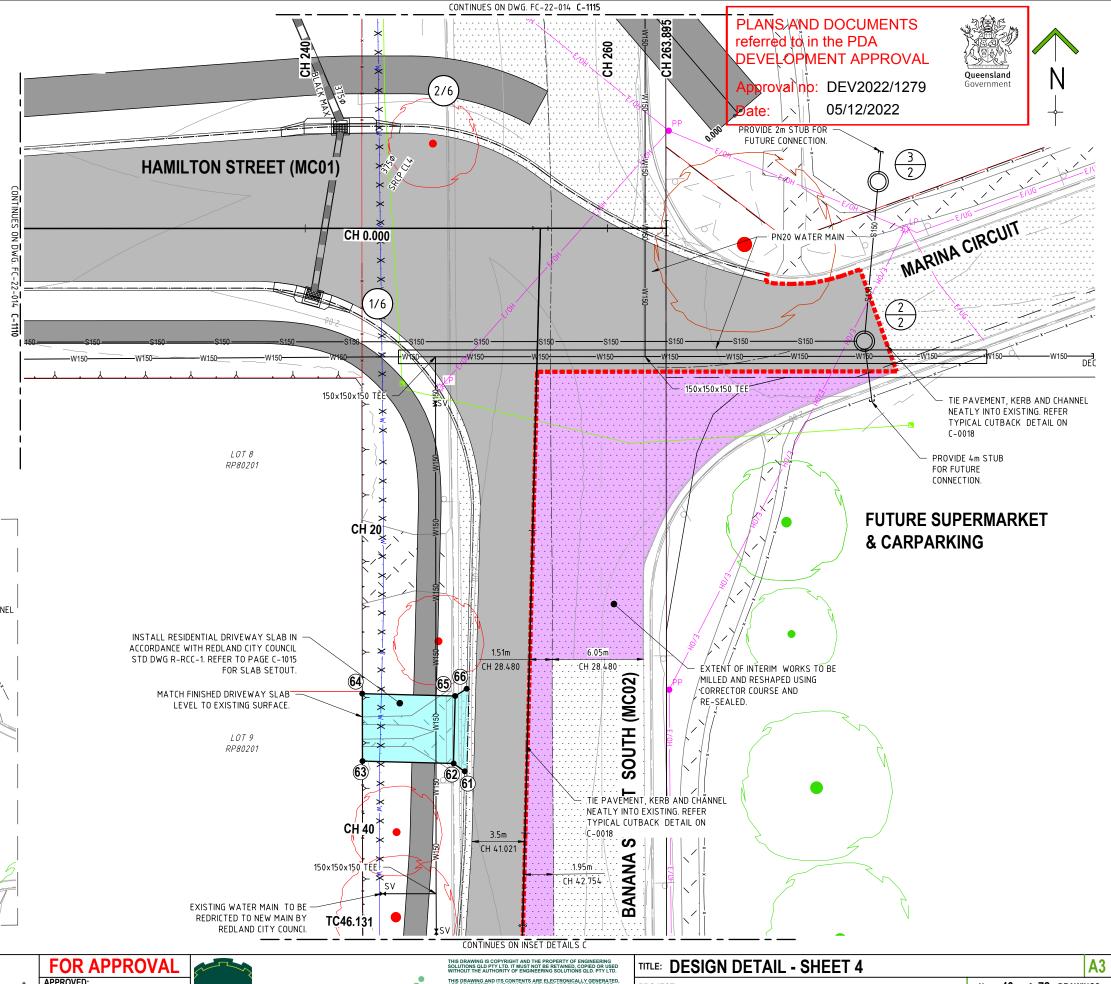


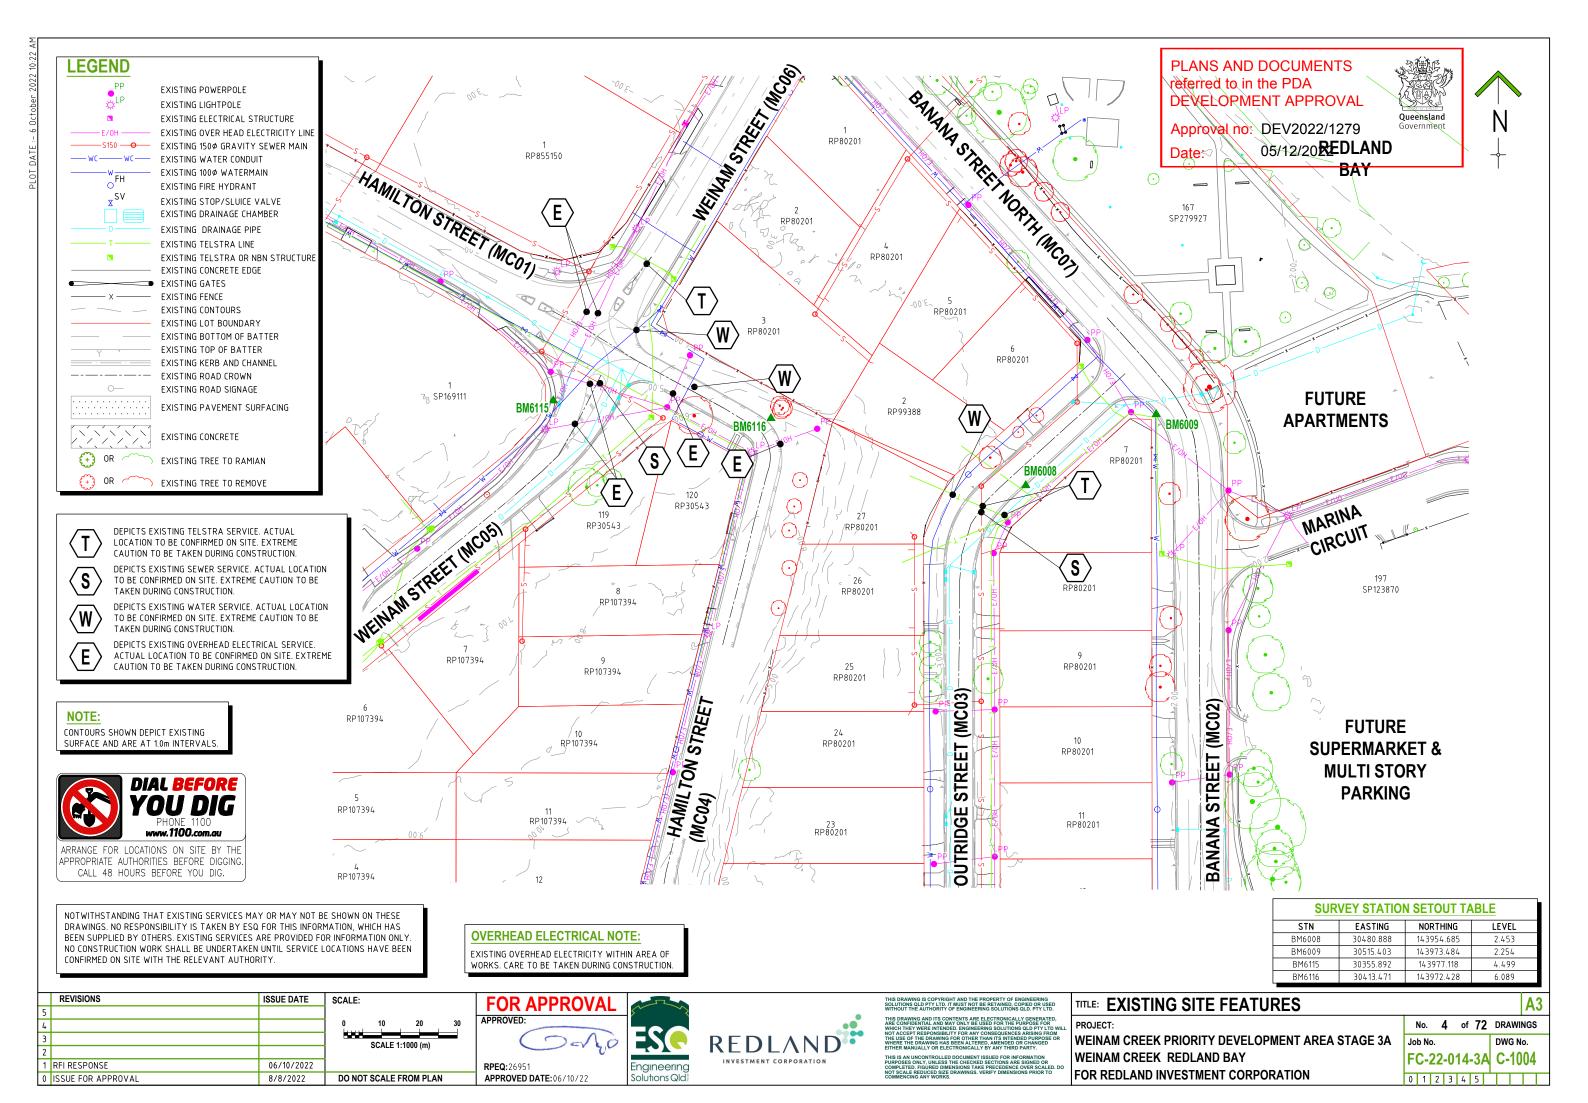


NOTWITHSTANDING THAT EXISTING SERVICES MAY OR MAY NOT BE SHOWN ON THESE DRAWINGS. NO RESPONSIBILITY IS TAKEN BY ESQ FOR THIS INFORMATION, WHICH HAS BEEN SUPPLIED BY OTHERS. EXISTING SERVICES ARE PROVIDED FOR INFORMATION ONLY NO CONSTRUCTION WORK SHALL BE UNDERTAKEN UNTIL SERVICE LOCATIONS HAVE BEEN CONFIRMED ON SITE WITH THE RELEVANT AUTHORITY.

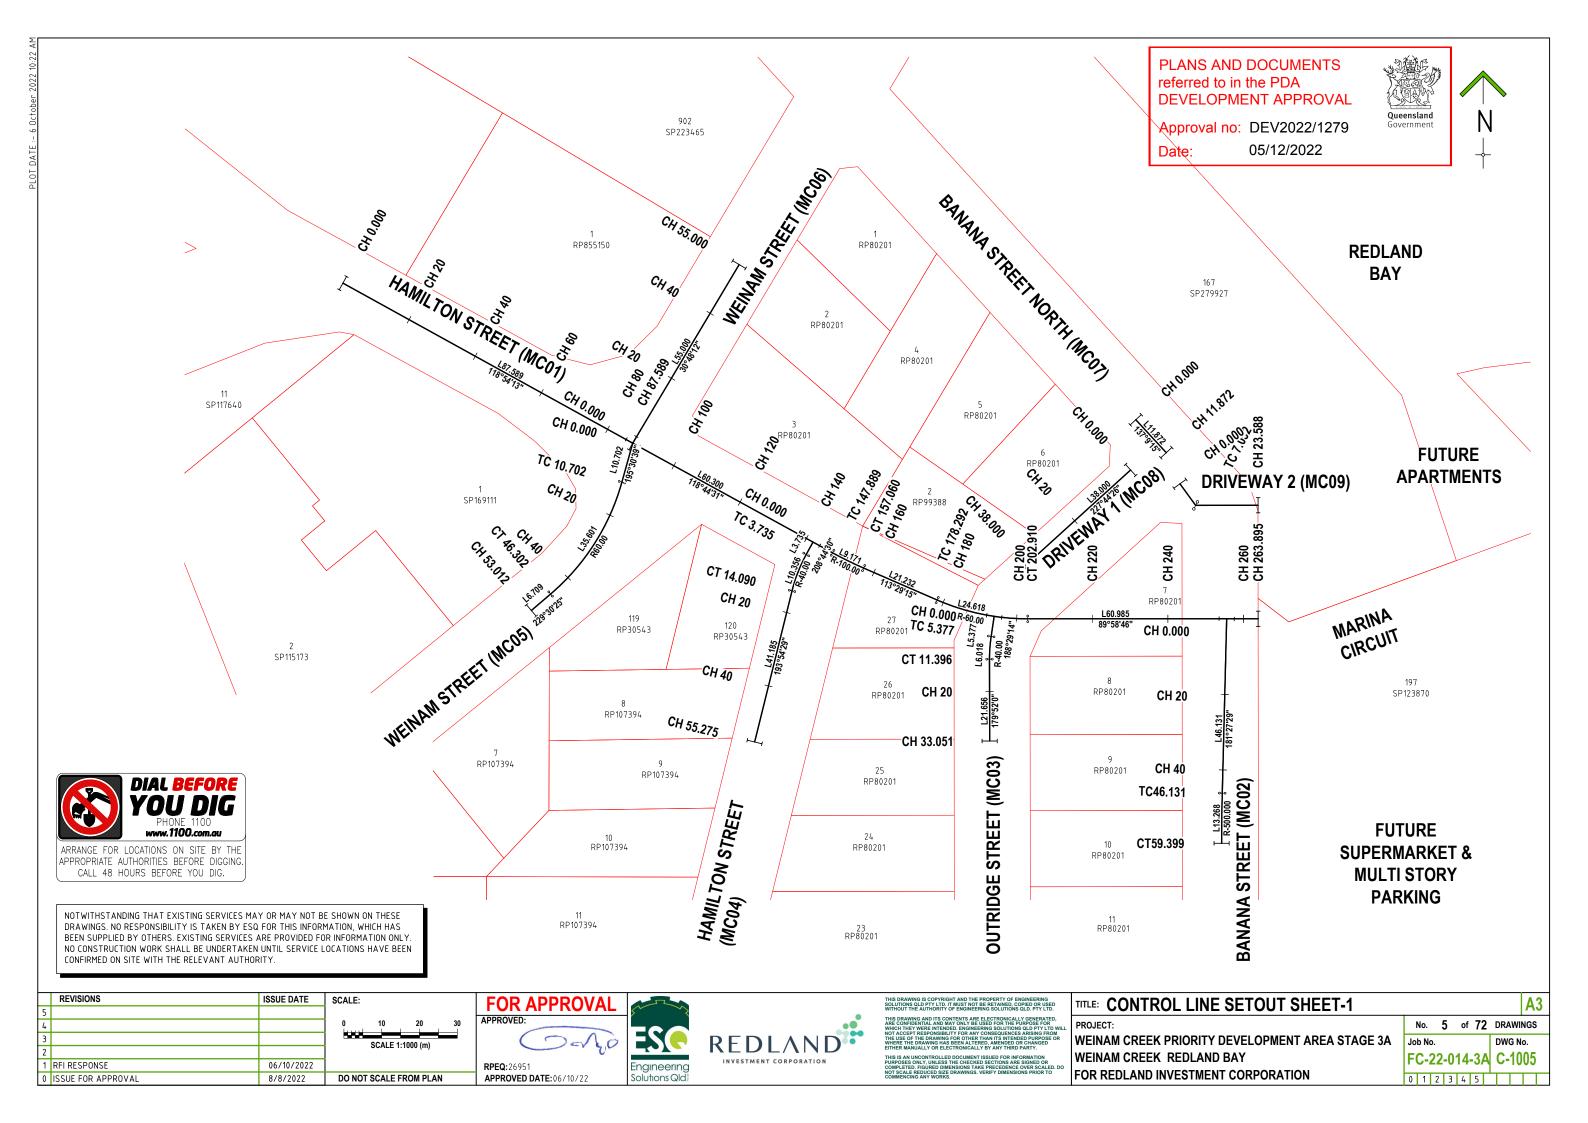GENERAL NOTES:

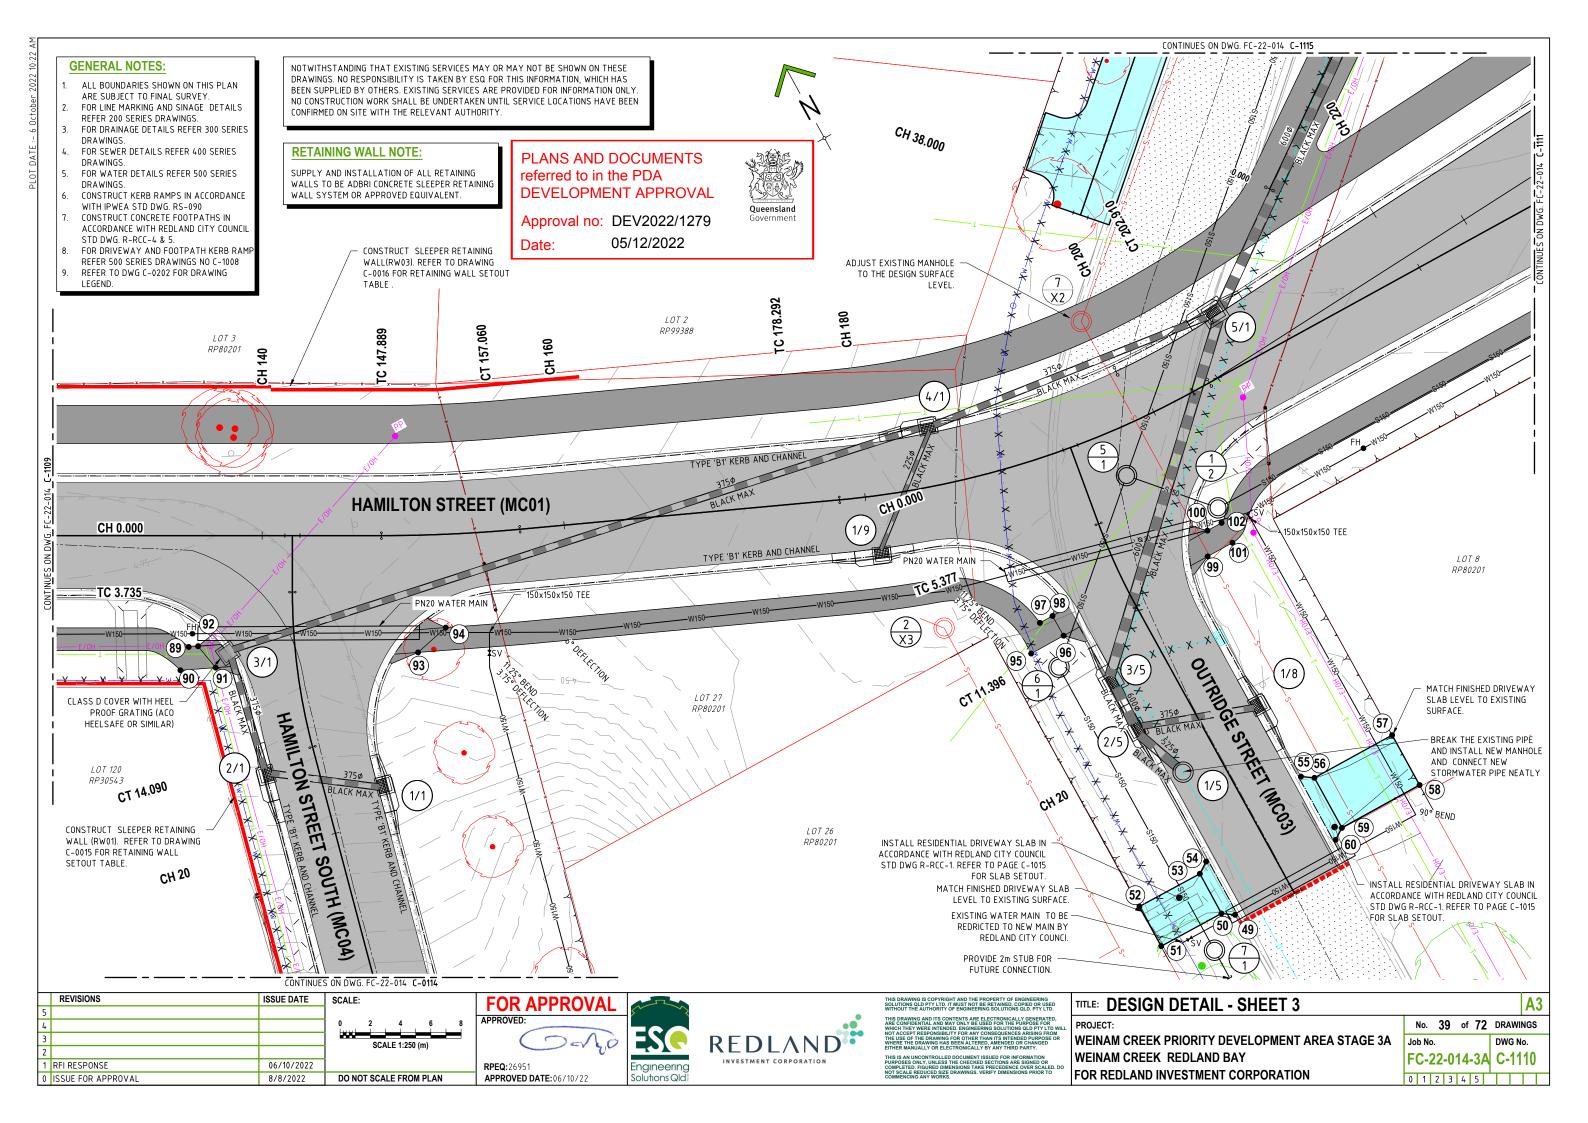- ALL BOUNDARIES SHOWN ON THIS PLAN ARE SUBJECT TO FINAL SURVEY.
- FOR LINE MARKING AND SINAGE DETAILS REFER 200 SERIES DRAWINGS.
- FOR DRAINAGE DETAILS REFER 300 SERIES
- FOR SEWER DETAILS REFER 400 SERIES
- FOR WATER DETAILS REFER 500 SERIES DRAWINGS
- CONSTRUCT KERB RAMPS IN ACCORDANCE WITH IPWEA STD DWG. RS-090 CONSTRUCT CONCRETE FOOTPATHS IN ACCORDANCE WITH REDLAND CITY COUNCIL
- STD DWG. R-RCC-4 & 5.
 FOR DRIVEWAY AND FOOTPATH KERB RAMP REFER 500 SERIES DRAWINGS NO C-1008
- REFER TO DWG C-0202 FOR DRAWING LEGEND.



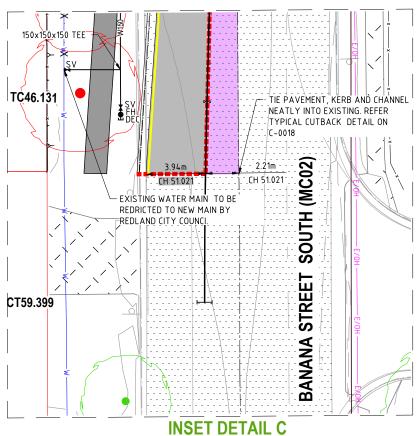

REVISIONS ISSUE DATE SCALE: SCALE 1:250 (m) 1 RFI RESPONSE 06/10/2022 0 ISSUE FOR APPROVAL 8/8/2022 DO NOT SCALE FROM PLAN

APPROVED:

APPROVED DATE: 06/10/22

RPEQ:26951








FOR REDLAND INVESTMENT CORPORATION


WEINAM CREEK REDLAND BAY


No. 40 of 72 DRAWINGS **WEINAM CREEK PRIORITY DEVELOPMENT AREA STAGE 3A** Job No. DWG No. FC-22-014-3A C-1111 0 1 2 3 4 5

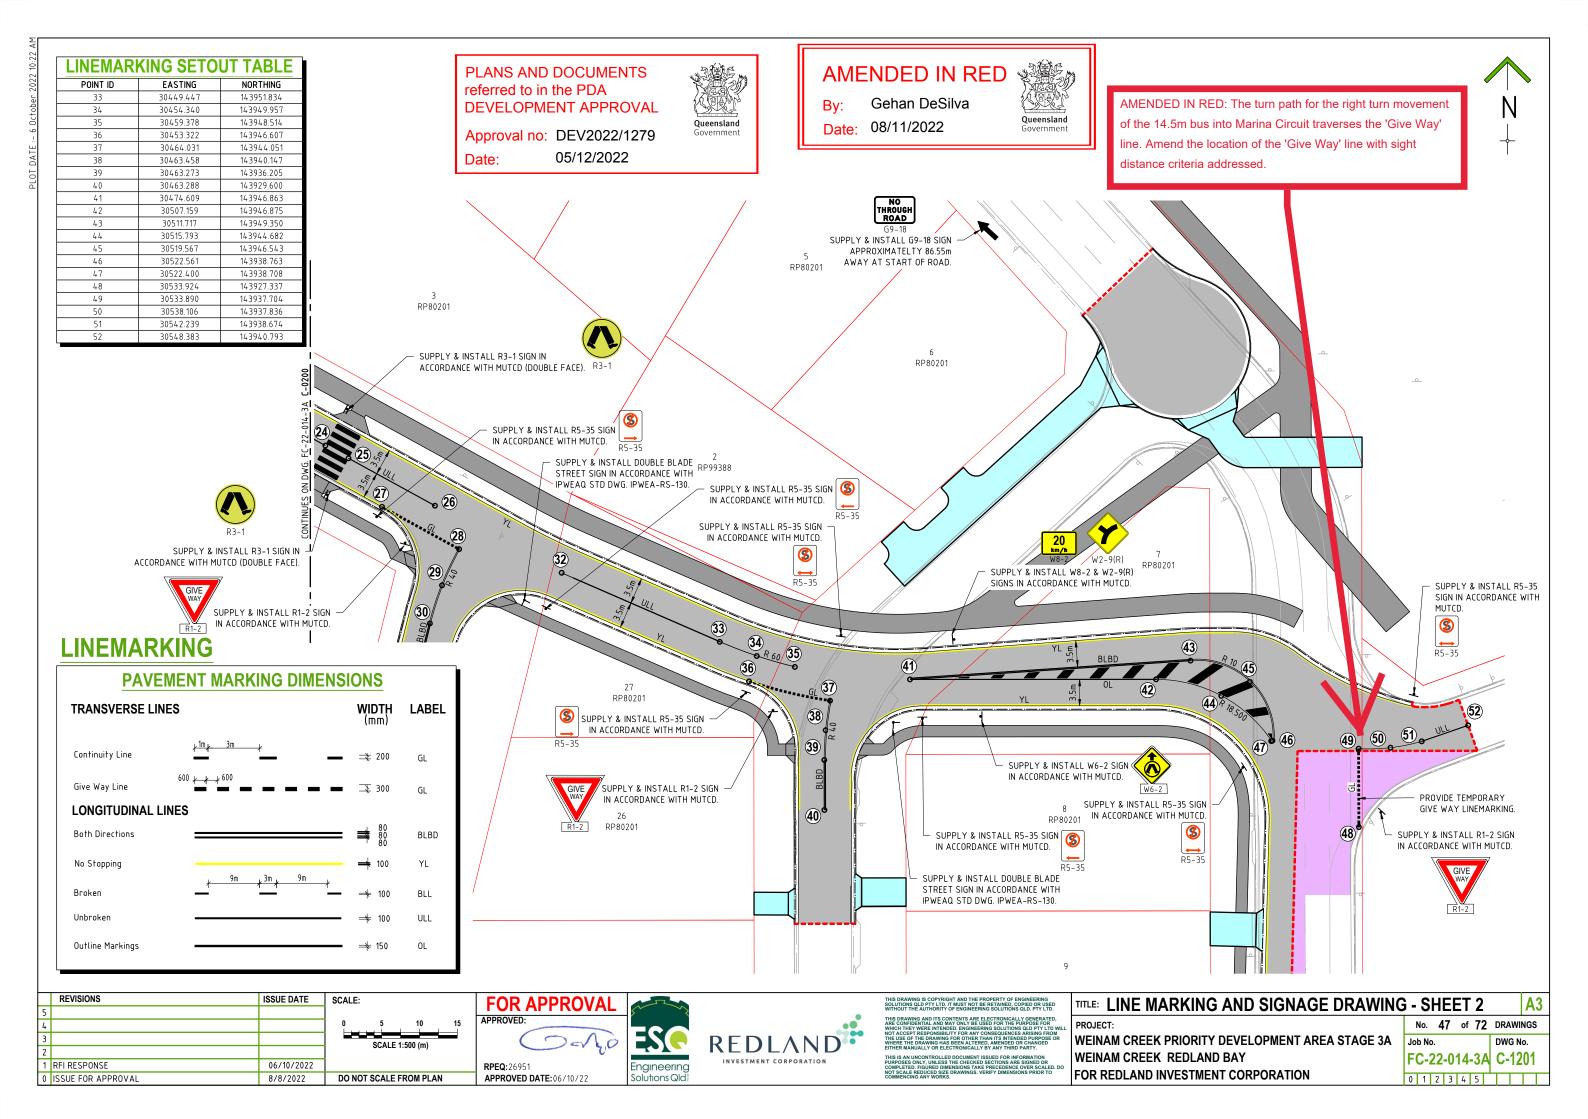


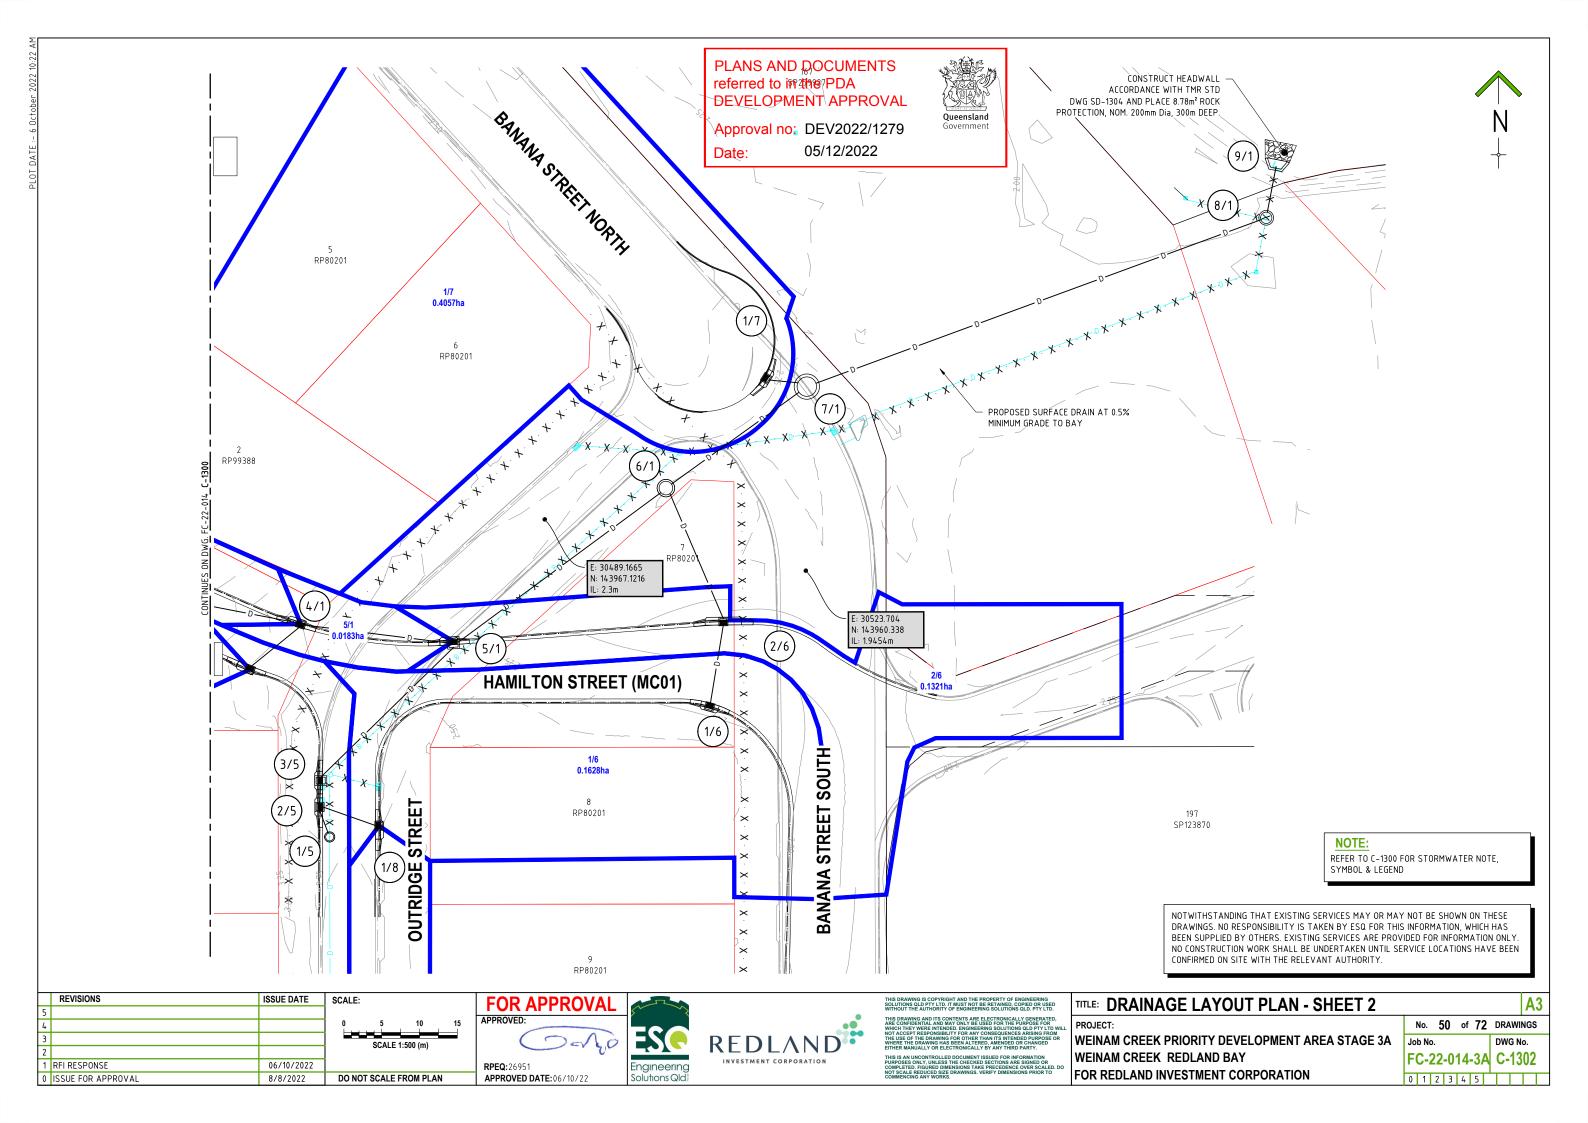

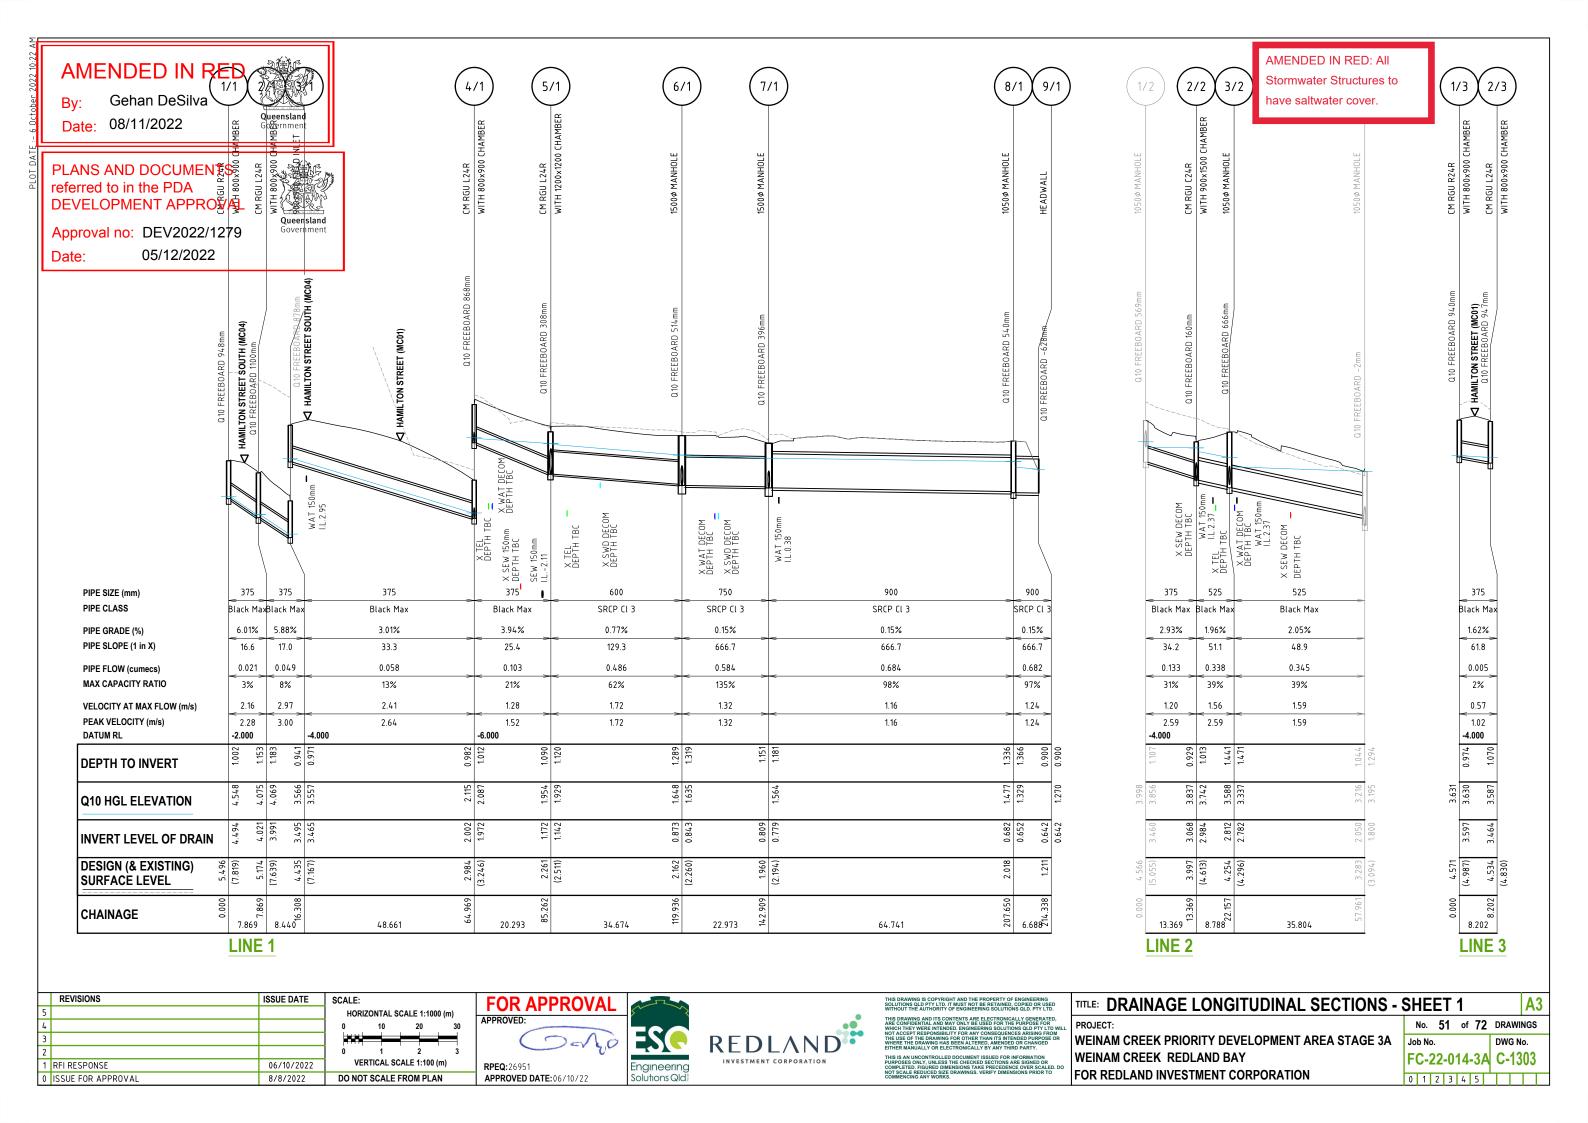

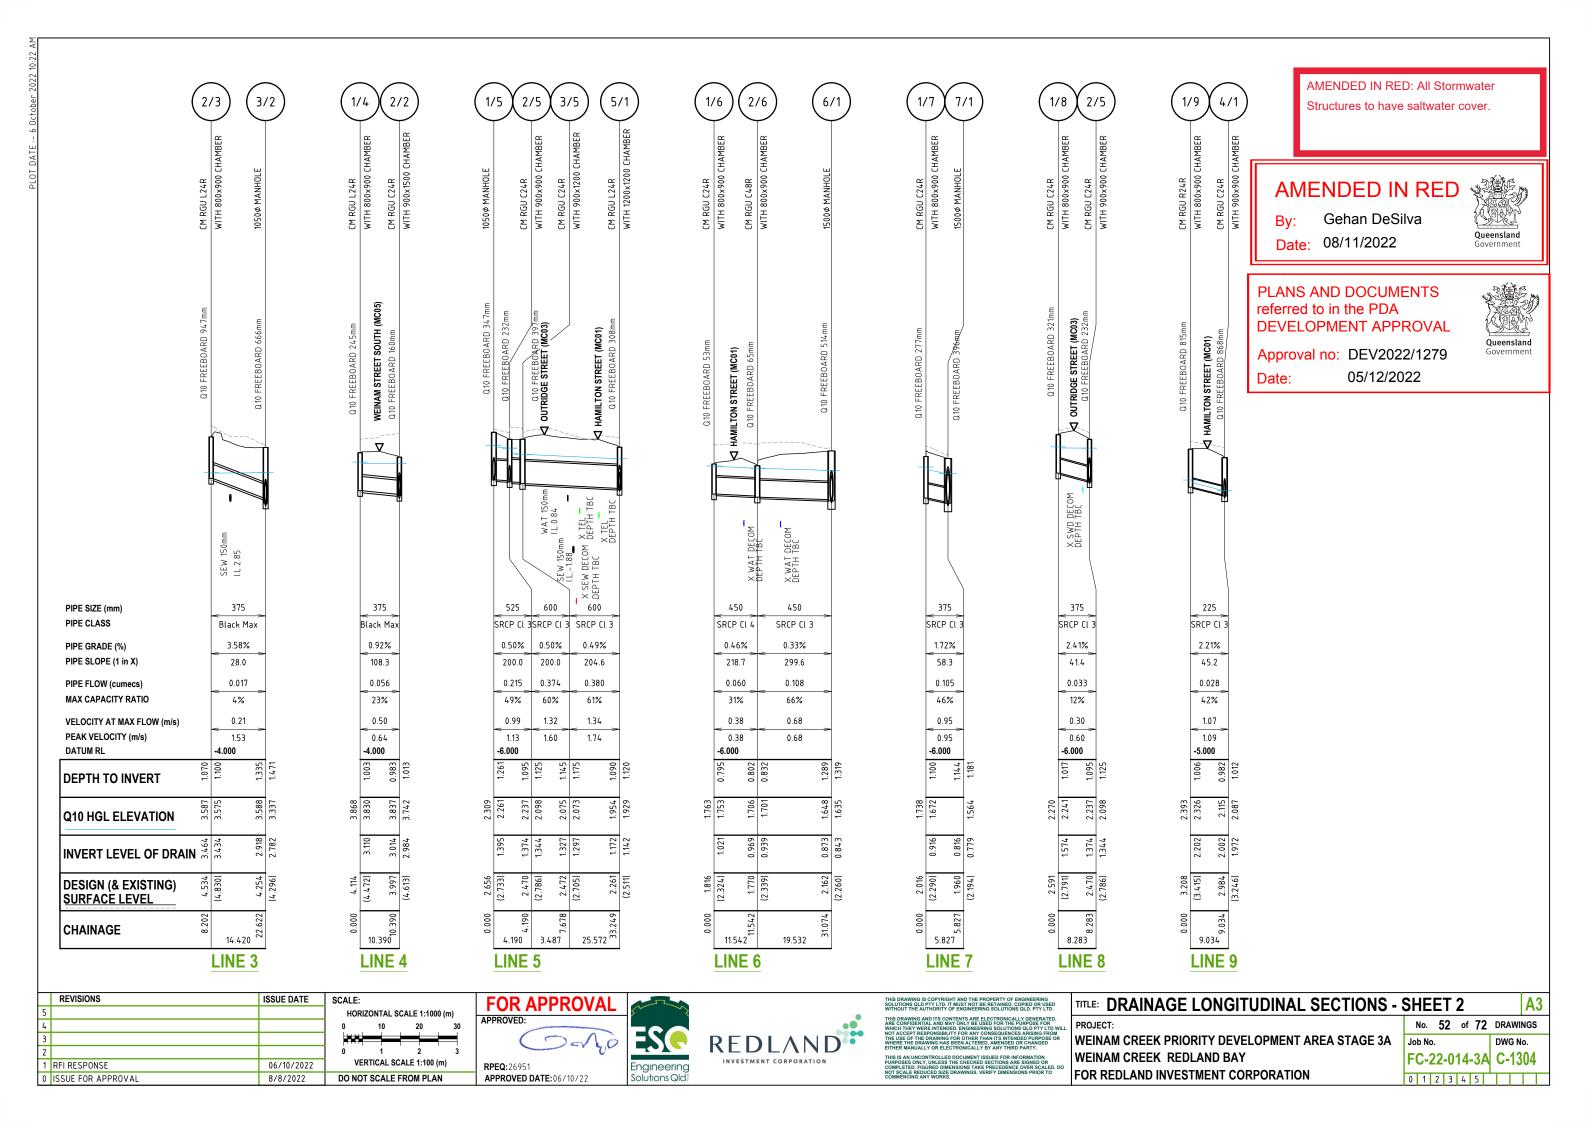

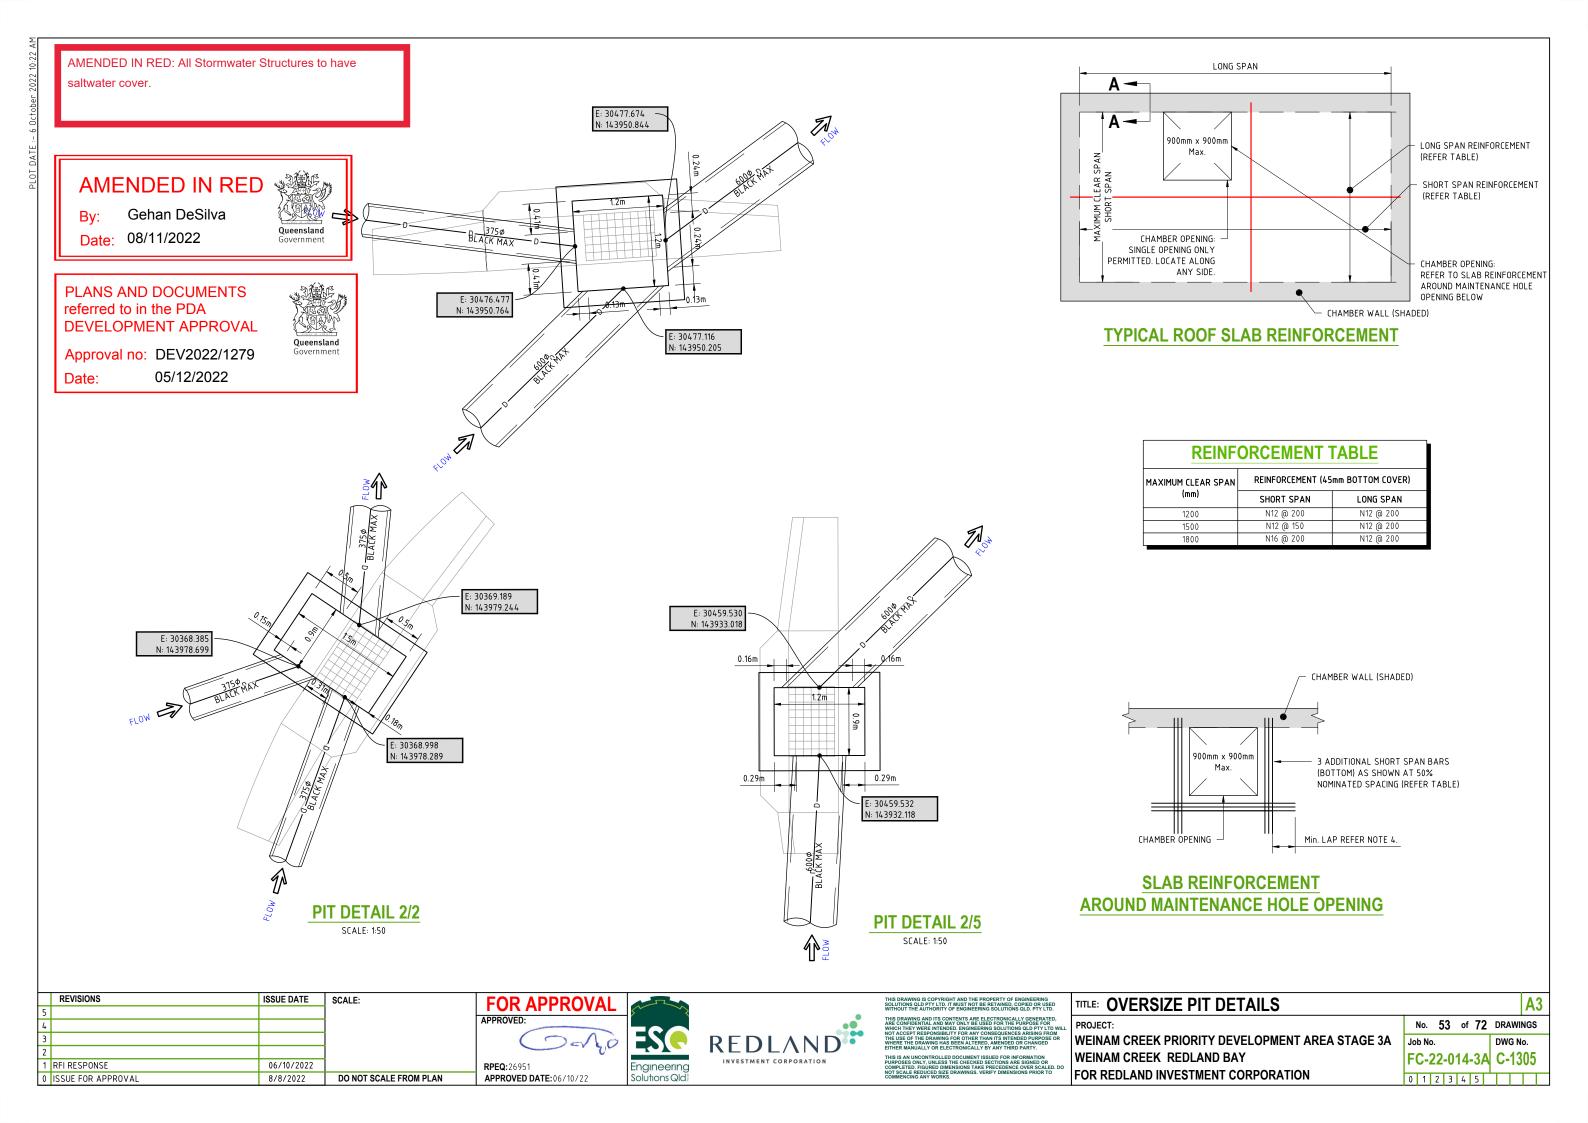

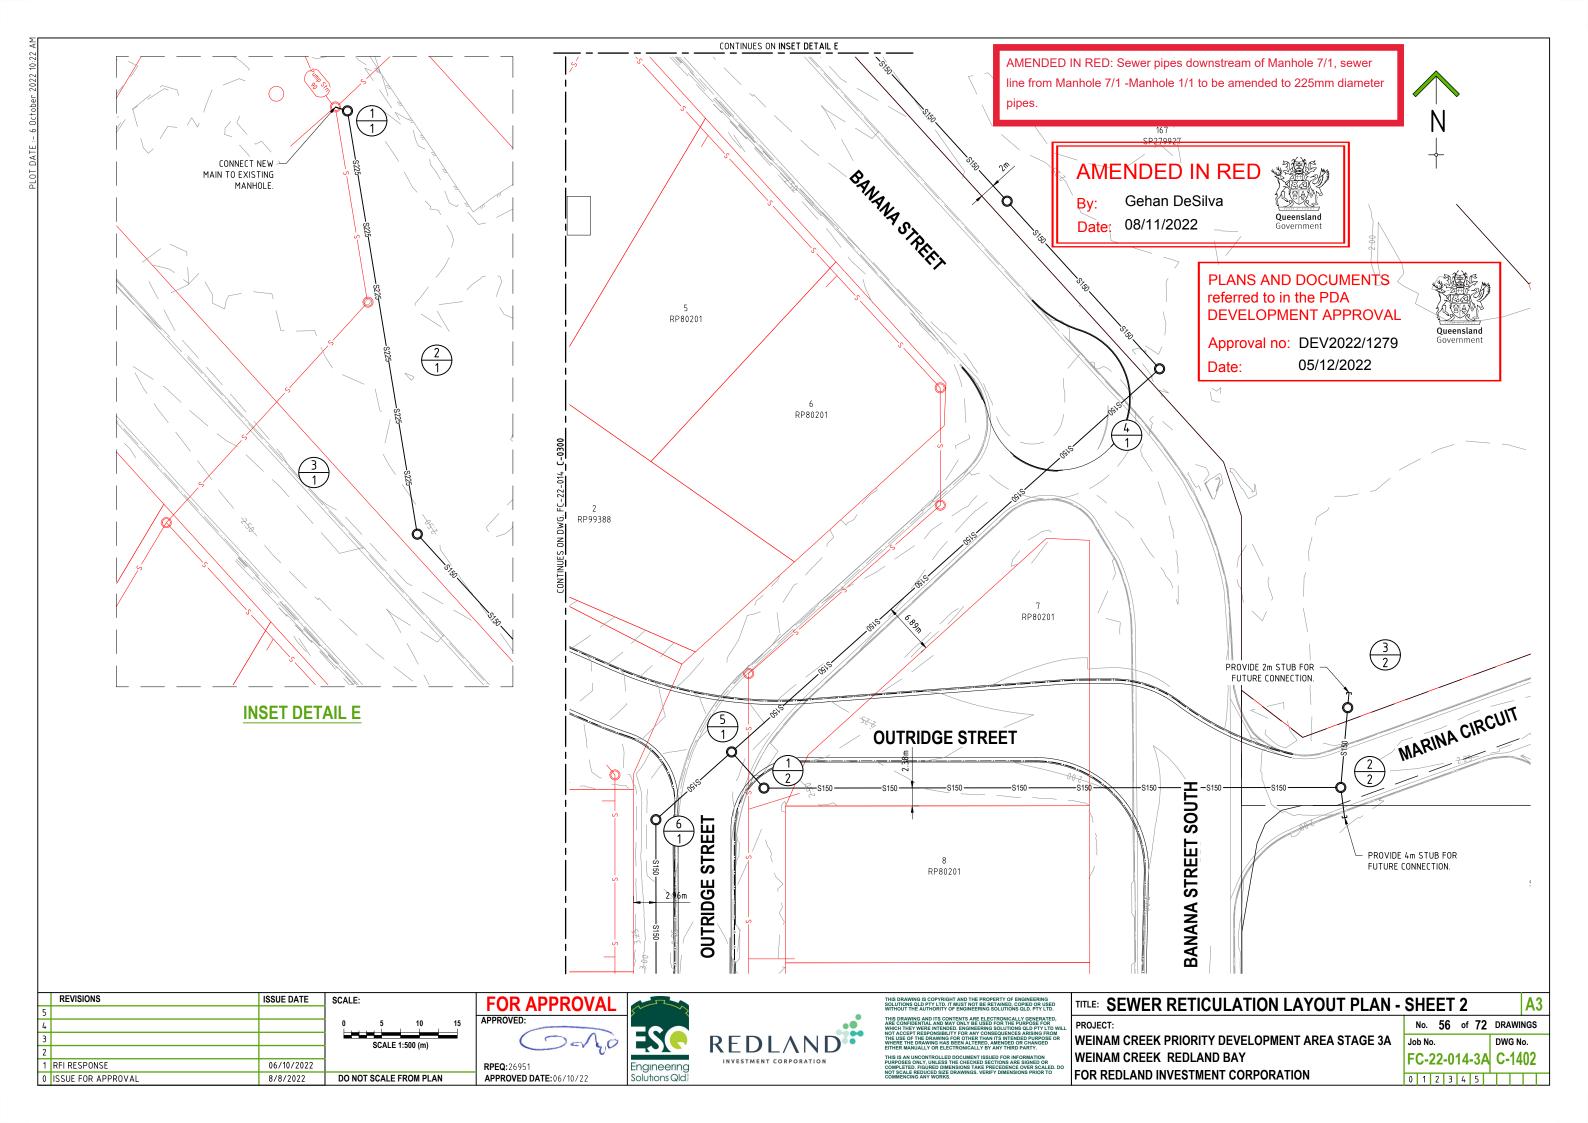

7/1 2/1 3/1 1/1 5/1 6/1 MANHOLE 1/1 to be amended to 225mm diameter pipes. JUNCTION NAME AMENDED IN RED -NE ANGLE DFLECTION Gehan DeSilva HOUSE CONNECTION TYPE Date: 08/11/2022 DOWNSTREAM DISTANCE B D.I. B .:. B ... D .:. LID TYPE PLANS AND DOCUMENTS DROP TYPE 0.03 0.03 0.03 0.03 0.03 0.03 0.03 referred to in the PDA **DEVELOPMENT APPROVAL** HAMILTON STREET (MC01) OUTRIDGE STREET (MC03) Approval no: DEV2022/1279 05/12/2022 Date: D WAT150m I.L.2.02 D SWD375m I.L.1.42 BREAK IN & CONNECT PROVIDE 2.0m STUB FOR FUTURE CONNECTION. TO EXISTING MANHOLE PIPE SIZE (mm) 225 150 150 150 150 150 PP SN8 PIPE CLASS PP SN8 PIPE GRADE (%) 0.333% 0.333% 0.556% 0.556% _0.556% 0.556% PIPE SLOPE (1 in x) 300.299 179.851 300.297 300.302 179.856 179.857 179.860 179.857 DATUM R.L. -6.000 5.528 DEPTH TO INVERT -3.169 INVERT LEVEL 2.359 EXISTING SURFACE LEVEL 2.359 DESIGN SURFACE LEVEL 137.464 203.836 CHAINAGE 13.439 5 1.674 33.326 22.512 79.952 66.372 21.357 17.087 LINE 1 REVISIONS ISSUE DATE SCALE: **FOR APPROVAL** TITLE: SEWER LONGITUDINAL SECTIONS - SHEET 1 HORIZONTAL SCALE 1:1000 (m) APPROVED: REDLAND

INVESTMENT CORPORATION

Engineering

VERTICAL SCALE 1:100 (m)

DO NOT SCALE FROM PLAN

RPEQ:26951

APPROVED DATE: 06/10/22

06/10/2022

8/8/2022

1 RFI RESPONSE

0 ISSUE FOR APPROVAL

AMENDED IN RED: Sewer pipes downstream of Manhole 7/1, sewer line from Manhole 7/1 -Manhole





WEINAM CREEK PRIORITY DEVELOPMENT AREA STAGE 3A WEINAM CREEK REDLAND BAY FOR REDLAND INVESTMENT CORPORATION

No. 57 of 72 DRAWINGS Job No. DWG No. FC-22-014-3A C-1403 0 1 2 3 4 5

2/2 3/2 JUNCTION NAME H. ANGLE DFLECTION HOUSE CONNECTION TYPE DOWNSTREAM DISTANCE D.I. LID TYPE DROP TYPE 0.03 1.45 0.10 BANANA STREET SOUTH (MC02) HAMILTON STREET (MC01) ⇗ D WAT1 I.L.1.65 _150_ PIPE SIZE (mm) 150 150 PIPE CLASS ūΡVĆ uPVC uPVC 3,173% 1.000% PIPE GRADE (%) 1.000% PIPE SLOPE (1 in x) 31.519 99.959 100.004 -6.000 DATUM R.L. 2.987 **DEPTH TO INVERT** -2.049 -0.397 0.396 INVERT LEVEL .621 EXISTING SURFACE LEVEL DESIGN SURFACE LEVEL CHAINAGE 6.389 76.333 18.293 LINE 2

(2/X7 (4/X7 < 2.81 HAMILTON 1 STREET (MC01) WEINAM STREET 1 NORTH (MC06 BREAK IN & CONNECT TO EXISTING MANHOLE. RAISE MANHOLE TO MATCH DESIGN SURFACE LEVEL. BREAK IN & CONNECT TO EXISTING MANHOLE. 150 PP SN8 3.460% 28.904 -4.000 1.780 43.356 LINE 3

REVISIONS ISSUE DATE SCALE: HORIZONTAL SCALE 1:1000 (m) VERTICAL SCALE 1:100 (m) 1 RFI RESPONSE 06/10/2022 0 ISSUE FOR APPROVAL 8/8/2022 DO NOT SCALE FROM PLAN

FOR APPROVAL APPROVED:







TITLE: SEWER	I UNCITIDINAL	SECTIONS - SHEET 2	2

WEINAM CREEK PRIORITY DEVELOPMENT AREA STAGE 3A WEINAM CREEK REDLAND BAY FOR REDLAND INVESTMENT CORPORATION

 	_				
No.	58	of	72	DRAWI	NGS
Job No				DWG N	lo.
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Queensland

PLANS AND DOCUMENTS

DEVELOPMENT APPROVAL

Approval no: DEV2022/1279


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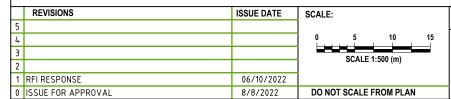
referred to in the PDA

Date:

A3

WATER RETICULATION LIVE WORKS TABLE					
No.	DESCRIPTION	DIA.	LOCATION		
1	REDLAND WATER TO EXCAVATED TO NEW WATERMAIN PREVIOUSLY CONSTRUCTED BY CONTRACTOR AND REMOVED DEAD END CAP AND THEN CONNECTED TO EXISTING 150¢ WATERMAIN, INCLUDING INSTALLATION OF REQUIRED FITTINGS. REDLAND WATER TO BACKFILLED WATERMAIN INCLUDING TEMPORARY SURFACE RESTORATION.	150	ROAD RESERVE HAMILTON STREET ADJACENT LOT 1 ON 169111		
2	REDLAND WATER TO EXCAVATED TO NEW WATERMAIN PREVIOUSLY CONSTRUCTED BY CONTRACTOR AND REMOVED DEAD END CAP AND THEN CONNECTED TO EXISTING 150\$ WATERMAIN, INCLUDING INSTALLATION OF REQUIRED FITTINGS. REDLAND WATER TO BACKFILLED WATERMAIN INCLUDING TEMPORARY SURFACE RESTORATION.	150	ROAD RESERVE WEINAM STREET ADJACENT LOT 1 ON 169111		
3	REDLAND WATER TO EXCAVATED TO NEW WATERMAIN PREVIOUSLY CONSTRUCTED BY CONTRACTOR AND REMOVED DEAD END CAP AND THEN CONNECTED TO EXISTING 150¢ WATERMAIN, INCLUDING INSTALLATION OF REQUIRED FITTINGS. REDLAND WATER TO BACKFILLED WATERMAIN INCLUDING TEMPORARY SURFACE RESTORATION.	150	ROAD RESERVE WEINAM STREET NORTH ADJACENT LOT 2 ON RP80201		
4	REDLAND WATER TO EXCAVATED TO NEW WATERMAIN PREVIOUSLY CONSTRUCTED BY CONTRACTOR AND REMOVED DEAD END CAP AND THEN CONNECTED TO EXISTING 150¢ WATERMAIN, INCLUDING INSTALLATION OF REQUIRED FITTINGS. REDLAND WATER TO BACKFILLED WATERMAIN INCLUDING TEMPORARY SURFACE RESTORATION.	150	ROAD RESERVE HAMILTON STREET SOUTH ADJACENT LOT 8 ON RP107394		
5	REDLAND WATER TO EXCAVATED TO NEW WATERMAIN PREVIOUSLY CONSTRUCTED BY CONTRACTOR AND REMOVED DEAD END CAP AND THEN CONNECTED TO EXISTING 150¢ WATERMAIN, INCLUDING INSTALLATION OF REQUIRED FITTINGS. REDLAND WATER TO BACKFILLED WATERMAIN INCLUDING TEMPORARY SURFACE RESTORATION.	150	ROAD RESERVE OUTRIDGE STREET ADJACENT LOT 26 ON RP80201		
6	REDLAND WATER TO EXCAVATED TO NEW WATERMAIN PREVIOUSLY CONSTRUCTED BY CONTRACTOR AND REMOVED DEAD END CAP AND THEN CONNECTED TO EXISTING 150¢ WATERMAIN, INCLUDING INSTALLATION OF REQUIRED FITTINGS. REDLAND WATER TO BACKFILLED WATERMAIN INCLUDING TEMPORARY SURFACE RESTORATION.	150	ROAD RESERVE BANANA STREET NORTH ADJACENT LOT 6 ON RP80201		
7	REDLAND WATER TO EXCAVATED TO NEW WATERMAIN PREVIOUSLY CONSTRUCTED BY CONTRACTOR AND REMOVED DEAD END CAP AND THEN CONNECTED TO EXISTING 150¢ WATERMAIN, INCLUDING INSTALLATION OF REQUIRED FITTINGS. REDLAND WATER TO BACKFILLED WATERMAIN INCLUDING TEMPORARY SURFACE RESTORATION.	150	ROAD RESERVE BANANA STREET SOUTH ADJACENT LOT 9 ON RP80201		



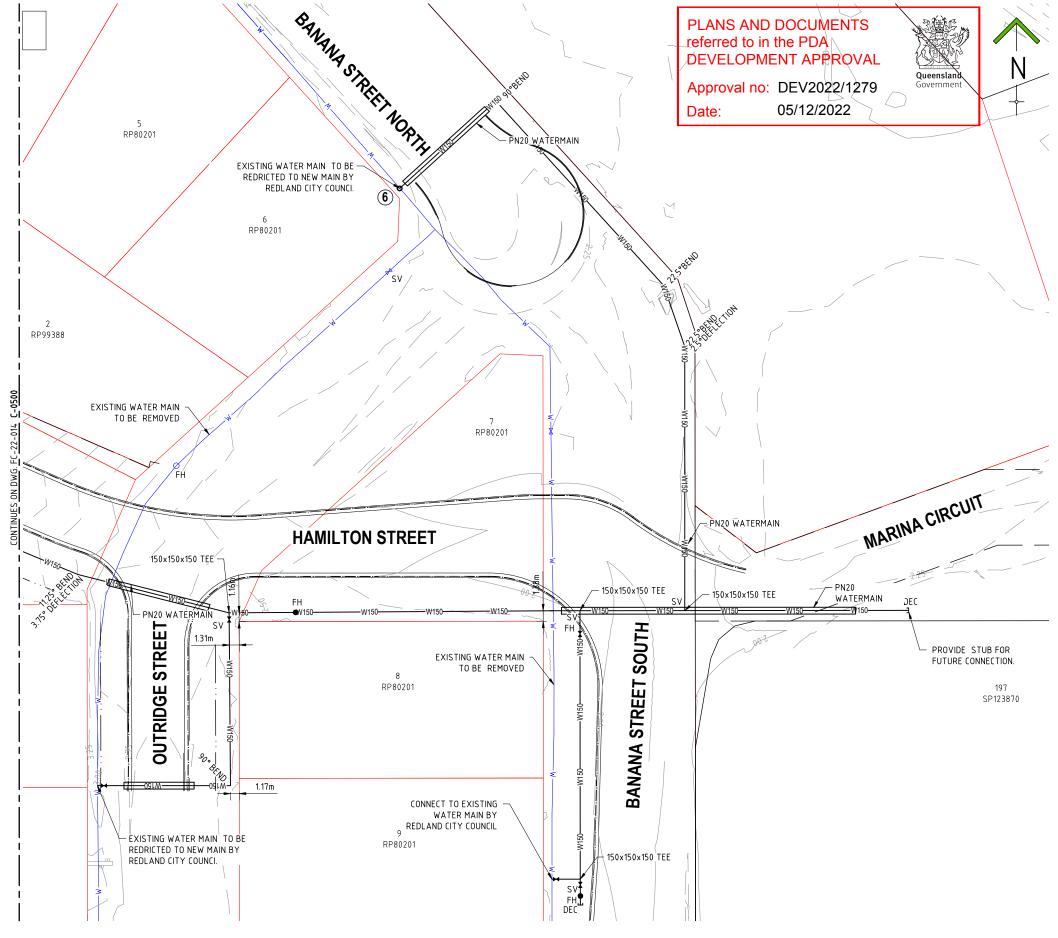

APPROVAL

APPROVED:

RPEQ:26951
APPROVED DATE:06/10/22





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ECT:

WEINAM CREEK PRIORITY DEVELOPMENT AREA STAGE 3A
WEINAM CREEK REDLAND BAY
FOR REDLAND INVESTMENT CORPORATION

No. 60 of 72 DRAWINGS

Job No. DWG No.

FC-22-014-3A C-1501

0 | 1 | 2 | 3 | 4 | 5 |



Appendix E 'Dial Before You Dig' (DBYD) Information



Ener Qu	gy SYIVIBOLOGY eensland LEGEND
Ť	Cross Bonding Link Box - Critical
	Disconnect Box - Critical
	Ring Main Unit
	Distribution Pad Substation
Ť	Earth
\$	Remote Earth
M	Cable Marker
0	Handhole
0	Manhole
GI	Commercial Industrial Pillar
	Distribution Cabinet
	Link Pillar
	Service Pillar
\blacksquare	Feeder Pillar
0	Pole
⊛	Streetlight Column
	Communication Junction Pillar
8	Communication Pit
\$	Fibre Patch Panel
\$	Pilot Cubicle
	Underground Asset 33kV and above Underground Asset below 33kV
<u></u>	Underground Conduit with or without cable Pit
	Communication Boundary
	Reserve (RE)
	Water Resource (WR)
	Cadastral Parcels
	Planned Jointing Pit – New/Updated
	Planned Jointing Pit - Remove

Planned Communication Boundary - Remove


Planned Tunnel/Trench/Bore - New/Updated


Planned Tunnel/Trench/Bore - Remove




Planned Cross Bonding Link Box - New/Updated

÷

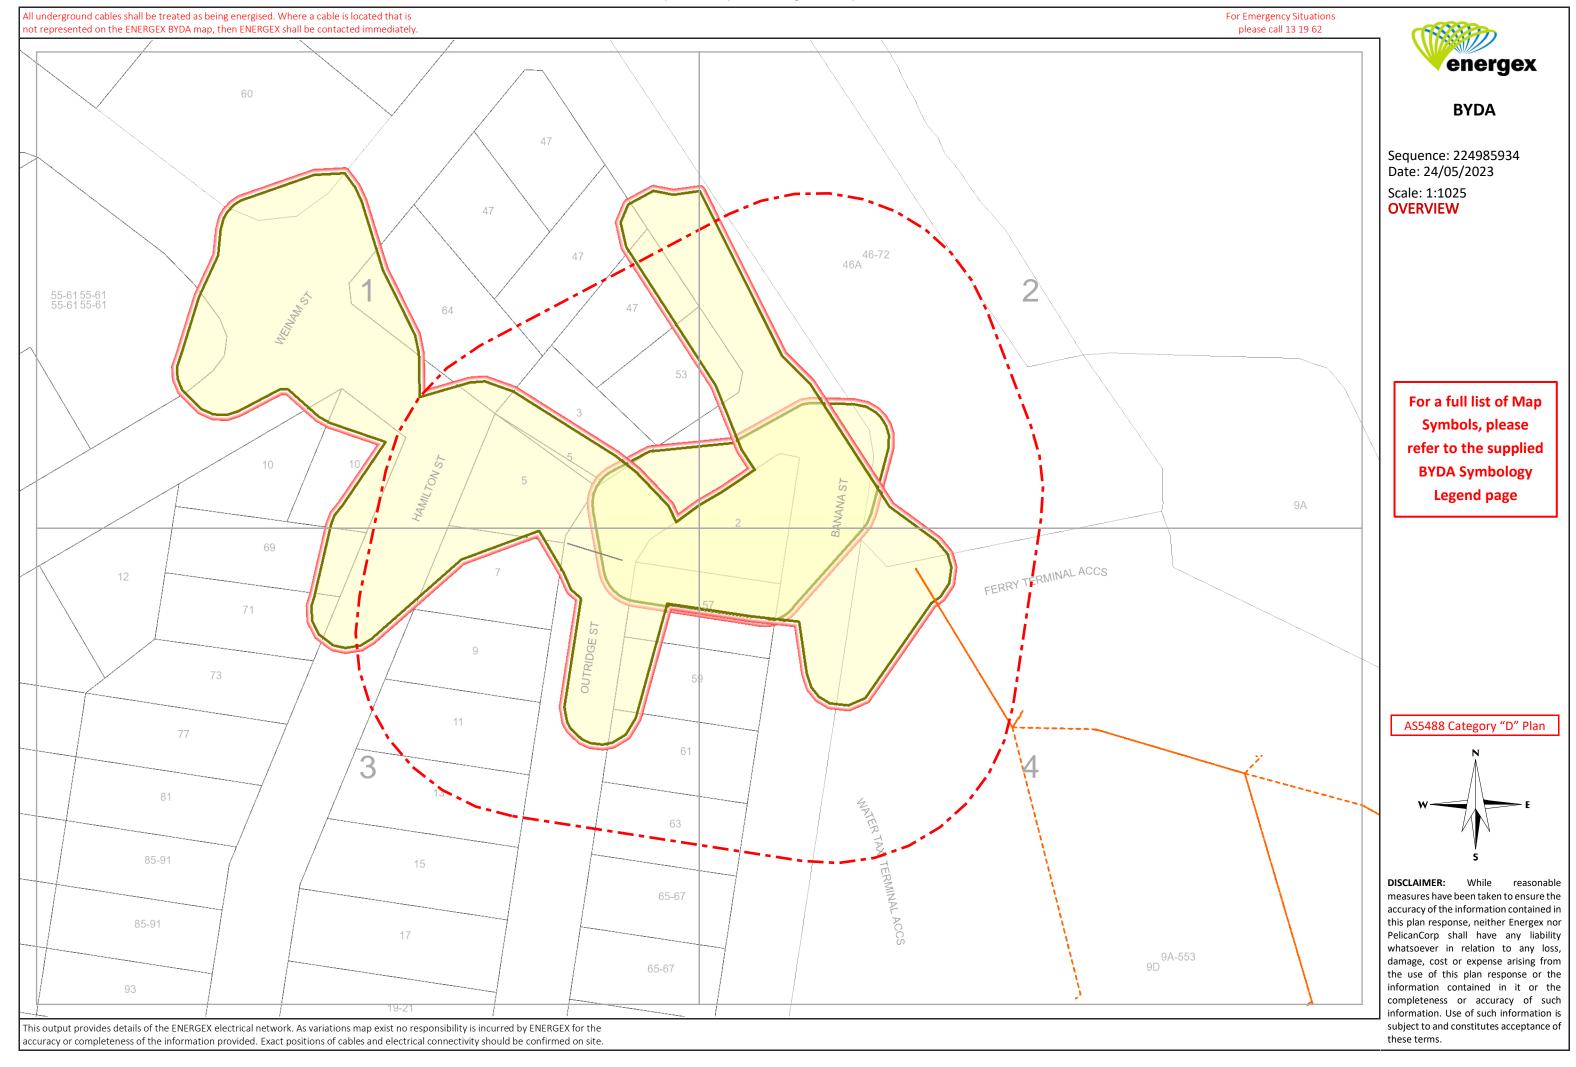

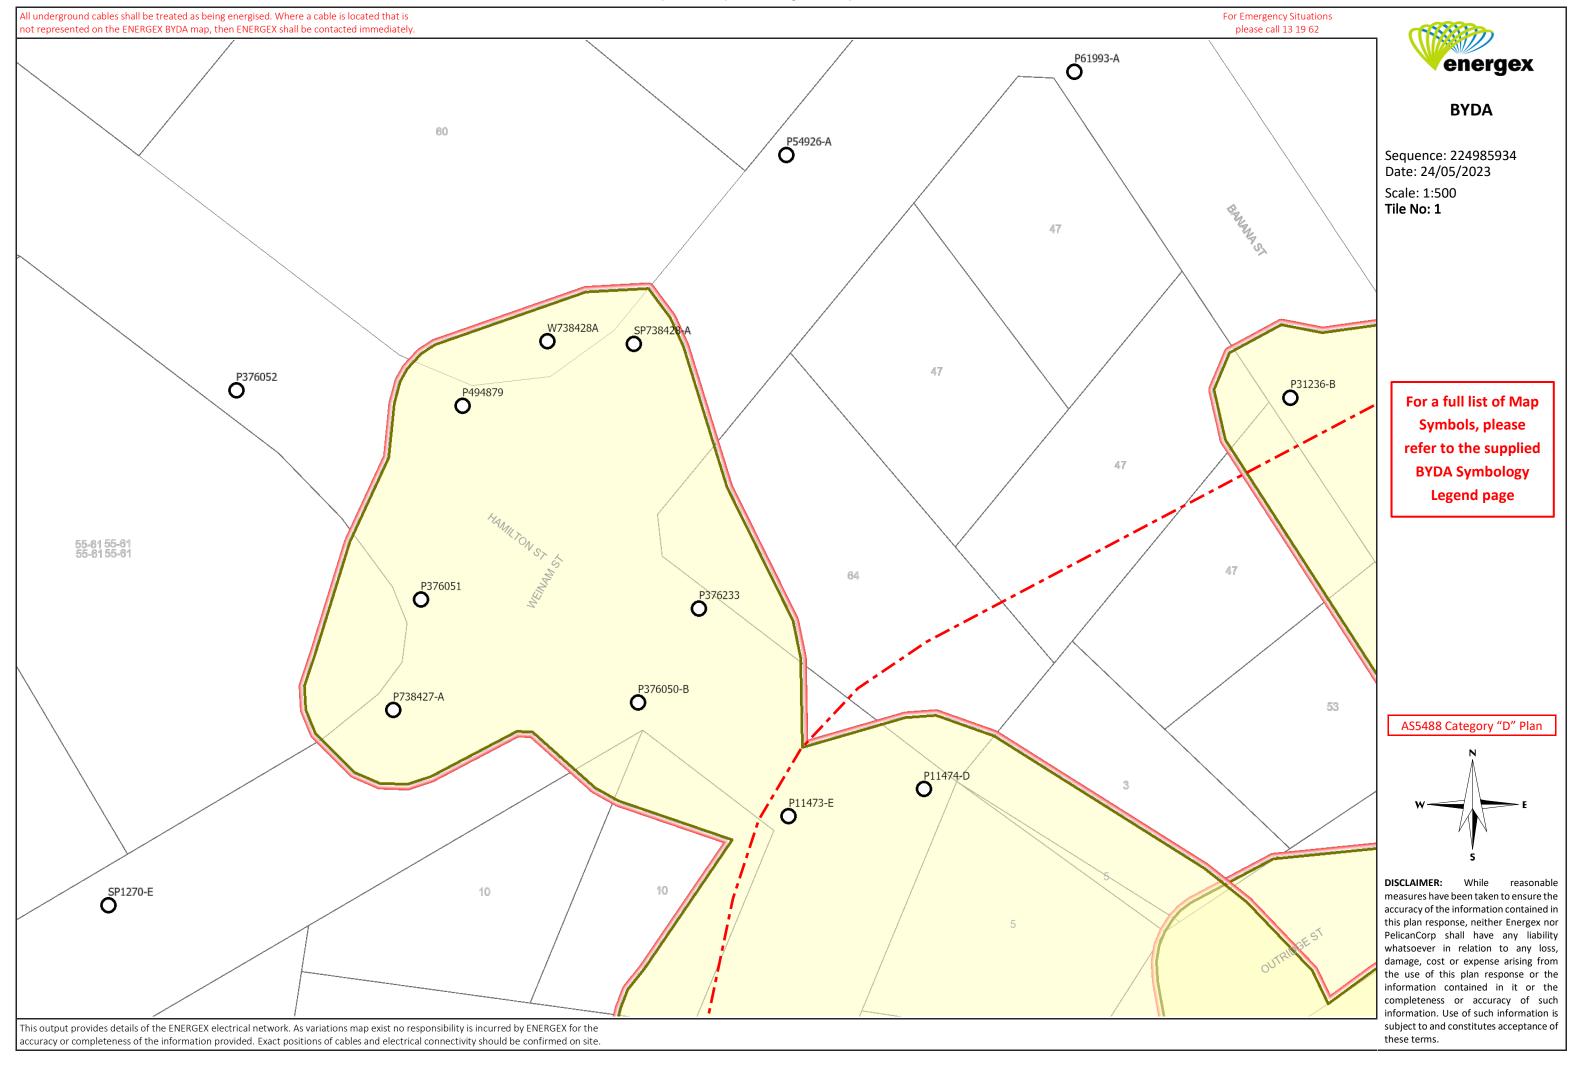

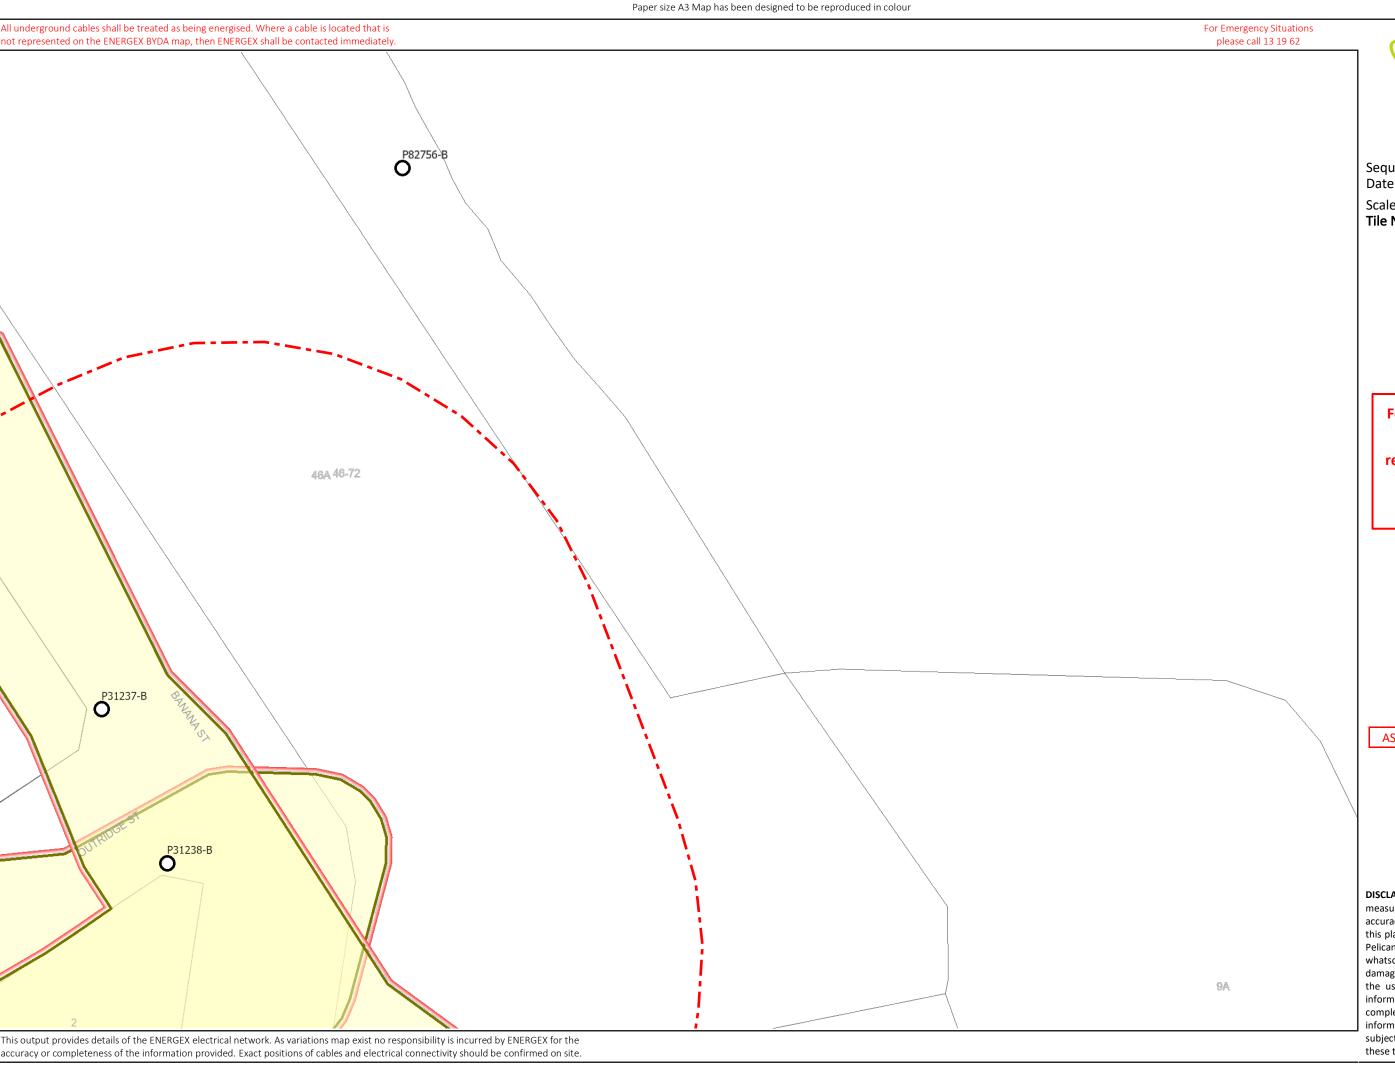

BYDA

Sequence: 224985934 Date: 24/05/2023


Scale: 1:500 Tile No: 2


> For a full list of Map Symbols, please refer to the supplied BYDA Symbology Legend page

AS5488 Category "D" Plan



DISCLAIMER: While reasonable measures have been taken to ensure the accuracy of the information contained in this plan response, neither Energex nor PelicanCorp shall have any liability whatsoever in relation to any loss, damage, cost or expense arising from the use of this plan response or the information contained in it or the completeness or accuracy of such information. Use of such information is subject to and constitutes acceptance of these terms.

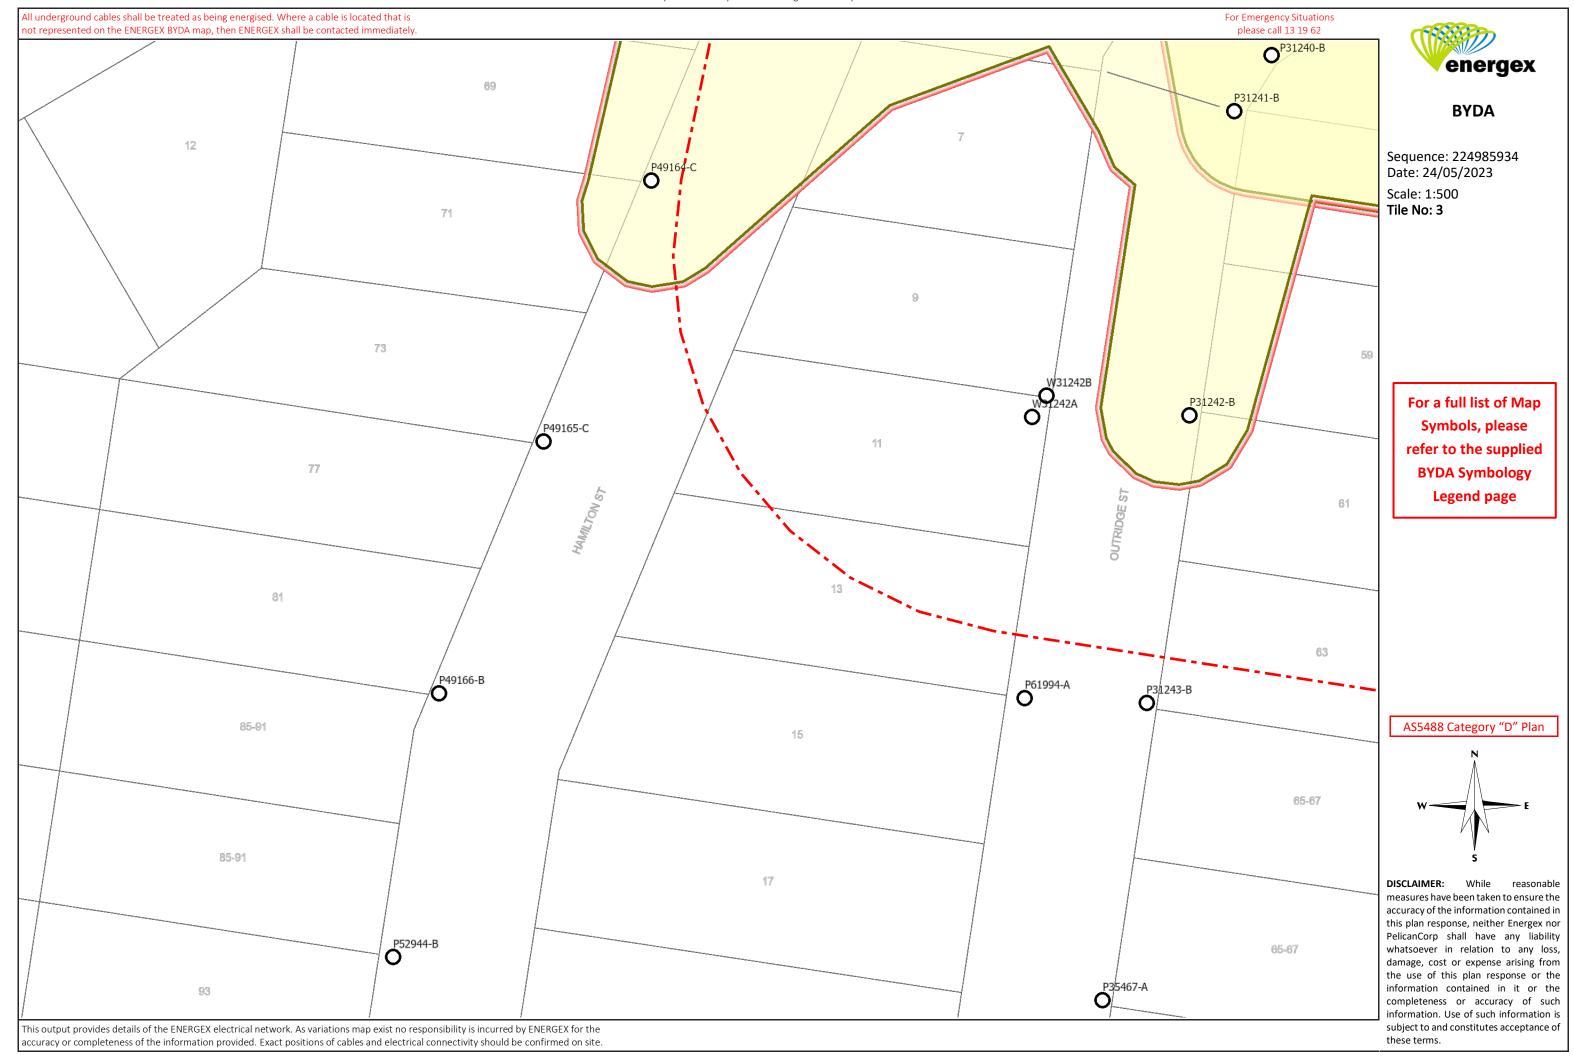


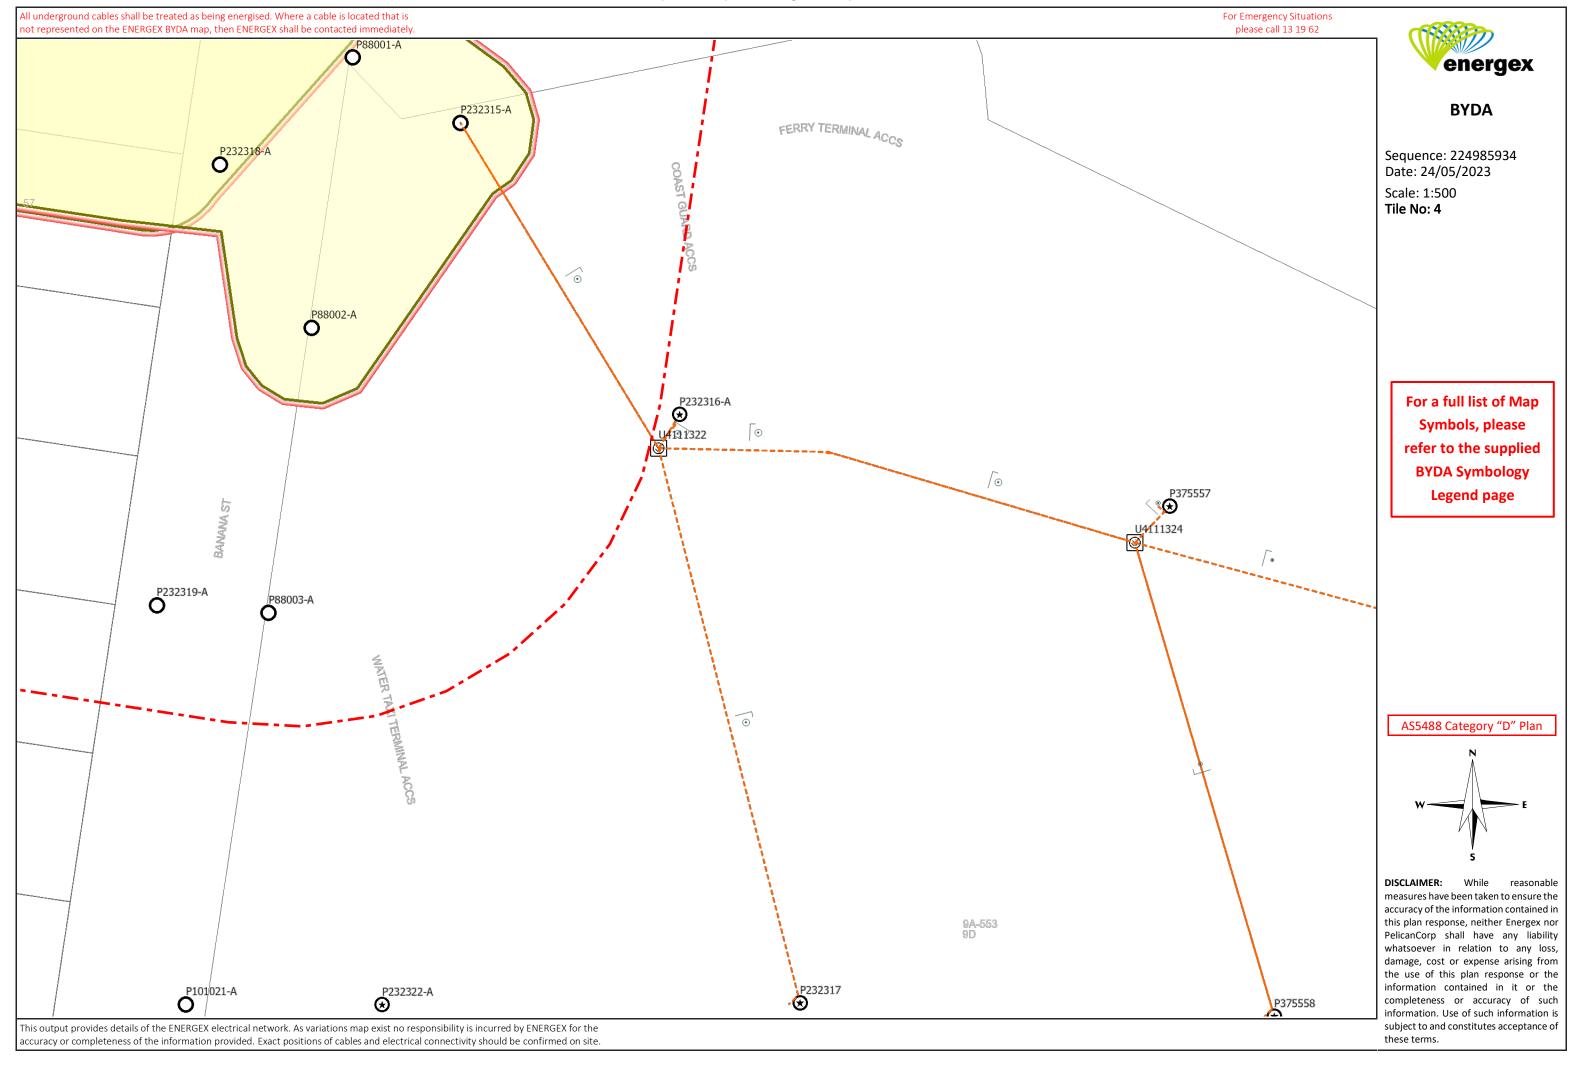

LEGEND




For more info contact a Certified Locating Organisation or Telstra Plan Services 1800 653 935

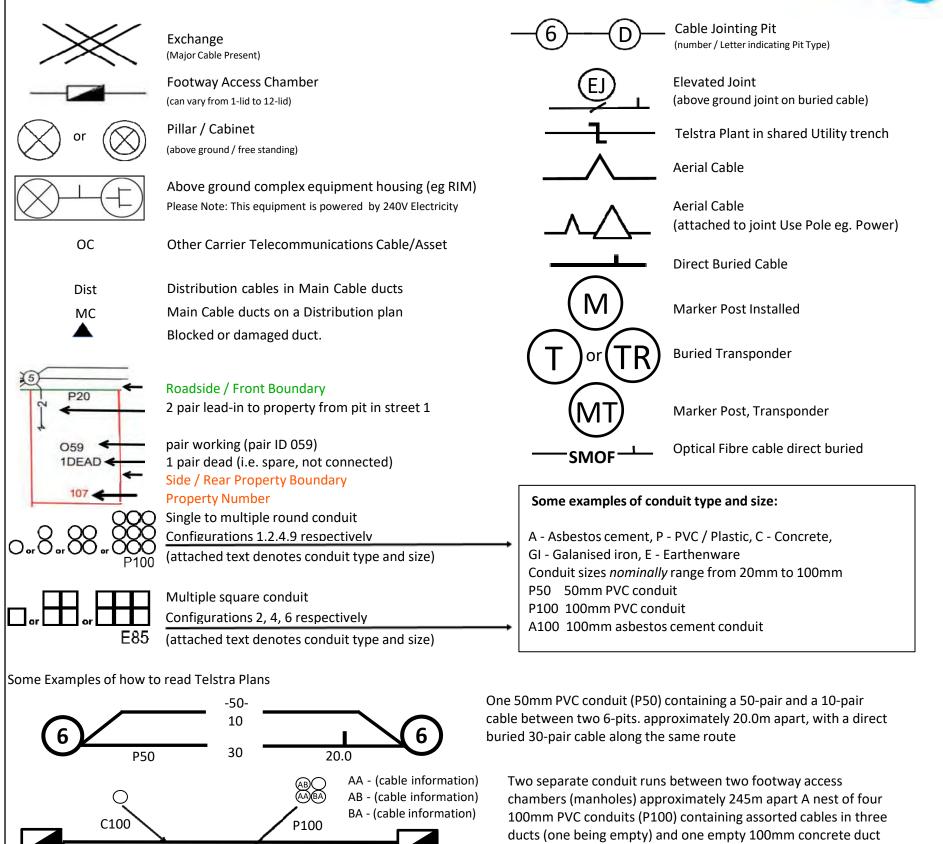

WARNING: Telstra plans and location information conform to Quality Level 'D' of the Australian Standard AS 5488 - Classification of Subsurface Utility Information. As such, Telstra supplied location information is indicative only. Spatial accuracy is not applicable to Quality Level D. Refer to AS 5488 for further details. Telstra does not warrant or hold out that its plans are accurate and accepts no responsibility for any inaccuracy shown on the plans. FURTHER ON SITE INVESTIGATION IS REQUIRED TO VALIDATE THE EXACT LOCATION OF TELSTRA PLANT PRIOR TO COMMENCING CONSTRUCTION WORK. A plant location service is an essential part of the process to validate the exact location of Telstra assets and to ensure the assets are protected during construction works. The exact position of Telstra assets can only be validated by physically exposing them. Telstra will seek compensation for damages caused to its property and losses caused to Telstra and its customers.

245.0

(C100) along

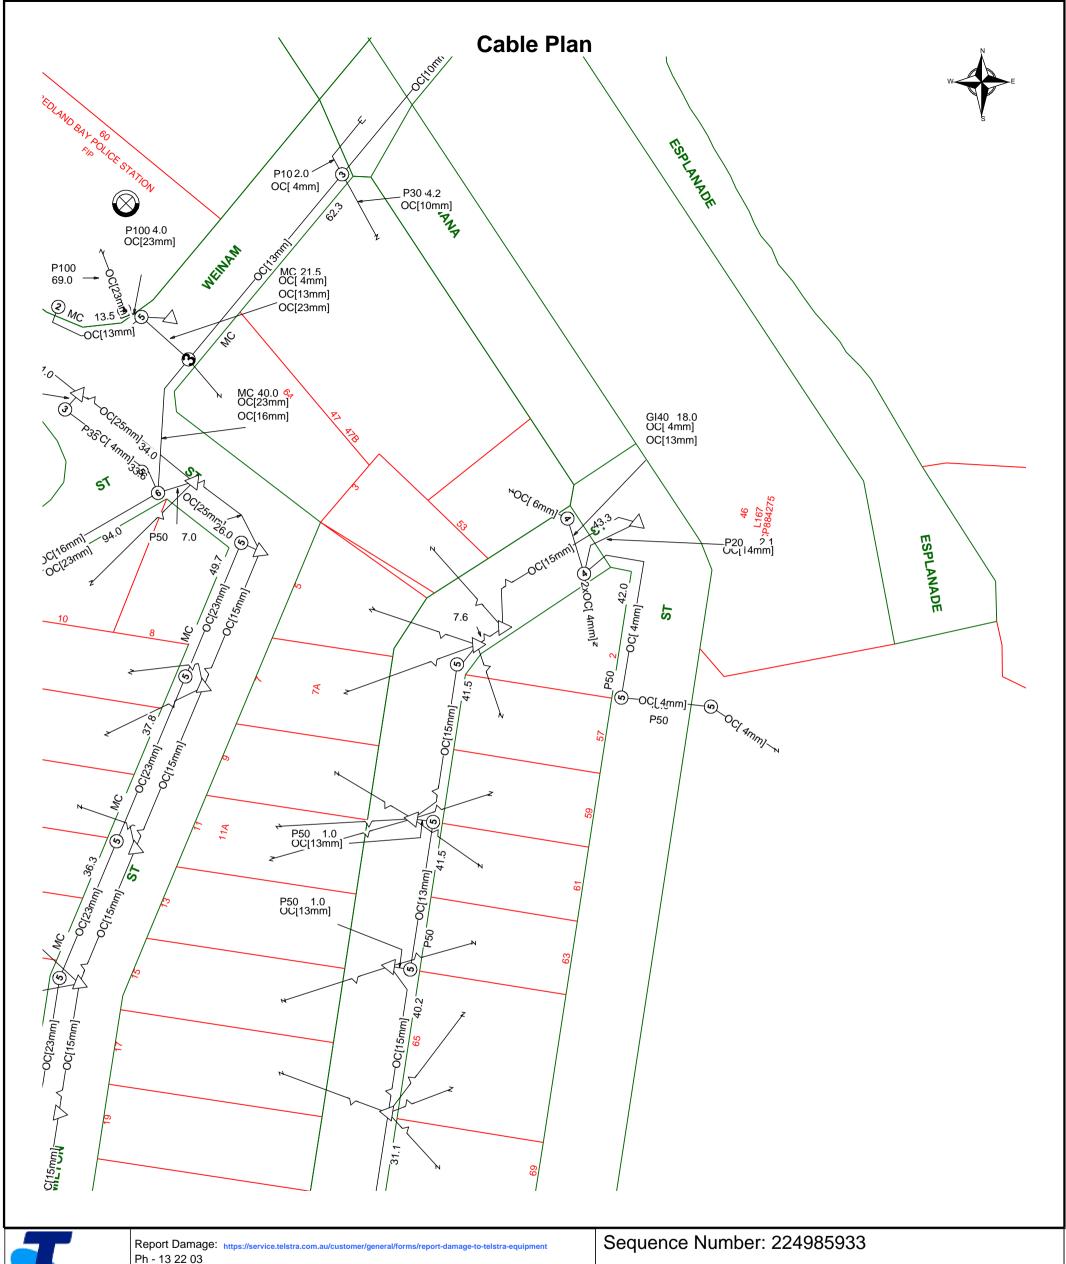

Email - Telstra.Plans@team.telstra.com

Planned Services - ph 1800 653 935 (AEST bus hrs only) General Enquiries

TELSTRA LIMITED A.C.N. 086 174 781

Generated On 24/05/2023 08:24:56

CAUTION: Fibre optic and/ or major network present in plot area. Please read the Duty of Care and contact Telstra Plan Services should you require any assistance.

The above plan must be viewed in conjunction with the Mains Cable Plan on the following page

WARNING

Telstra plans and location information conform to Quality Level "D" of the Australian Standard AS 5488-Classification of Subsurface Utility Information.


As such, Telstra supplied location information is indicative only. Spatial accuracy is not applicable to Quality Level D.

Refer to AS 5488 for further details. The exact position of Telstra assets can only be validated by physically exposing it. Telstra does not warrant or hold out that its plans are accurate and accepts no responsibility for any inaccuracy.

Further on site investigation is required to validate the exact location of Telstra plant prior to commencing construction work.

A Certified Locating Organisation is an essential part of the process to validate the exact location of Telstra assets and to ensure the asset is protected during construction works.

See the Steps- Telstra Duty of Care that was provided in the email response.

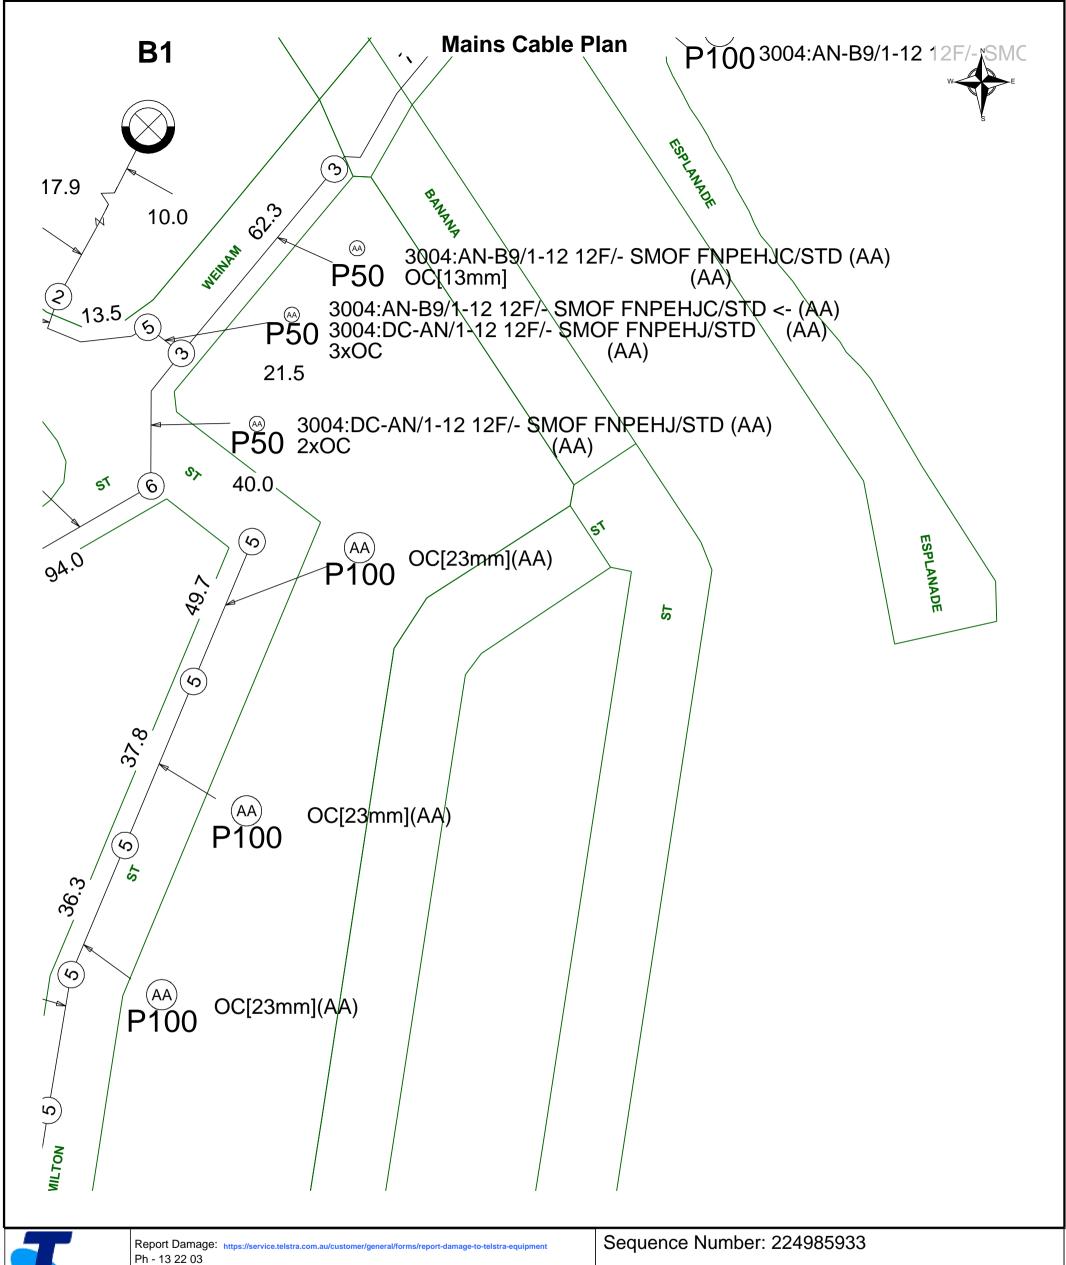

Email - Telstra.Plans@team.telstra.com

Planned Services - ph 1800 653 935 (AEST bus hrs only) General Enquiries

TELSTRA LIMITED A.C.N. 086 174 781

Generated On 24/05/2023 08:24:57

CAUTION: Fibre optic and/ or major network present in plot area. Please read the Duty of Care and contact Telstra Plan Services should you require any assistance.

WARNING

Telstra plans and location information conform to Quality Level "D" of the Australian Standard AS 5488-Classification of Subsurface Utility Information.

As such, Telstra supplied location information is indicative only. Spatial accuracy is not applicable to Quality Level D.


Refer to AS 5488 for further details. The exact position of Telstra assets can only be validated by physically exposing it.

Telstra does not warrant or hold out that its plans are accurate and accepts no responsibility for any inaccuracy. Further on site investigation is required to validate the exact location of Telstra plant prior to commencing construction work.

A Certified Locating Organisation is an essential part of the process to validate the exact location of Telstra assets and to ensure the asset is protected during construction works.

See the Steps- Telstra Duty of Care that was provided in the email response.

- -	LEGEND nbn (i)		
34	Parcel and the location		
3	Pit with size "5"		
(2E)	Power Pit with size "2E". Valid PIT Size: e.g. 2E, 5E, 6E, 8E, 9E, E, null.		
	Manhole		
\otimes	Pillar		
PO - T- 25.0m P40 - 20.0m	Cable count of trench is 2. One "Other size" PVC conduit (PO) owned by Telstra (-T-), between pits of sizes, "5" and "9" are 25.0m apart. One 40mm PVC conduit (P40) owned by NBN, between pits of sizes, "5" and "9" are 20.0m apart. 2 Direct buried cables between pits of sizes, "5" and "9" are 10.0m apart. Trench containing any INSERVICE/CONSTRUCTED (Copper/RF/Fibre) cables.		
3 1 9			
-00-			
-0-0-	Trench containing only DESIGNED/PLANNED (Copper/RF/Fibre/Power) cables.		
-0-0-	Trench containing any INSERVICE/CONSTRUCTED (Power) cables.		
BROADWAY ST	Road and the street name "Broadway ST"		
Scale	0 20 40 60 Meters 1:2000 1 cm equals 20 m		

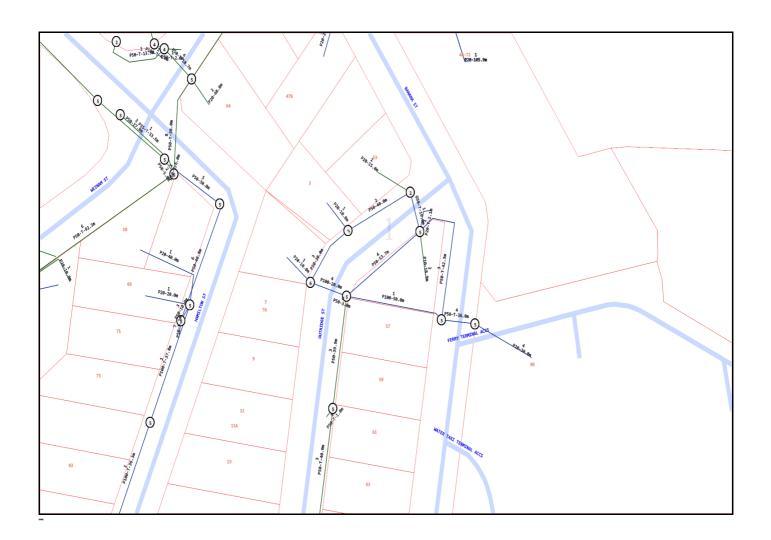

Emergency Contacts

You must immediately report any damage to the **nbn**[™] network that you are/become aware of. Notification may be by telephone - 1800 626 329.

Brisbane

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Phone: 1300 657 402 Email: info@adgce.com

Southport, QLD 4215

Melbourne

321 / 838 Collins Street Docklands, VIC 3008

Postal: GPO Box 2422

Darwin NT 0801

info@adgce.com

Hobart

92-96 Argyle Street Hobart TAS 7000

Phone: 1300 657 402 Email: info@adgce.com

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Toowoomba

Tenancy 8, 158 Margaret Street Toowoomba QLD 4350, Australia

Phone: 1300 657 402 Email: info@adgce.com

Ever-mindful of the role we play in shaping places, people, and communities, we are proud to lead strong, best-practice solutions that create a positive legacy for the future.

Driven by passion and vision, courage, and optimism, we truly believe that no project or challenge is beyond us. At ADG, we design with purpose, to make a difference.



