



#### **DOCUMENT VERIFICATION**

Job Title Bella Baia

Job Number 26164

Document Title Stormwater Management Plan

#### **DOCUMENT CONTROL**

Date	Document / Description	Revision No.	Author	Reviewer
18.07.22	Stormwater Management Plan	00	M Klein	K Griffin
07.07.23	Updated Site Layout	01	M Brown	D Saul
21.07.23	Issused for Approval	02	M Brown	D Saul
04.08.23 Updated Architectural Plans		03	M Brown	D Saul

#### **APPROVAL FOR ISSUE**

Name	Signature	Date
Matthew Brown	Men	04.08.23
Michael Lepelaar (RPEQ: 11171)	My	04.08.23

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#### **EXECUTIVE SUMMARY**

ADG Engineers (Aust.) Pty Ltd has been engaged by Fortezza Group to prepare a Stormwater Management Plan suitable for submission to Economic Development Queensland in support of a Development Application for a proposed residential apartment development, which is named Bella Baia and is located within the Weinam Creek Priority Development Area at 57 Banana Street, Redland Bay 4165 QLD.

This Stormwater Management Plan has been revised following changes to the site layout and the commencement of roadworks and service relocation surrounding the site, which necessitate modification to the stormwater management strategy.

This report aims to assess the proposed development requirements with relation to both stormwater quantity and quality.

A stormwater management plan is required to comply with the Weinam Creek Stormwater Infrastructure Plan, which stipulates in the Healthy Waters Code requirements regarding the removal of gross pollutants, suspended solids, nitrogen and phosphorus to target reduction levels.

The following stormwater quality improvement devices are proposed for the site:

- One (1) Ocean guard Filter;
- Three (3) SPEL Stormfilters (460 PSORB) within in a minimum 3m<sup>2</sup> Stormfilter chamber; and
- A grass-lined swale.

In accordance with the Weinam Creek Priority Development Area Stormwater Infrastructure Plan, no stormwater detention is required as the site discharges directly to Moreton Bay.

All relevant standards and guidelines are addressed in this Stormwater Management Plan including criteria from the Council City Plan.



#### 1 INTRODUCTION

#### 1.1 General

ADG Engineers (Aust.) Pty Ltd has been engaged by Fortezza Group to prepare a Stormwater Management Plan (SMP) suitable for submission to Economic Development Queensland (EDQ) in support of a Development Application associated with a proposed residential development named Bella Bai, which is located within the Weinam Creek Priority Development Area (WC PDA) at 57 Banana Street, Redland Bay 4165 QLD, henceforth referred to as *the site*.

This SMP has been revised following changes to the site layout and the commencement of roadworks and service relocation surrounding the site, which necessitate modification to the stormwater management strategy.

The development consists of a multi-storey apartment building over a basement carpark. This report aims to assess the proposed development requirements with relation to both stormwater quantity and quality.

The purpose of this SMP is to provide advice as to the development proposal detailed in the architectural drawings in **Appendix A**. The works described herein are subject to further approvals and cover works required to service the proposed development with regard to stormwater treatment.

#### 1.2 Background Information

This report was compiled using information from the following sources:

- Architectural plans supplied by HAL Architectects (refer to Appendix A);
- Detailed Surveys (refer to Appendix B);
- EDQ Approved Design Drawings for ongoing Weinam Creek Priority Development Area Stage 3A (refer to **Appendix C**);
- Google Maps and Nearmap Aerial Imagery.

#### 1.3 Property Details

The site is located in Redland Bay, Queensland. The site is bound by existing residential lots to the north and south, Banana Street to the east and Outridge Street to the west. The existing vacant lot to the north of the site has been resumed and roadworks are presently underway that will result in construction of a new road (Hamilton Street) along the northern boundary of the site, as shown in Figure 2.

The land titles that make up the site are given in Table 1. Refer to the detailed surveys in Appendix B for further details. Figure 1 displays the site locality.

Table 1 – Property Detail

Lot Title	Lot 8 on RP80201
Street Address	57 Banana Street, Redland Bay 4165 QLD
Site Area	835m²



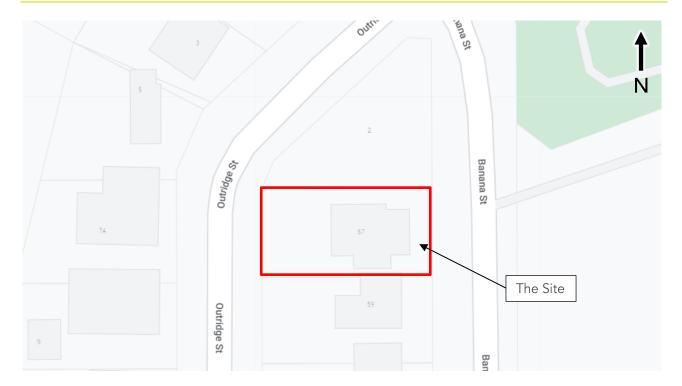


Figure 1 – Locality Map (Accessed 01.06.2022 from Google Maps)

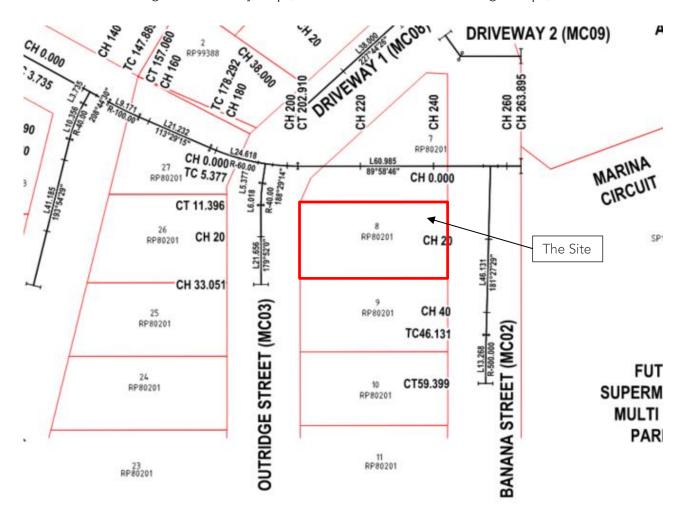


Figure 2 - New Road Alignment (EDQ Design Drawing C-1005[5], dated 06/10/2022)



#### 1.4 Existing Site

The proposed development is located across 57 Banana Street, Redland Bay QLD within the WC PDA and Economic Development Queensland will be the assessing authority. The existing site is occupied by a two-storey detached residential dwelling with surfaces typically grading in the order of 1%. The site is estimated to have a fraction impervious of approximately 50% and the remaining area occupied by landscaping and open space. Figure 3 demonstrates the existing site conditions.



Figure 3 – Site Condition (Nearmap Image dated 22.03.2022)



#### 2 PROPOSED DEVELOPMENT

The proposed development as described in the architectural drawings in **Appendix A** is a multi-storey apartment building over basement carpark. A breakdown of the post-developed surface areas exposed to rainfall is presented in **Table 2**. Refer to SK02 in **Appendix D** for further information.

**Catchment ID Land Type** Area (m²) **Percentage of Total Site Area** Roof 35 4% **B1** Pool 27 3% (Directed into Stormsack upstream 199 24% Landscaping of Stormfilters) Hardstand 345 41% 17% Landscaping 143 B2 Hardstand 47 6% (Discharges directly into Stormfilters) 5% Driveway 40 Total 835 100%

Table 2 – Proposed Development Areas

#### 2.1 Existing Stormwater Infrastructure

The detailed site survey has identified the following stormwater infrastructure within the vicinity of the site:

- A 0.82m (approx.) deep gully pit in the Outridge Street kerb & channel west of the site;
- A DN300 Fibre Reinforced Concrete Pipe (FRC) flows from the abovementioned gully pit to a maintenance hole on the non-development side of Outridge Street; and
- A DN450 Reinforced Concrete Pipe (RCP) flows north-east along Outridge Street to the intersection with Banana Street.

EDQ Approved Design Drawings for ongoing Weinam Creek Priority Development Area Stage 3A has identified the following under construction stormwater infrastructure within the vicinity of the site:

- The stormwater infrastructure on Outridge Street opposite the site is proposed to be replaced with larger pipes and structures in adjusted locations; and
- A new lip-in-line stormwater gully pit on Hamilton Street, over a DN450 SRCP CL3 pipe flowing north under the road, joining the stormwater infrastructure draining from Outridge Street.

Refer to the detailed surveys in **Appendix B** for and the EDQ Approved Design Drawings in **Appendix C** for further information regarding the existing stormwater infrastructure.

#### 2.2 Lawful Point of Discharge

It is proposed that a new stormwater connection will be constructed from the site to the gully pit planned for construction on the development side of Hamilton Street (under construction). Refer to SK02 in **Appendix D** for sketch plans of the post-developed site catchment plan.

#### 2.3 External Catchments

No external catchments of significance have been identified.



#### 3 STORMWATER QUANTITY ASSESSMENT

In accordance with the RCC Stormwater Infrastructure Plan for the Weinam Creek PDA, no stormwater detention is required as the site discharges directly to Moreton Bay.



#### 4 FLOODING

#### 4.1 Sources of Flooding

The flood risk to the site comes from high tidal conditions in Redland Bay. The tidal conditions used to inform design levels across the site are shown below:

- Highest Astronomical Tide (2022 Conditions) 1.63m AHD;
- Highest Astronomical Tide (2070 Conditions) 1.98m AHD;
- Highest Astronomical Tide (2100 Conditions) 2.37m AHD; and
- Storm Tide (2100 Conditions) 3.22m AHD. (Adopted Designated Flood Level)

#### 4.2 Minimum Required Levels

A review of Queensland's Urban Drainage Manual (QUDM) has identified acceptable minimum design levels for basement entry, ground floor carparking and apartments.

The storm tide 2100 level is at 3.22m AHD. While not required by QUDM, the basement entry has had an additional 50mm freeboard added to the storm tide 2100 level, resulting in a minimum design level of 3.27m AHD. Ground floor carparking and non-habitable floors have been assigned a minimum design level equal to the storm tide 2100 level of 3.22m AHD. Habitable floor apartments require an additional 300mm freeboard above the storm tide 2100 level, resulting in a minimum design level of 3.52m AHD. These adopted design levels are outlined in Table 3.

Table 3 - Adopted Design Levels

Use	Tidal Condition	Minimum Design Level		
Basement Entry	Storm Tide – 2100 + 50 mm Freeboard	3.27 m AHD		
Ground Floor Carpark	Storm Tide – 2100	3.22 m AHD		
Apartments	Storm Tide – 2100 for Non-Habitable Floor + 300 mm Freeboard to Habitable Floor	3.22 m AHD for Non-Habitable Floor 3.52 m AHD for Habitable Floor		

#### 4.3 Recommendation

The minimum design levels have been summarised in Table 3.



#### 5 STORMWATER QUALITY ASSESSMENT

This assessment identifies issues relating to stormwater runoff quality and assesses possible methods of treatment and the subsequent impacts on the drainage strategy. The aim of this section of the report is to determine practical approaches in achieving improvements for the quality of the stormwater run-off from the site as set out by the State Planning Policy and the MUSIC Modelling Guidelines.

This section will address the following:

- Runoff to treatment devices; and
- Ensuring treatment device selection criteria is in accordance with Industry Best Practice and, WSUD Engineering Guidelines.

#### 5.1 Site Analysis and Design Strategy

The landscaped and hardstand area for the proposed development are summarised in Table 2 of this report.

Currently no stormwater quality management measures are in place for the subject site. The proposed development offers the opportunity to provide stormwater quality treatment where none exists at present.

A MUSIC model analysis was undertaken to determine the extent of the treatment required for the site and it was determined that one (1) Oceanguard filter, a grass-lined swale and three (3) Ocean Protect 460mm Psorb filters are adequate to achieve the pollutant reduction targets discussed in Section 5.2. Refer to SK02 in Appendix D for details on the respective catchments.

#### 5.2 MUSIC Modelling Results

The sites stormwater run-off was modelled using MUSIC version 6.3.0. The 6-minute rainfall data from the 40265 Redlands monitoring site was utilised in the modelling.

The utilised data was over a 10-year timeframe from 1/01/1997 to 31/12/2006. Pollutant export parameters for the catchment's different land use types were applied in accordance with Table 3.8 of the MUSIC Modelling Guidelines. The objective was to achieve the desired target pollutant reduction levels as specified in AO9.1 of the RCC Healthy Waters Code. The target pollutant reduction targets are as follows:

- 80% Reduction in Total Suspended Solids (TSS);
- 60% Reduction in Total Phosphorus (TP);
- 45% Reduction in Total Nitrogen (TN); and
- 90% Reduction in Gross Pollutants.

The results of the model are shown on the following page in Figure 4 to meet the percent reduction water quality objectives identified by the Council City Plan.

Refer to Appendix E for further information on the MUSIC Model outputs compiled by ADG.



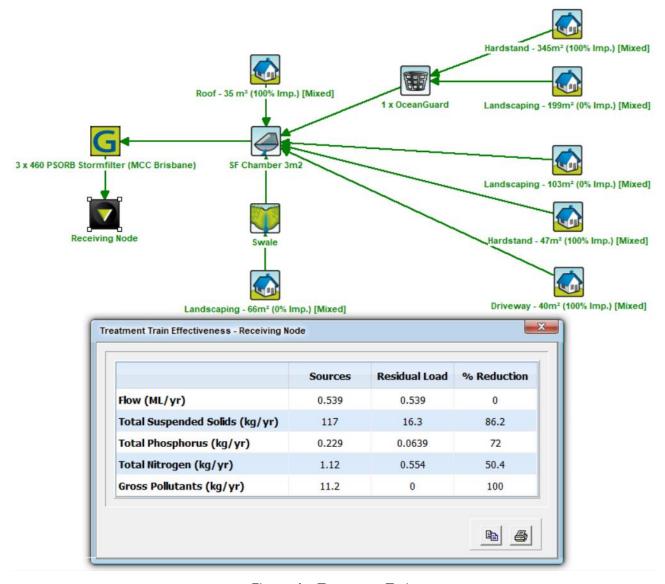


Figure 4 – Treatment Train

The MUSIC results meet the percent reduction water quality objectives identified by Council City Plan.

#### 5.3 Construction Phase

During the construction phase of this development, there is a higher risk of sedimentation transport during construction due to the large areas of disturbed land. An Erosion and Sediment Control (ESC) plan is required for the lodgement of operational works and the following construction phase of the development.

An ESC is required for the lodgement of operational works and shall be implemented during the construction phase of the development as follows:

#### Stage 1: Pre-construction

• All ESC devices are to be installed prior to any earth disturbing activities

#### Stage 2: Construction

All ESC devices are to be maintained to operational levels, as specified in the management plans



and drawings.

- The maintenance plan needs to be in accordance with the Water by Design Construction and Establishment Guidelines.
- During excavation, the contractor shall provide a temporary sediment basin (sump pit) and pump out stormwater only once the water has settled and has achieved an acceptable quality to the satisfaction of Council (i.e. no turbidity and acceptable pH levels).

#### Stage 3: Pre-Operational Stage (all disturbed areas stabilized, 90% of all structures completed)

• All ESC devices can be removed only if approved by the superintendent and engineers.

#### 5.4 Operational Phase

Once directed to be commissioned by the superintendent and engineers, the Stormwater Quality Improvement Devices (SQIDs) will provide the required level of stormwater quality treatment to runoff from the site prior to discharging into Council's stormwater drainage infrastructure. It is expected that sediment laden runoff and the erosion potential at the subject site during the operational phase will be minimal. This is due to the high amount of permanent impervious area in the form of roofs, paths, courtyards, driveways and other impervious areas. The proposed landscaped areas will be maintained in a manner that will minimise erosion.

#### 5.5 Lifecycle Costs

A lifecycle cost analysis is not a part of the scope of this report. All the recommended water quality treatment infrastructure lies within the development site and it shall be maintained and serviced by the owners of the development at <u>no cost to Council</u>.

#### 5.6 Water Quality Monitoring

No water quality monitoring is proposed for this development at this stage due to the nature of the development and the fact that no monitoring currently takes place.

#### 5.7 Maintenance

The site operator will be responsible for organising all monitoring and maintenance activities associated with the operation of the proposed treatment devices in accordance with manufacturer specifications where relevant.



#### 6 CONCLUSION

Detailed design is to confirm the water quality and quantity recommendations. In preparing this report, we have achieved all requirements for stormwater management plans as described in Council's City Plan.

In accordance with the Weinam Creek Stormwater Infrastructure Plan, no stormwater detention is required as the site discharges directly to Moreton Bay.


The following stormwater quality improvement devices are proposed for the site:

- One (1) Ocean guard Filter;
- Three (3) SPEL Stormfilters (460 PSORB) within in a 3m<sup>2</sup> Stormfilter chamber; and
- A grass-lined swale.

Detailed engineering diagrams and management requirements for the proposed development are to be submitted to Council for approval prior to any works commencing on site with design certification prepared by a qualified stormwater engineer or scientist.



## Appendix A Architectural Drawings

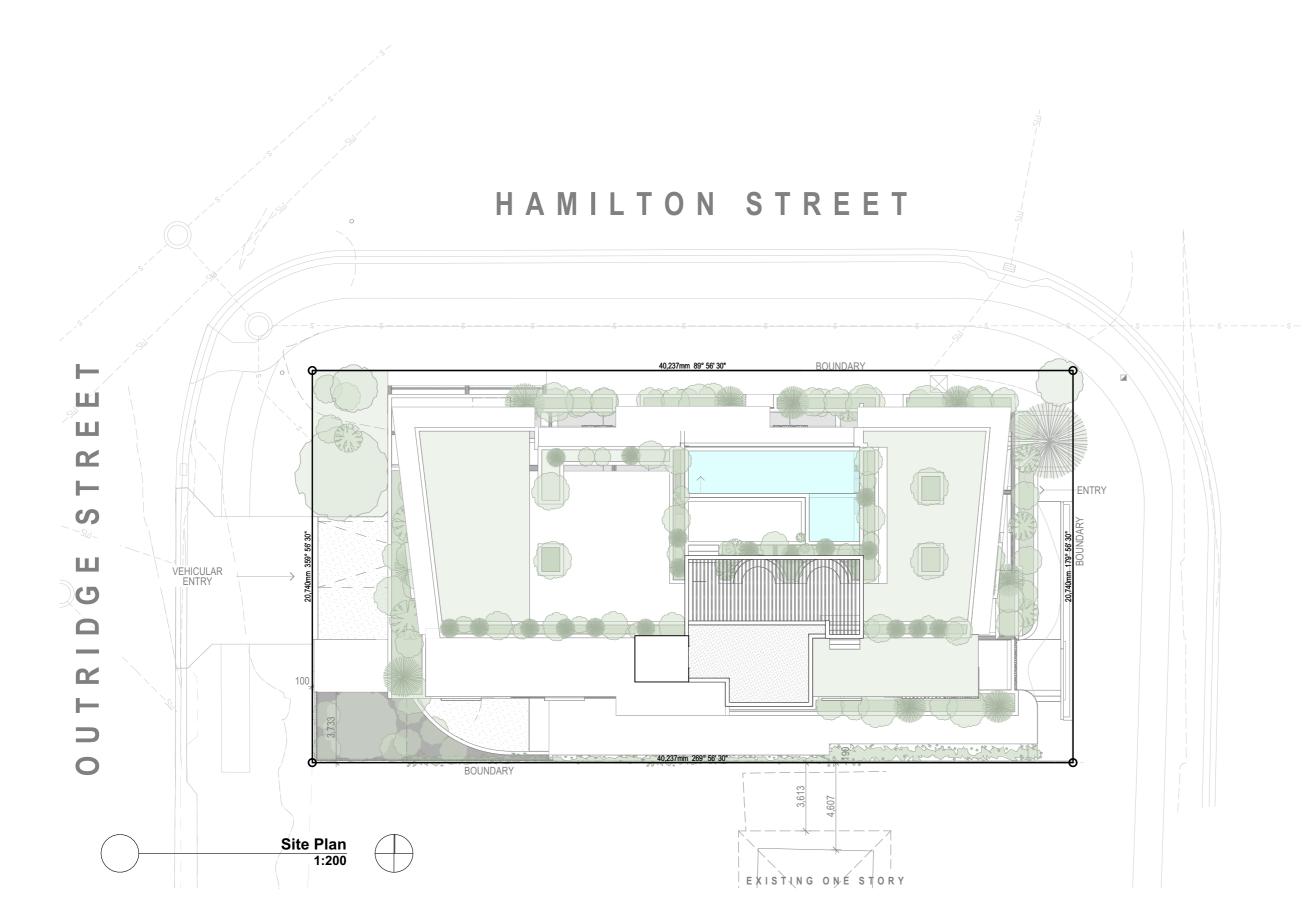

#### TOWN PLANNING DRAWINGS

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Work to be carried out in a neat and appropriate manner.

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15/05/23	N	Revised Town Planning	ΕA
07/02/23	M	Roof Terrace Reconfiguration	ıΕΑ
01/02/23	L	Loft Removed	ΕA
22/12/22	K	Lvl 4-6 Kitchen Layout	ΕA
10/12/22	J	Revised Window Schedule	EΑ
10/12/22	1	TP Information Request	EΑ
30/11/22	Н	Window Schedule	EΑ
24/10/22	G	Futher Issues Response	EΑ
05/10/22	F	Futher Issues Response	EΑ
15/09/22	Ε	IR Response	ΕA
01/09/22	D	Prelim IR Response	EΑ
20/07/22	С	Updated Facade	EΑ
14/07/22	В	Detention tanks added	EΑ
09/06/22	Α	Lodgement Issue	EΑ
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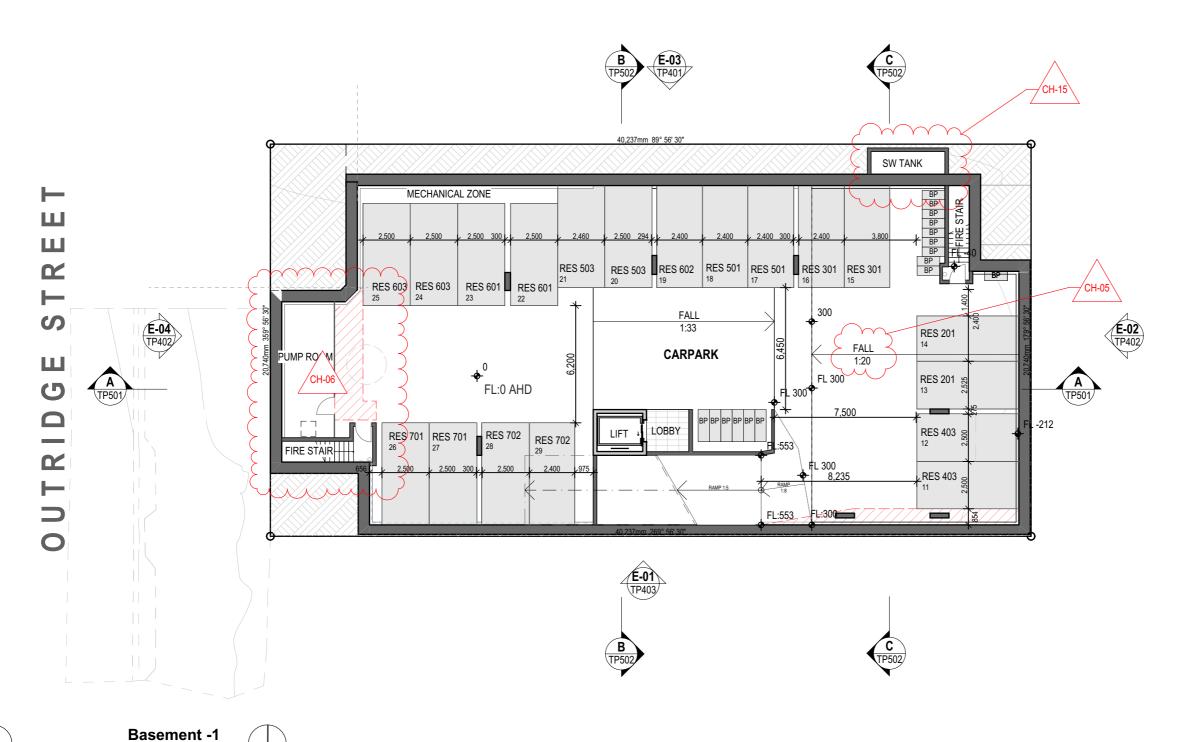
## **Apartment Development**

57 Banana Street, Redland Bay, QLD 4165

Site Plan

Scale @ A3 Checked: 1:200 RH RH Project Number Drawing Number Issue H4474BAN TP104

## HAMILTON STREET



ChID	Change Name
CH-05	Fall in Basement Added
CH-06	Pump Room and MSSB Moved
CH-15	SW Tank Added

1:200

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15/05/23	N	Revised Town Planning	ΕA
07/02/23	M	Roof Terrace Reconfiguration	ıΕΑ
01/02/23	L	Loft Removed	ΕA
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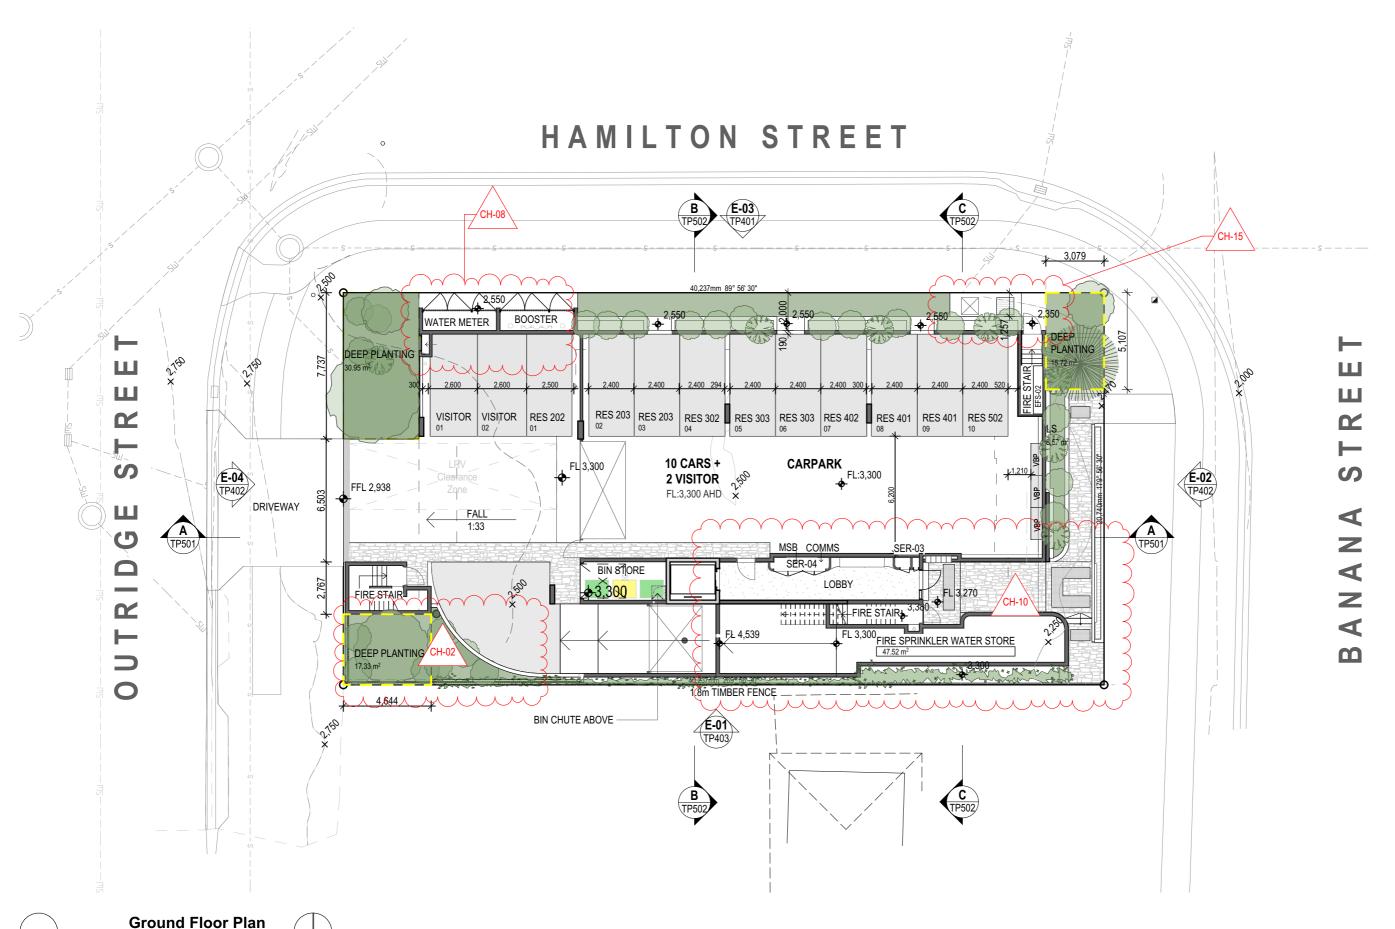


## **Apartment Development**

57 Banana Street, Redland Bay, QLD 4165

Basement -1 Floor Plan

Scale @ A3	Drawn:	Checked
:200	RH	RH
Project Number	Drawing Number	Issue
14474BAN	TP201	Р



ChID	Change Name
CH-02	PMT area removed, added space for deep plenting
CH-08	Water Meter and Booster swapped and Mech Riser Added
CH-10	Services Reconfigured. Fire Sprinkler storage, MSB and Comms
CH-15	SW Tank Added

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24/07/23	Р	SW Pit Added	RH
15/05/23	N	Revised Town Planning	EΑ
07/02/23	M	Roof Terrace Reconfiguration	iΕΑ
01/02/23	L	Loft Removed	EΑ
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**Ground Floor Plan** 

H4474BAN	TP202	Р
Project Number	Drawing Number	Issue
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10/12/22	J	Revised Window Schedule	E
10/12/22	1	TP Information Request	E
30/11/22	Н	Window Schedule	E
24/10/22	G	Futher Issues Response	E
05/10/22	F	Futher Issues Response	E
15/09/22	Е	IR Response	E
01/09/22	D	Prelim IR Response	E
20/07/22	С	Updated Facade	E
14/07/22	В	Detention tanks added	E
09/06/22	Α	Lodgement Issue	E
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#### **Apartment Development**


57 Banana Street, Redland Bay, QLD 4165

Level 2 Floor Plan

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20/07/22	С	Updated Facade	E
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#### **Apartment Development**

57 Banana Street, Redland Bay, QLD 4165

Level 3 Floor Plan
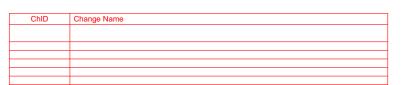
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14/07/22	В	Detention tanks added	E
20/07/22	С	Updated Facade	ΕÆ
01/09/22	D	Prelim IR Response	E
15/09/22	Е	IR Response	E
05/10/22	F	Futher Issues Response	ΕÆ
24/10/22	G	Futher Issues Response	ΕÆ
30/11/22	Н	Window Schedule	ΕÆ
10/12/22	1	TP Information Request	E
10/12/22	J	Revised Window Schedule	E
22/12/22	K	Lvl 4-6 Kitchen Layout	E
01/02/23	L	Loft Removed	E
07/02/23	М	Roof Terrace Reconfiguration	ıΕ
15/05/23		Revised Town Planning	E
24/07/23	-	SW Pit Added	RH



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## **Apartment Development**

57 Banana Street, Redland Bay, QLD 4165

Level 4-6 Floor Plan

Scale @ A3	Drawn:	Checke
1:200	RH	RH
Project Number	Drawing Number	Issue
H4474BAN	TP205	Ρ







ChID	Change Name

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09/06/22 Date		Lodgement Issue Details Chec	E/
14/07/22		Detention tanks added	E
20/07/22	С	Updated Facade	ΕÆ
01/09/22	D	Prelim IR Response	E
15/09/22	Е	IR Response	ΕÆ
05/10/22	F	Futher Issues Response	E
24/10/22	G	Futher Issues Response	ΕÆ
30/11/22	Н	Window Schedule	E
10/12/22	-	TP Information Request	E/
10/12/22		Revised Window Schedule	E/
22/12/22	K	Lvl 4-6 Kitchen Layout	ΕÆ
01/02/23	L	Loft Removed	ΕÆ
07/02/23	M	Roof Terrace Reconfiguration	EΑ
15/05/23	N	Revised Town Planning	E
24/07/23	Р	SW Pit Added	Rŀ



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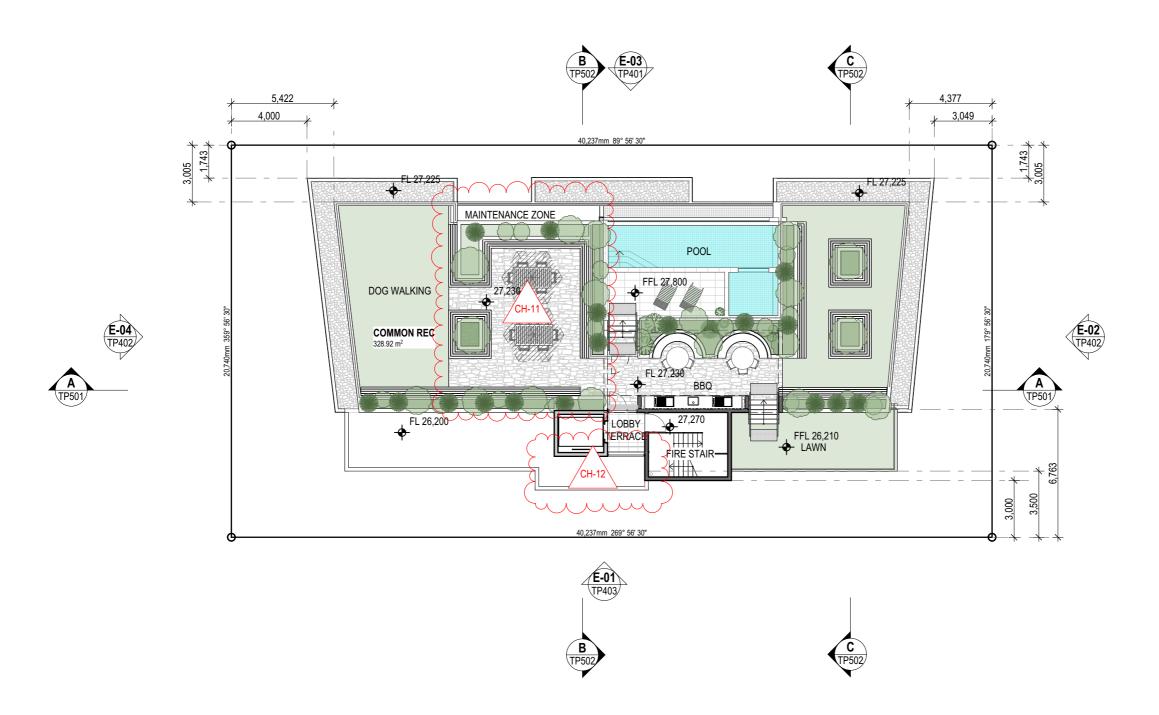


#### **Apartment Development**

57 Banana Street, Redland Bay, QLD 4165

Level 7 Floor Plan

Scale @ A3	Drawn:	Checke
1:200	RH	RH
Project Number	Drawing Number	Issue
H4474BAN	TP206	Р



# **Roof Terrace Floor Plan**

ChID (	Change Name
CH-11 F	Roof Communal Area reconfigured
CH-12	Screen Removed

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			A	
Date		Issue	Details Check	ked
09/06	6/22	Α	Lodgement Issue	EΑ
14/07	7/22	В	Detention tanks added	EΑ
20/07	7/22	С	Updated Facade	EΑ
01/09	9/22	D	Prelim IR Response	ΕA
15/09	9/22	Е	IR Response	ΕA
05/10	)/22	F	Futher Issues Response	EΑ
24/10	)/22	G	Futher Issues Response	EΑ
30/11	1/22	Н	Window Schedule	EΑ
10/12	2/22	1	TP Information Request	EΑ
10/12	2/22	J	Revised Window Schedule	EΑ
22/12	2/22	K	Lvl 4-6 Kitchen Layout	ΕA
01/02	2/23	L	Loft Removed	EΑ
07/02	2/23	M	Roof Terrace Reconfiguration	EΑ
15/05			Revised Town Planning	EΑ
24/07		-	SW Pit Added	RH



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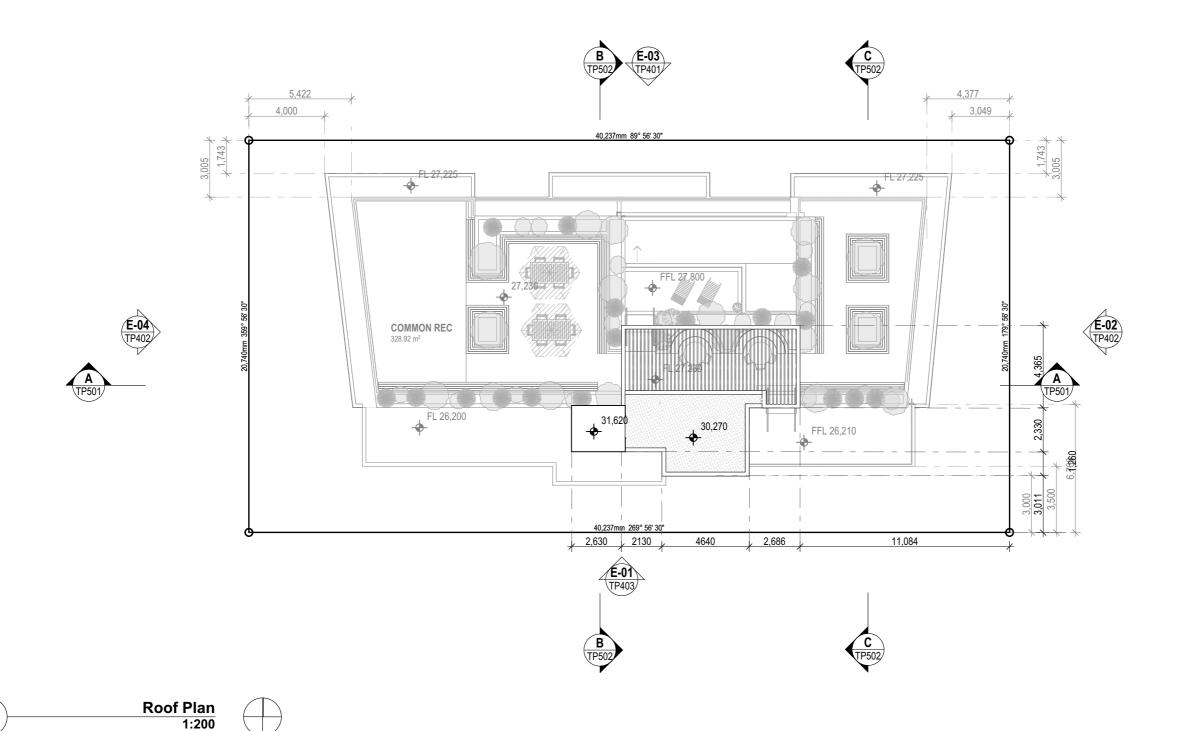


#### **Apartment Development**

57 Banana Street, Redland Bay, QLD 4165

Roof Terrace Plan

Project Number H4474BAN	Drawing Number	Issue P
Scale @ A3	Drawn:	Checke
1:200	RH	RH



Change Name

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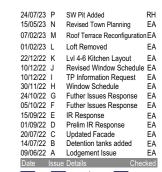
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#### **Apartment Development**

57 Banana Street, Redland Bay, QLD 4165

Roof Plan

Scale @ A3	Drawn:	Checke
1:200	RH	RH
Project Number	Drawing Number	Issue
H4474BAN	TP208	Р



CH-11

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24/07/23	Р	SW Pit Added	RH
15/05/23	N	Revised Town Planning	ΕA
07/02/23	M	Roof Terrace Reconfiguration	١EA
01/02/23	L	Loft Removed	ΕA
22/12/22	K	Lvl 4-6 Kitchen Layout	EΑ
10/12/22	J	Revised Window Schedule	ΕA
10/12/22	1	TP Information Request	EΑ
30/11/22	Н	Window Schedule	EΑ
24/10/22	G	Futher Issues Response	ΕA
05/10/22	F	Futher Issues Response	EΑ
15/09/22	Е	IR Response	EΑ
01/09/22	D	Prelim IR Response	EΑ
20/07/22	С	Updated Facade	EΑ
14/07/22	В	Detention tanks added	ΕA
09/06/22	Α	Lodgement Issue	ΕA
Date	Issue	Details Chec	ked
_			



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**Apartment Development** 57 Banana Street, Redland Bay,

QLD 4165

North Elevation				
Scale @ A3 1:200	Drawn: RH	Checke		
Project Number	Drawing Number	Issue		
H4474BAN	TP401	Р		



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24/07/23	Р	SW Pit Added	RH
15/05/23	N	Revised Town Planning	EΑ
07/02/23	M	Roof Terrace Reconfiguration	EΑ
01/02/23	L	Loft Removed	ΕA
22/12/22	K	Lvl 4-6 Kitchen Layout	ΕA
10/12/22	J	Revised Window Schedule	EΑ
10/12/22	1	TP Information Request	EΑ
30/11/22	Н	Window Schedule	EΑ
24/10/22	G	Futher Issues Response	EΑ
05/10/22	F	Futher Issues Response	EΑ
15/09/22	Е	IR Response	ΕA
01/09/22	D	Prelim IR Response	ΕA
20/07/22	С	Updated Facade	ΕA
14/07/22	В	Detention tanks added	ΕA
09/06/22	Α	Lodgement Issue	EΑ
Date	Issue	Details Chec	ked



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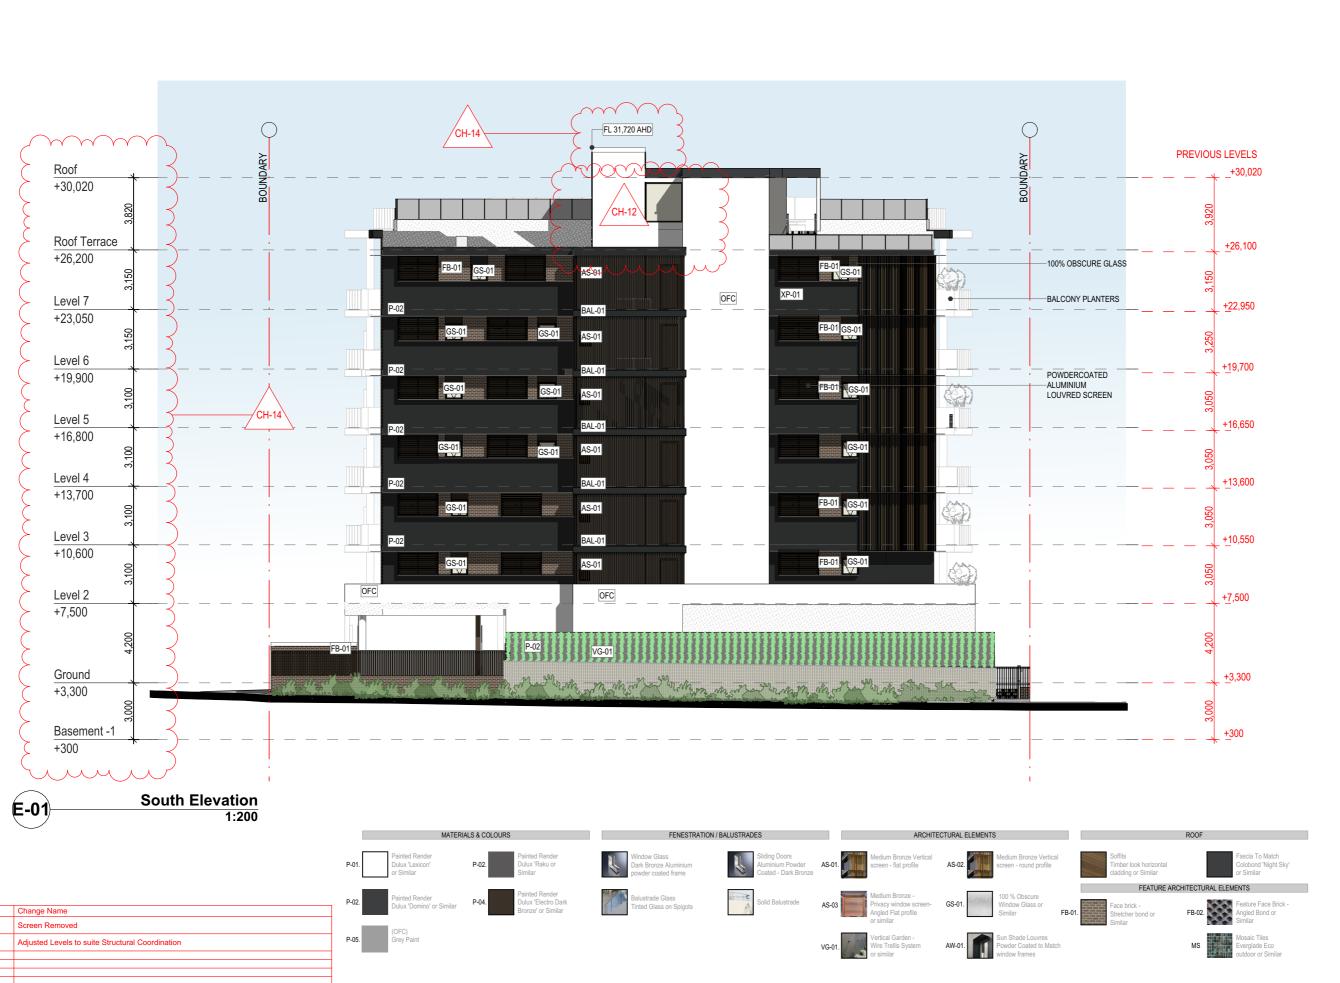


**Apartment Development** 57 Banana Street, Redland Bay,

QLD 4165

East & West Elevation

H4474BAN	TP402	Р
Project Number	Drawing Number	Issue
1:200	RH	RH
Scale @ A3	Drawn:	Checked



CH-12

#### TOWN PLANNING DRAWINGS

LEGEND

ALLUMINIUM PRIVACY SCREEN ALLUMINIUM AWNING TINTED GLASS BALUSTRADE

FEATURE STONE

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Date	1	ssue	Details Chec	ked
09/06/2	_	• •	Lodgement Issue	EΑ
14/07/2	_	В	Detention tanks added	EΑ
20/07/2	22	С	Updated Facade	EΑ
01/09/2	22	D	Prelim IR Response	EΑ
15/09/2	22	Е	IR Response	ΕA
05/10/2	22		Futher Issues Response	EΑ
24/10/2	22	G	Futher Issues Response	ΕA
30/11/2	2		Window Schedule	ΕA
10/12/2	2	Ĭ	TP Information Request	ΕA
10/12/2	2		Revised Window Schedule	EΑ
22/12/2	22	K	Lvl 4-6 Kitchen Layout	ΕA
01/02/2	23	L	Loft Removed	EΑ
07/02/2	23	M	Roof Terrace Reconfiguration	EΑ
15/05/2	23	N	Revised Town Planning	EΑ
24/07/2	-	-	SW Pit Added	RH



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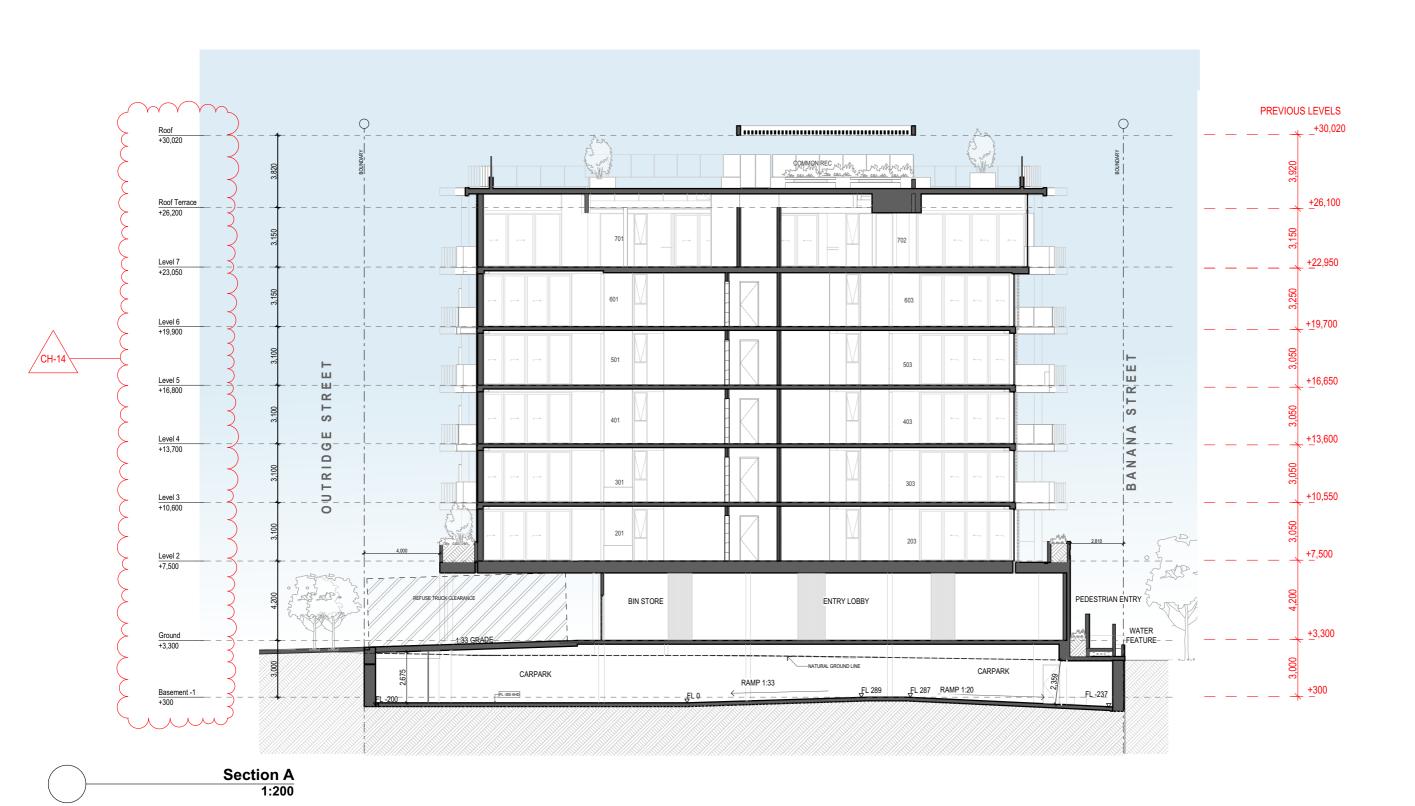


QLD 4165

**Apartment Development** 57 Banana Street, Redland Bay,

South Elevation

H4474BAN	TP403	Р
Project Number	Drawing Number	Issue
1:200	RH	RH
Scale @ A3	Drawn:	Check



ChID	Change Name
CH-14	Adjusted Levels to suite Structural Coordination

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24/07/23	Р	SW Pit Added	RH
15/05/23	N	Revised Town Planning	EΑ
07/02/23	M	Roof Terrace Reconfiguration	iΕΑ
01/02/23	L	Loft Removed	EΑ
22/12/22	K	Lvl 4-6 Kitchen Layout	EΑ
10/12/22	J	Revised Window Schedule	EΑ
10/12/22	1	TP Information Request	EΑ
30/11/22	Н	Window Schedule	EΑ
24/10/22	G	Futher Issues Response	EΑ
05/10/22	F	Futher Issues Response	EΑ
15/09/22	E	IR Response	EΑ
01/09/22	D	Prelim IR Response	EΑ
20/07/22	С	Updated Facade	EΑ
14/07/22	В	Detention tanks added	EΑ
09/06/22	Α	Lodgement Issue	EΑ
Date	Issue	Details Chec	ked



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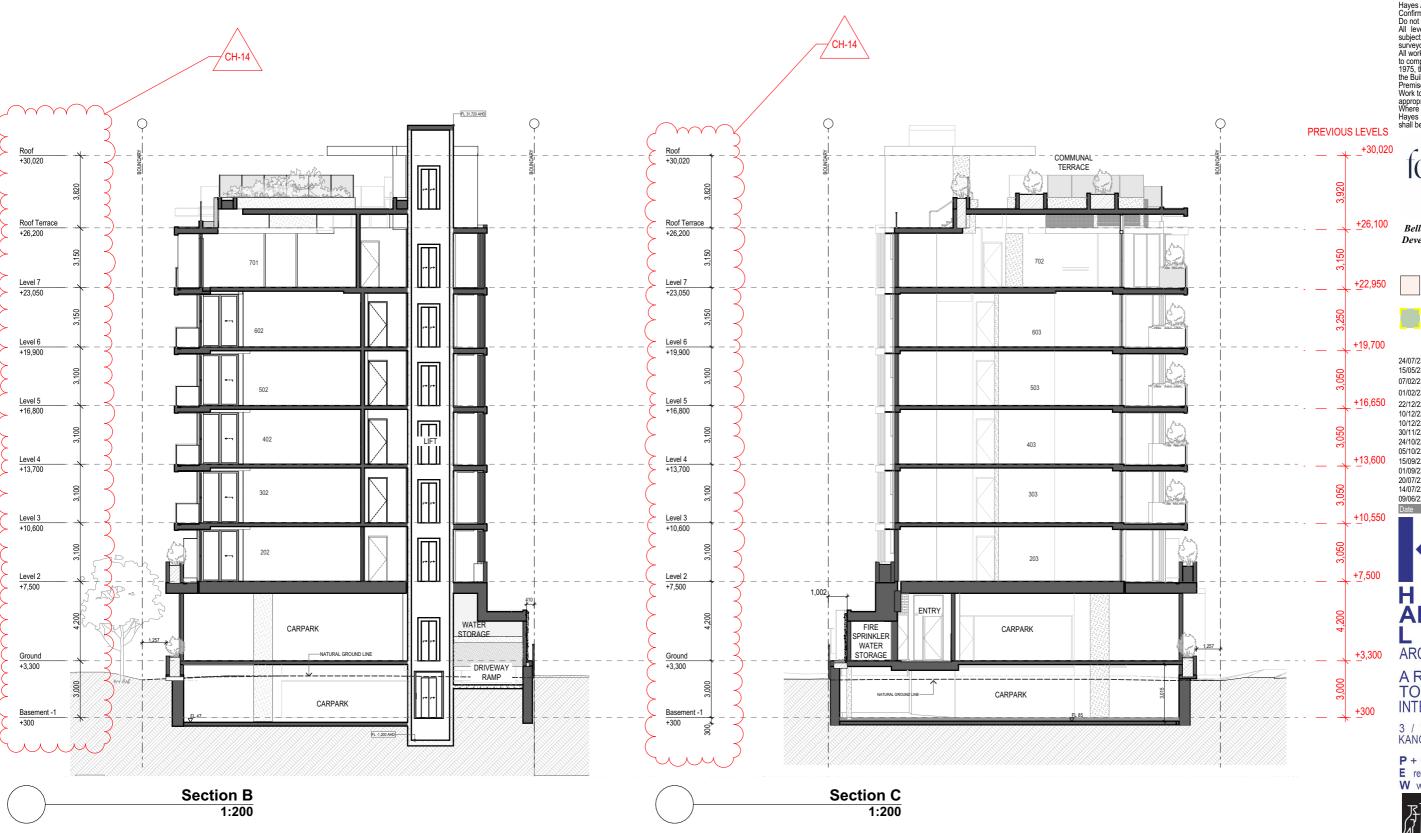


## **Apartment Development**

57 Banana Street, Redland Bay, QLD 4165

Sections

Scale @ A3	Drawn:	Checke
1:200	RH	RH
Project Number	Drawing Number	Issue
H4474BAN	TP501	Р



## CH-14 Adjusted Levels to suite Structural Coordination

#### NOTE:

Boundary, contours, levels, and site services information is shown indicatively only, based on eBimap. It is subject to confirmation by a licensed Surveyor in the form of an Identification Survey

#### NOTE:

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24/07/23	Ρ	SW Pit Added	RH
15/05/23	N	Revised Town Planning	EΑ
07/02/23	M	Roof Terrace Reconfiguration	iΕΑ
01/02/23	L	Loft Removed	EΑ
22/12/22	K	Lvl 4-6 Kitchen Layout	EΑ
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24/10/22	G	Futher Issues Response	EΑ
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20/07/22	С	Updated Facade	EΑ
14/07/22	В	Detention tanks added	EΑ
09/06/22	Α	Lodgement Issue	EΑ
Date	Issue	Details Chec	ked



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#### **Apartment Development**


57 Banana Street, Redland Bay, QLD 4165

Sections

H4474BAN	TP502	Р
Project Number	Drawing Number	Issue
1:200	RH	RH
Scale @ A3	Drawn:	Checked



## Appendix B Detailed Surveys

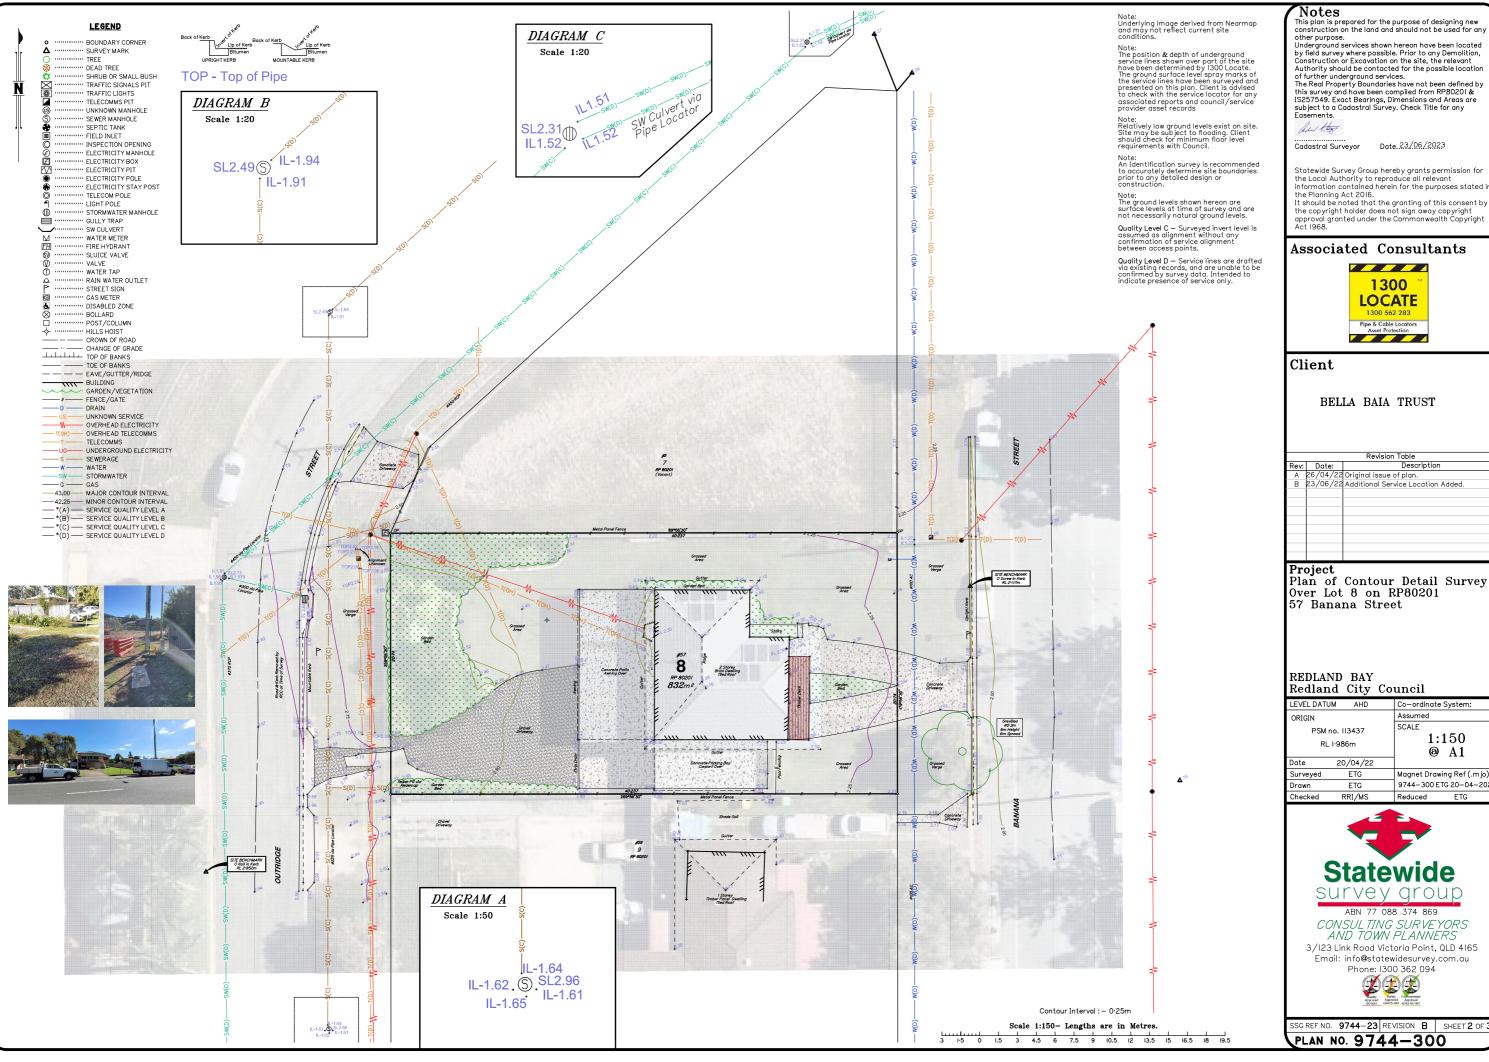

other purpose.
Underground services shown hereon have been located by field survey where possible. Prior to any Demolition, Construction or Excavation on the site, the relevant Authority should be contacted for the possible location

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	Revision Table				
Rev:	Date:	Description			
Α	26/04/22	Original issue of plan.			
В	23/06/22 Additional Service Location Added.				

**Project** Plan of Contour Detail Survey Over Lot 8 on RP80201

## Redland City Council

ORIGIN		Assumed	
PSM no. 113437 RL 1-986m		1:150 @ A1	
Date	20/04/22		
Surveyed	ETG	Magnet Drawing Ref (.mjo):	
Drawn	ETG	9744-300 ETG 20-04-2022	
A	DDI (440	D 1 1 5TO	




ABN 77 088 374 869 CONSULTING SURVEYORS AND TOWN PLANNERS

3/I23 Link Road Victoria Point, QLD 4I65 Email: info@statewidesurvey.com.au Phone: I300 362 094



SSG REF NO. 9744-23 REVISION B SHEET 2 OF 3

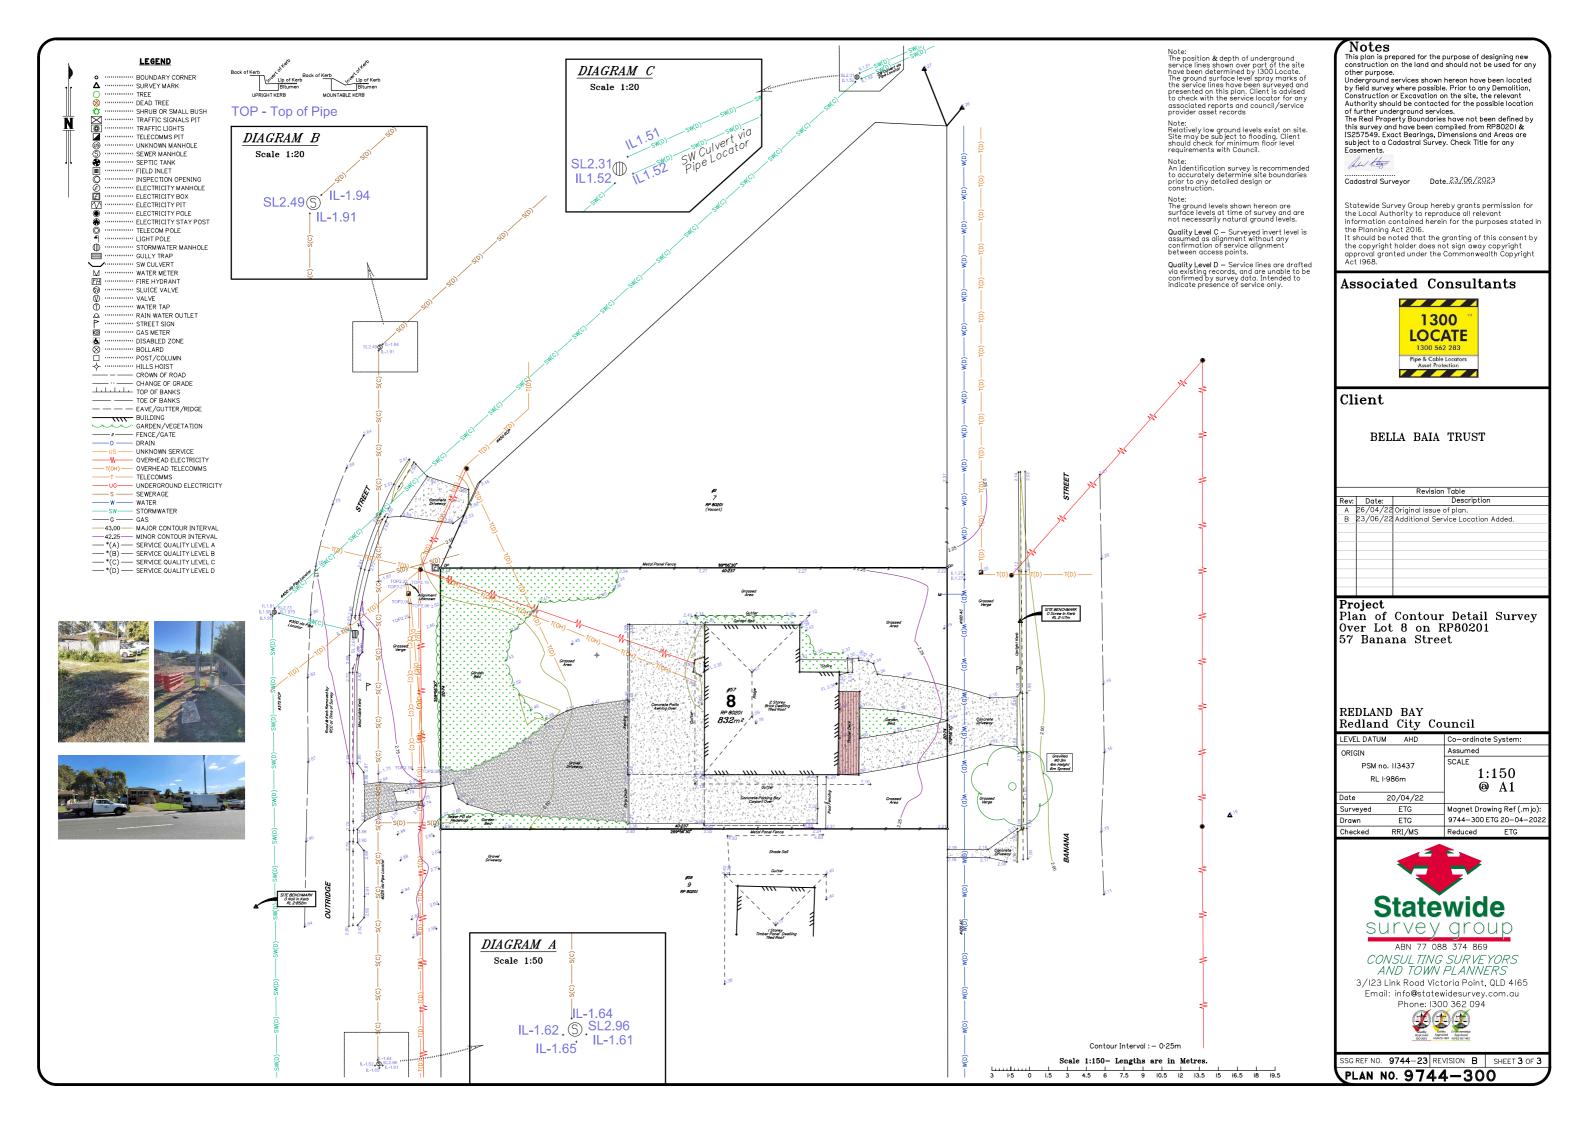



## Appendix C EDQ Approved Design Drawings

C-1108

C-1109

C-1110

C-1111

C-1112

C-1113

C-1114

C-1115

C-1116

C-1200

R-RCC-1

R-RCC-2

R-RCC-3

R-RCC-4

R-RCC-5

R-RCC-6


# WEINAM CREEK PRIORITY DEVELOPMENT

PLANS AND DOCUMENTS referred to in the PDA **DEVELOPMENT APPROVAL** 

# **AREA - STAGE 3A**

# WEINAM CREEK, REDLAND BAY. FOR REDLAND INVESTMENT CORPORATION.

#### LOCALITY PLAN & DRAWING INDEX C-1002 ESTATE PLAN C-1003 KEY PLAN EXISTING SITE FEATURES C-1004 CONTROL LINE SETOUT SHEET-1 C-1006 CONTROL LINE SETOUT SHEET-2 C-1007 CONTROL LINE SETOUT SHEET-3 C-1008 CONTROL LINE SETOUT SHEET-4 C-1009 CONTROL LINE SETOUT SHEET-5 C-1010 CONTROL LINE SETOUT SHEET-6 C-1011 CONTROL LINE SETOUT SHEET-7 C-1012 CONTROL LINE SETOUT SHEET-8 CONTROL LINE SETOUT SHEET-9 C-1013 C-1014 CONTROL LINE SETOUT SHEET-10 C-1015 RETAINING WALL (RW01) CONTROL LINE SETOUT C-1016 RETAINING WALL (RW01) & (RW02) CONTROL LINE SETOUT DRIVEWAY CONTROL LINE & SETOUT TABLE C-1017 C-1018 FOOTPATH CONTROL LINE & SETOUT TABLE C-1019 TYPICAL SECTIONS & STANDARD NOTES - SHEET 1 C-1020 TYPICAL SECTIONS & STANDARD NOTES - SHEET 2 C-1021 DETAILS DEMOLITION PLAN - SHEET 1 C-1022 DETAILS DEMOLITION PLAN - SHEET 2 DETAILS DEMOLITION PLAN - SHEET 3 C-1023 DETAILS DEMOLITION PLAN - SHEET 4 DETAILS DEMOLITION PLAN - SHEET 5 C-1025 C-1026 DETAILS DEMOLITION PLAN - SHEET 6 C-1027 DETAILS DEMOLITION PLAN - SHEET 7 DETAILS DEMOLITION PLAN - SHEET 8 C-1028 C-1100 MC01 LONGITUDINAL SECTIONS - SHEET C-1101 MC01 LONGITUDINAL SECTIONS - SHEET 2 C-1102 MC02 & MC03 LONGITUDINAL SECTIONS C-1103 MC04 & MC05 LONGITUDINAL SECTIONS C-1104 MC06 LONGITUDINAL SECTIONS RETAINING WALL (RW01) LONGITUDINAL SECTIONS C-1105 RETAINING WALL (RW02) LONGITUDINAL SECTIONS C-1106 C-1107 RETAINING WALL (RW03) LONGITUDINAL SECTIONS

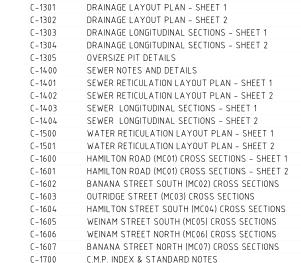

CONSTRUCTION MANAGEMENT PLAN

EROSION & SEDIMENT CONTROL PLAN

**EROSION & SEDIMENT CONTROL STANDARD NOTES** 

STANDARD EMBEDMENT ALL PIPE TYPES

DRAINAGE NOTES AND DETAILS

#### STANDARD DRAWINGS - W.S.A.A.

C-1701

C-1703

WAT-1201


WAT-1205	THRUST BLOCK DETAILS CONCRETE BLOCKS
WAT-1207	THRUST AND ANCHOR BLOCKS GATE VALVES AND VERTICAL BENDS
WAT-1300	VALVE AND HYDRANT IDENTIFICATION MARKERS & MARKER POSTS
WAT-1301	TYPICAL VALVE & HYDRANT INSTALLATION VALVE ARRANGEMENT
WAT-1302	TYPICAL VALVE & HYDRANT INSTALLATION HYDRANTS AND AIR
	RELIEF VALVES
WAT-1303	TYPICAL SURFACE FITTING INSTALLATION GATE VALVE SURFACE
	BOXES NON TRAFFICABLE
WAT-1305	TYPICAL SURFACE FITTING INSTALLATION HYDRANT SURFACE BOXES
	TRAFFICABLE AND NON-TRAFFICABLE
WAT-1313	FLANGED JOINTS BOLTING DETAILS

EMBEDMENT & TRENCHFILL TYPICAL ARRANGEMENT

#### STANDARD DRAWINGS - IPWEAQ

D3-010	STORTIWATER ACCESS CHAINDER DETAIL 1030 TO 2100 DIAMETER	DR0-5-0025	P 11
DS-011	ACCESS CHAMBER ROOF SLABS DIA 1050 – 2100	22 2 2.22	INT
DS-013	ACCESS CHAMBER ROOF SLAB - RECTANGULAR STANDARD REINFORCEMENT		
DS-019	MANHOLE COVER (ROADWAY) 1050 TO 2100 DIAMETER		
DS-030	BEDDING AND BACKFILLING - EXCAVATION, BEDDING AND BACKFILLING OF CONVERT-FIBR	E REINFORCED DRAINAGE	PIPES
DS-040	SEDIMENT CONTROL DEVICES SEDIMENT FENCE, ENTRY/EXIT SEDIMENT TRAP		
DS-041	SEDIMENT CONTROL DEVICES KERB AND FIELD INLETS – CHECK DAMS & STRAW BALES		
DS-050	DRAINAGE PITS FIELD INLET TYPE 1 AND TYPE 2		
DS-063	DRAINAGE PITS KERB INLET-LIP IN LINE GENERAL ARRANGEMENT		
RS-080	KERB AND CHANNEL – PROFILES AND DIMENSIONS		
RS-090	KERB RAMPS – RAMPED PEDESTRIAN CROSSINGS		
RS-094	KERB RAMPS - LOCATIONS AND CONFIGURATIONS		

Approval no: DEV2022/1279

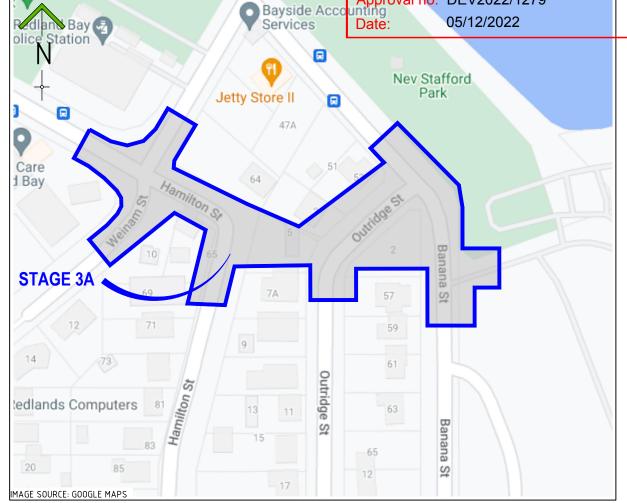

#### **LOCALITY PLAN**

#### **STANDARD DRAWINGS - TMR**

SCALE: NTS

PIPE CULVERTS - WINGWALLS, HEADWALLS AND APRON FOR PIPE DIAMETER 750 TO 2400 - DRAWING 1 OF 2 TO 2 OF 2 SD-1305 PIPE CULVERTS - HEADWALL AND APRON FOR PIPE DIAMETER 375 TO 675 ACCESS CHAMBER - ROOF SLABS 1050 TO 2100 SD-1308 ROAD EDGE AND GUIDE POSTS - TIMBER AND TUBULAR STEEL POST AND INSTALLATION DETAILS CULVERTS - INSTALLATION, BEDDING AND FILLING/BACKFILLING AGAINST/OVER CULVERTS

#### STANDARD DRAWINGS - TRANSLINK

PTIM, BUS STOP INFRASTRUCTURE CHAPTER DRG-5-0022 INTERMEDIATE STOP - SITE LAYOUT - WITH INDENTED BUS BAY

PTIM, BUS STOP INFRASTRUCTURE CHAPTER INTERMEDIATE STOP - SITE LAYOUT - ACCESS EXAMPLES

THE ORIGINAL PLANS OF THIS PLAN SET WERE PRODUCED USING COLOUR FOR GREATER CLARITY AND OBJECT DEFINITION. WORKING WITH A BLACK AND WHITE COPY MAY CAUSE ERRORS. IF THESE DRAWINGS ARE NOT IN COLOUR THEN YOU **DO NOT** HAVE THE CORRECT PRESENTATION AND SHOULD SEEK ADVICE.

NOTWITHSTANDING THAT EXISTING SERVICES MAY OR MAY NOT BE SHOWN ON THESE DRAWINGS, NO RESPONSIBILITY IS TAKEN BY ESQ FOR THIS INFORMATION, WHICH HAS BEEN SUPPLIED BY OTHERS, EXISTING SERVICES ARE PROVIDED FOR INFORMATION ONLY. NO CONSTRUCTION WORK SHALL BE UNDERTAKEN UNTIL SERVICE LOCATIONS HAVE BEEN CONFIRMED ON SITE WITH THE RELEVANT AUTHORITY.

	REVISIONS	ISSUE DATE	SCALE:
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1	RFI RESPONSE	06/10/2022	
0	ISSUE FOR APPROVAL	8/8/2022	DO NOT SCALE FROM PLAN

DESIGN DETAIL - SHEET 1

DESIGN DETAIL - SHEET 2

DESIGN DETAIL - SHEET 3

DESIGN DETAIL - SHEET 4

DESIGN DETAIL - SHEET 5

DESIGN DETAIL - SHEET 6

DESIGN DETAIL - SHEET 7

DESIGN DETAIL - SHEET 8

FOOTPATH AND DRIVEWAY SETOUT TABLE

STANDARD DRAWINGS - REDLAND CITY COUNCIL

FOOTPATH PROFILE

LINE MARKING AND SINAGE DRAWING - SHEET 1

LINE MARKING AND SINAGE DRAWING - SHEET 2

DOMESTIC DRIVEWAY CROSSOVER

DRIVEWAY CROSSOVER (TYPE A)

COMMERCIAL/INDUSTRIAL/MULTIPLE DWELLING/APARTMENT BUILDING

PUBLIC UTILITIES IN ROAD RESERVE - CORRIDORS AND ALIGNMENTS

COMMERCIAL/INDUSTRIAL DRIVEWAY CROSSOVER (TYPE B)

PUBLIC UTILITIES IN ROAD RESERVE - CONDUIT SECTIONS

CONCRETE FOOTPATH AND SHARED USE PATHS

**FOR APPROVAL** 





ROAD FURNITURE - TRAFFIC SIGN INSTALLATION DETAILS

SUBSOIL DRAINS - DETAILS AND LOCATION

PAVEMENT EXTENSION - TRENCHING AND WIDENING

ROAD FURNITURE - STREET NAME SIGN AND LOCATION (FINGERBOARD)



#### TITLE: LOCALITY PLAN & DRAWING INDEX

**WEINAM CREEK PRIORITY DEVELOPMENT AREA STAGE 3A** WEINAM CREEK REDLAND BAY FOR REDLAND INVESTMENT CORPORATION

No. 1 of 72 DRAWINGS DWG No. FC-22-014-3A C-1001 0 1 2 3 4 5



APPROVED DATE: 06/10/22

RS-130

RS-131

RS-140

RS-170

PLANS AND DOCUMENTS referred to in the PDA **DEVELOPMENT APPROVAL** 



Approval no: DEV2022/1279


05/12/2022



- ALL BOUNDARIES SHOWN ON THIS PLAN ARE SUBJECT TO FINAL SURVEY
- CONTOURS SHOWN DEPICT EXISTING SURFACE AND ARE AT 0.25m INTERVALS.

NOTWITHSTANDING THAT EXISTING SERVICES MAY OR MAY NOT BE SHOWN ON THESE DRAWINGS. NO RESPONSIBILITY IS TAKEN BY ESQ FOR THIS INFORMATION, WHICH HAS BEEN SUPPLIED BY OTHERS. EXISTING SERVICES ARE PROVIDED FOR INFORMATION ONLY. NO CONSTRUCTION WORK SHALL BE UNDERTAKEN UNTIL SERVICE LOCATIONS HAVE BEEN CONFIRMED ON SITE WITH THE RELEVANT AUTHORITY

	REVISIONS	ISSUE DATE	SC
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APPROVED DATE: 06/10/22

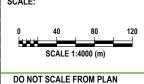
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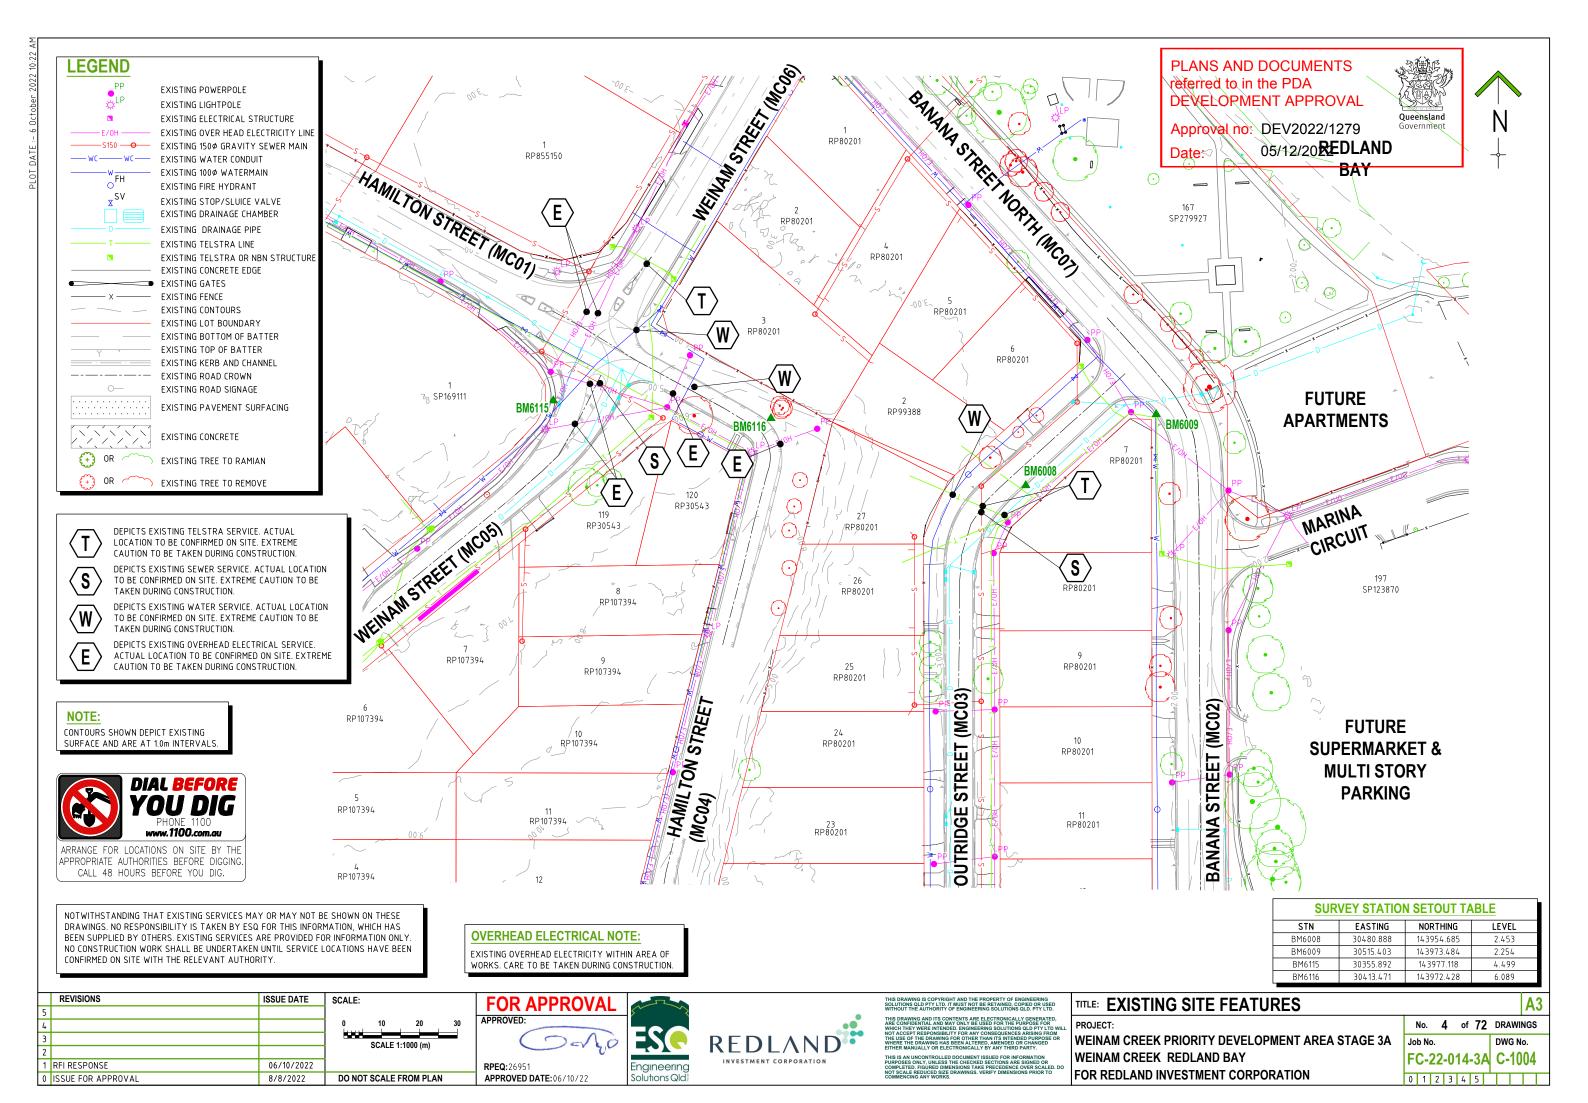






WEINAM CREEK PRIORITY DEVELOPMENT AREA STAGE 3A WEINAM CREEK REDLAND BAY FOR REDLAND INVESTMENT CORPORATION

					<b>A3</b>
No.	2	of	72	DRAWI	NGS
Job No				DWG N	lo.
FC-2	2-0	14-	3A	C-10	02
0 1	2 3	4	5		



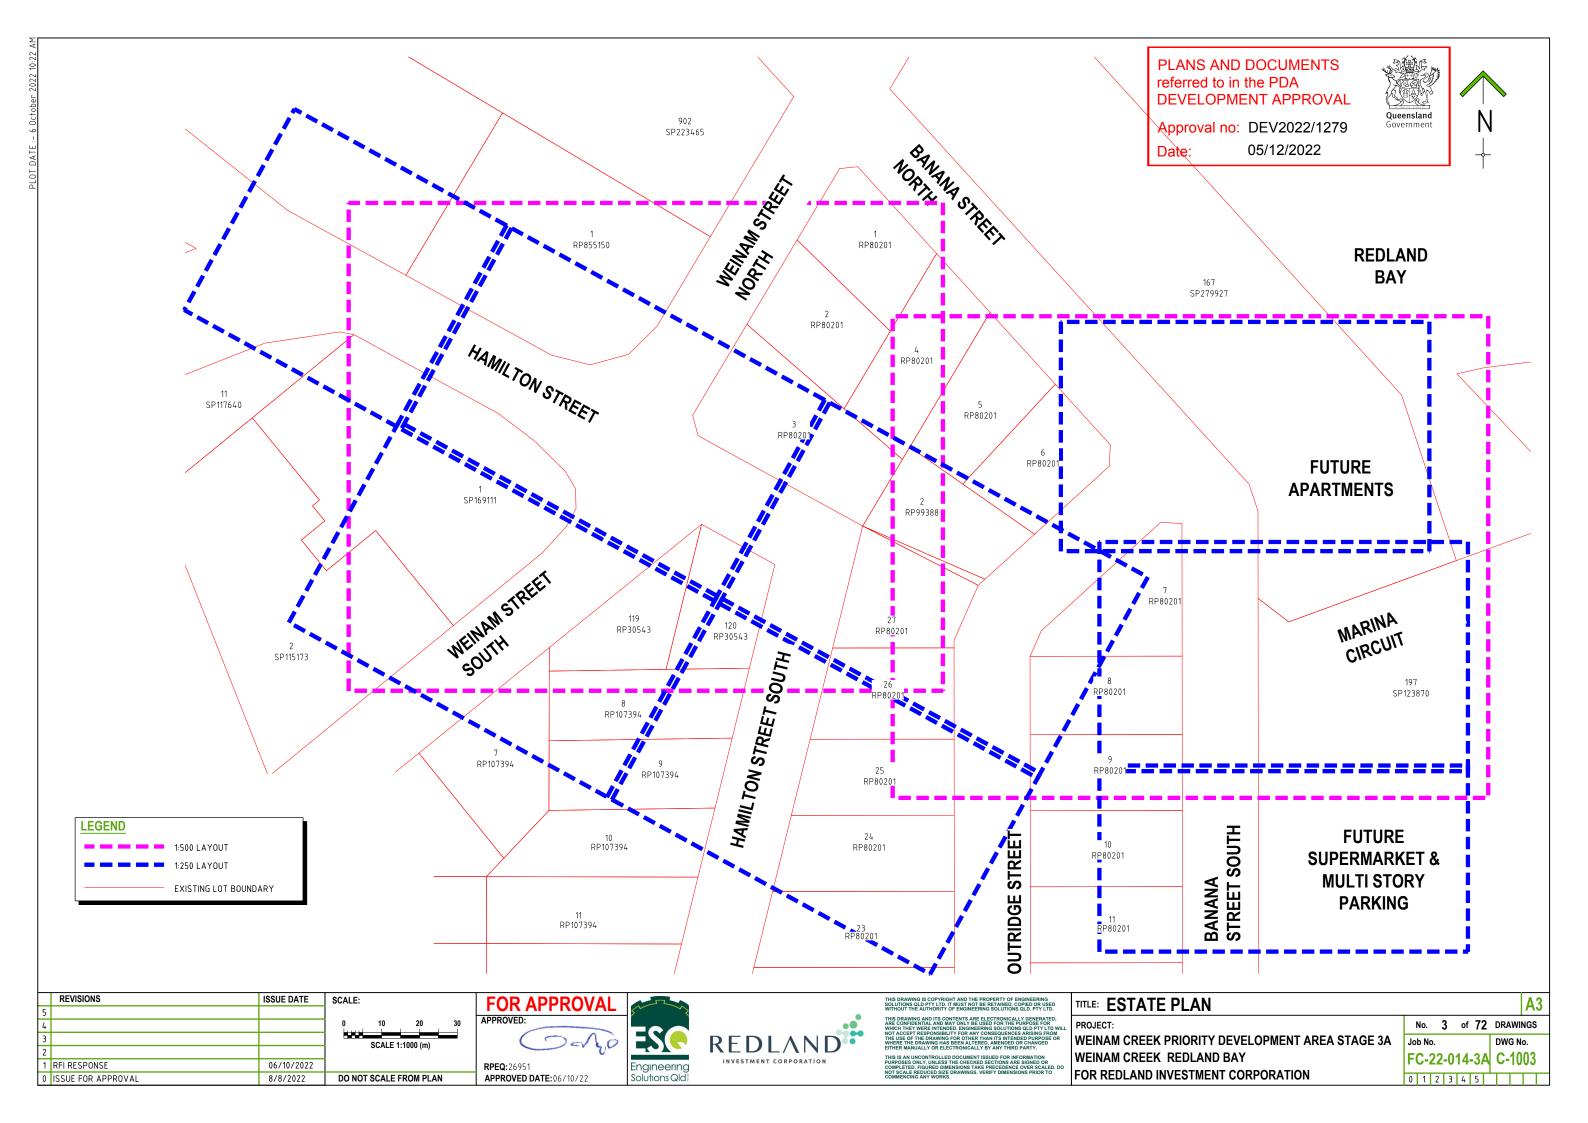

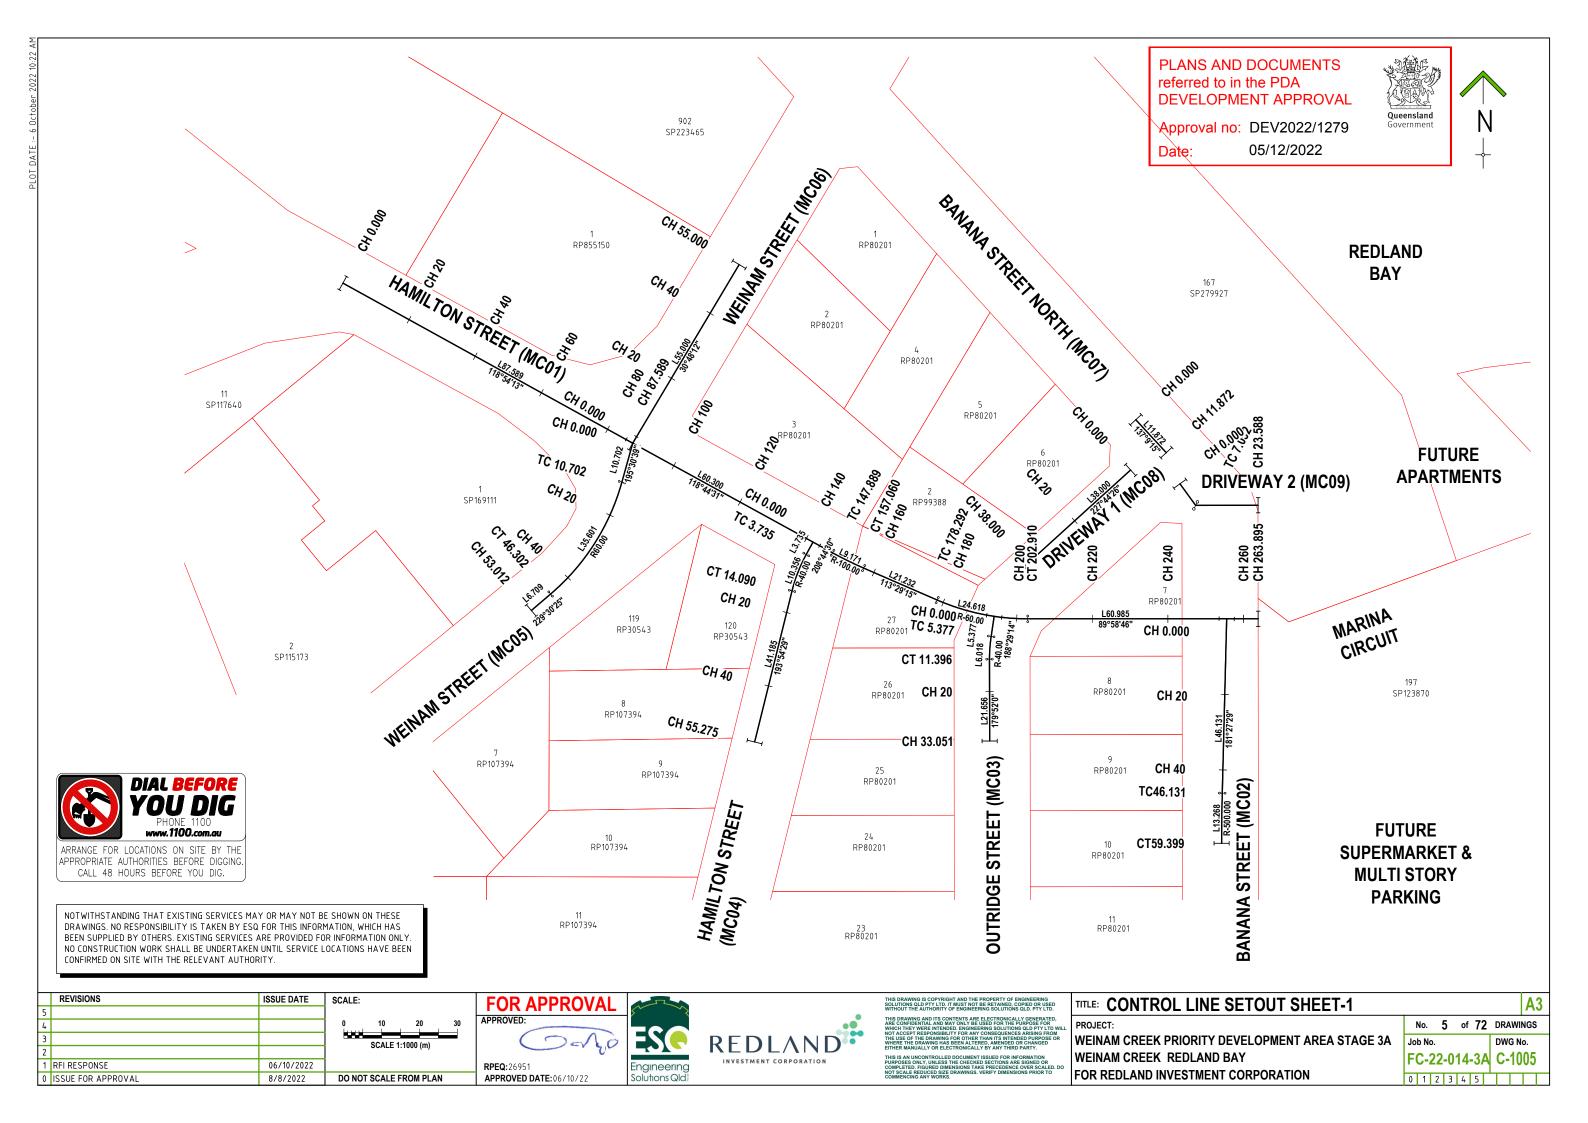


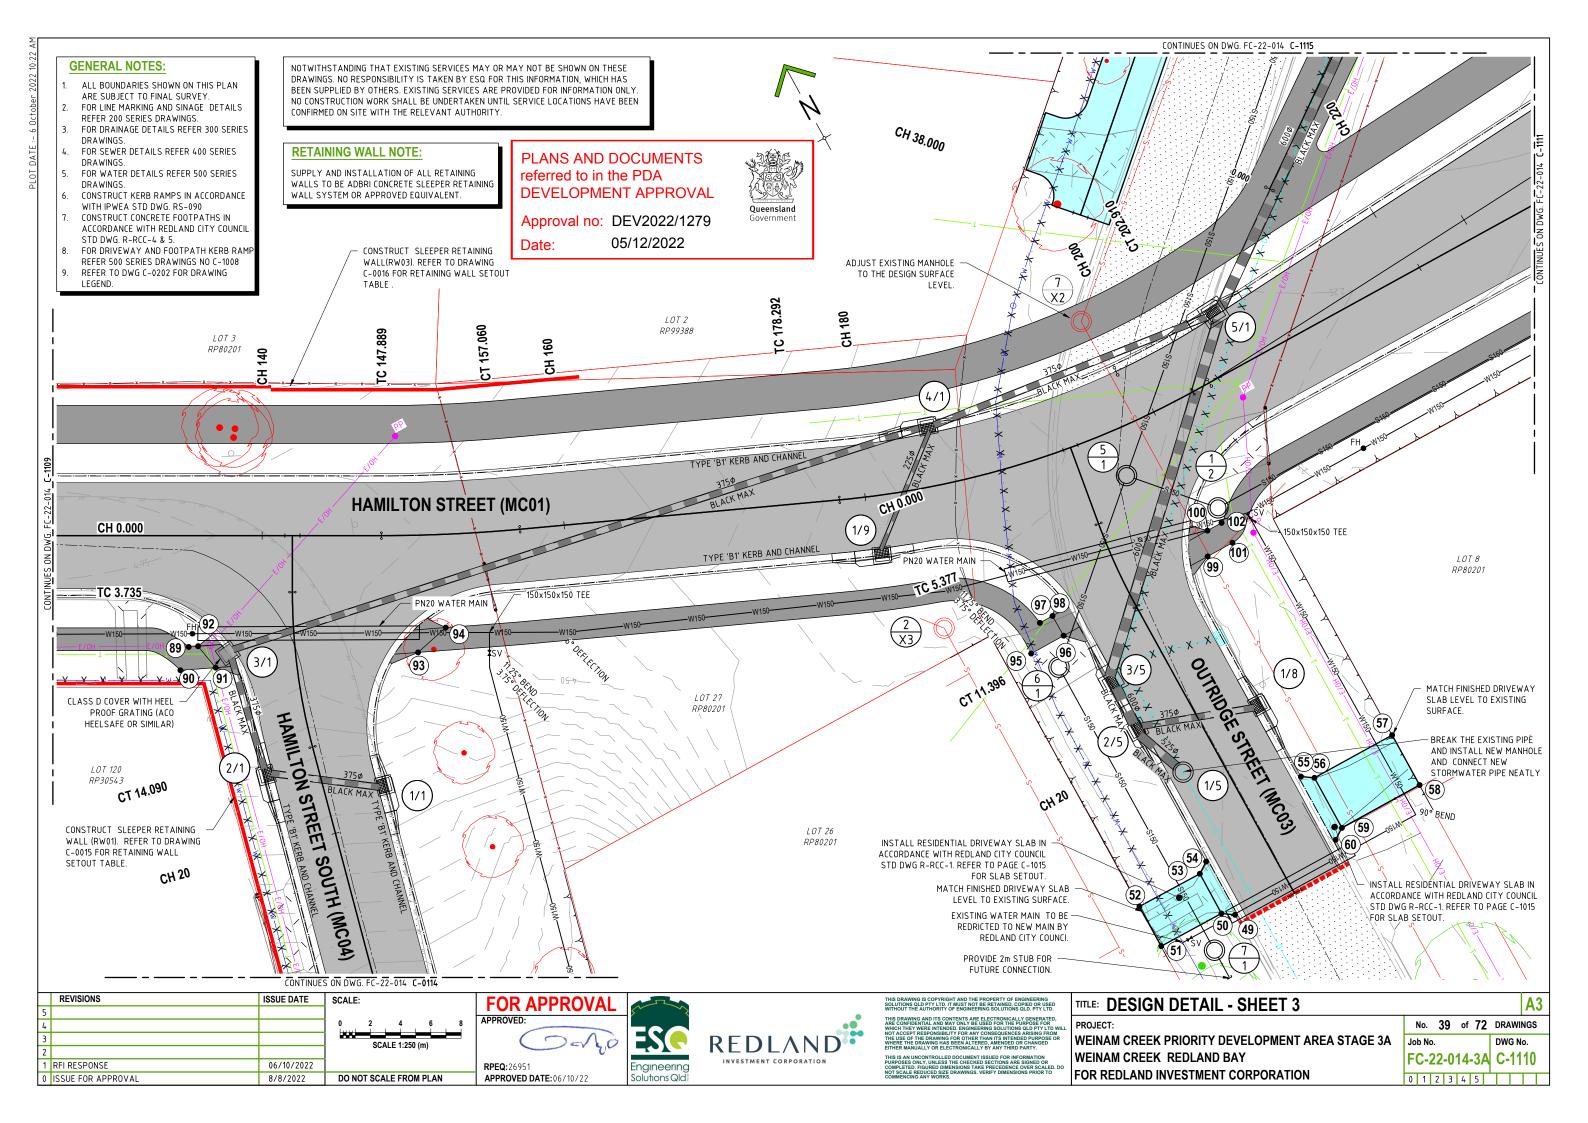


NOTWITHSTANDING THAT EXISTING SERVICES MAY OR MAY NOT BE SHOWN ON THESE DRAWINGS. NO RESPONSIBILITY IS TAKEN BY ESQ FOR THIS INFORMATION, WHICH HAS BEEN SUPPLIED BY OTHERS. EXISTING SERVICES ARE PROVIDED FOR INFORMATION ONLY NO CONSTRUCTION WORK SHALL BE UNDERTAKEN UNTIL SERVICE LOCATIONS HAVE BEEN CONFIRMED ON SITE WITH THE RELEVANT AUTHORITY.

#### **GENERAL NOTES:**

- ALL BOUNDARIES SHOWN ON THIS PLAN ARE SUBJECT TO FINAL SURVEY.
- FOR LINE MARKING AND SINAGE DETAILS REFER 200 SERIES DRAWINGS.
- FOR DRAINAGE DETAILS REFER 300 SERIES
- FOR SEWER DETAILS REFER 400 SERIES
- FOR WATER DETAILS REFER 500 SERIES DRAWINGS
- CONSTRUCT KERB RAMPS IN ACCORDANCE WITH IPWEA STD DWG. RS-090 CONSTRUCT CONCRETE FOOTPATHS IN ACCORDANCE WITH REDLAND CITY COUNCIL
- STD DWG. R-RCC-4 & 5.
  FOR DRIVEWAY AND FOOTPATH KERB RAMP REFER 500 SERIES DRAWINGS NO C-1008
- REFER TO DWG C-0202 FOR DRAWING LEGEND.

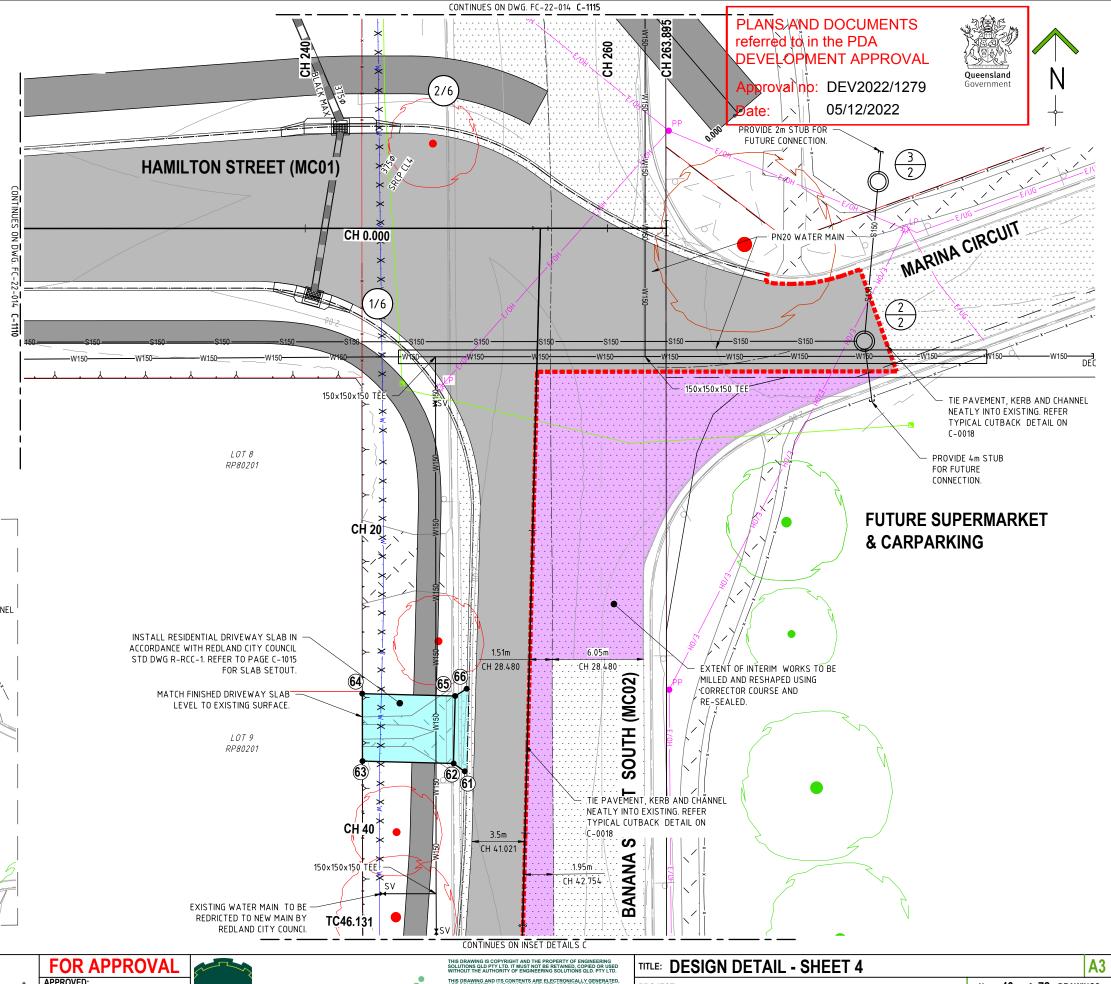

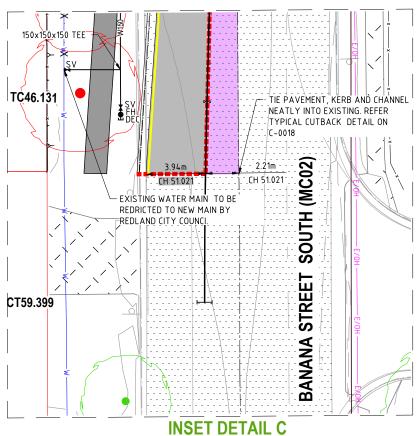

REVISIONS ISSUE DATE SCALE: SCALE 1:250 (m) 1 RFI RESPONSE 06/10/2022 0 ISSUE FOR APPROVAL 8/8/2022 DO NOT SCALE FROM PLAN

APPROVED:

APPROVED DATE: 06/10/22

RPEQ:26951








FOR REDLAND INVESTMENT CORPORATION


WEINAM CREEK REDLAND BAY


No. 40 of 72 DRAWINGS **WEINAM CREEK PRIORITY DEVELOPMENT AREA STAGE 3A** Job No. DWG No. FC-22-014-3A C-1111 0 1 2 3 4 5

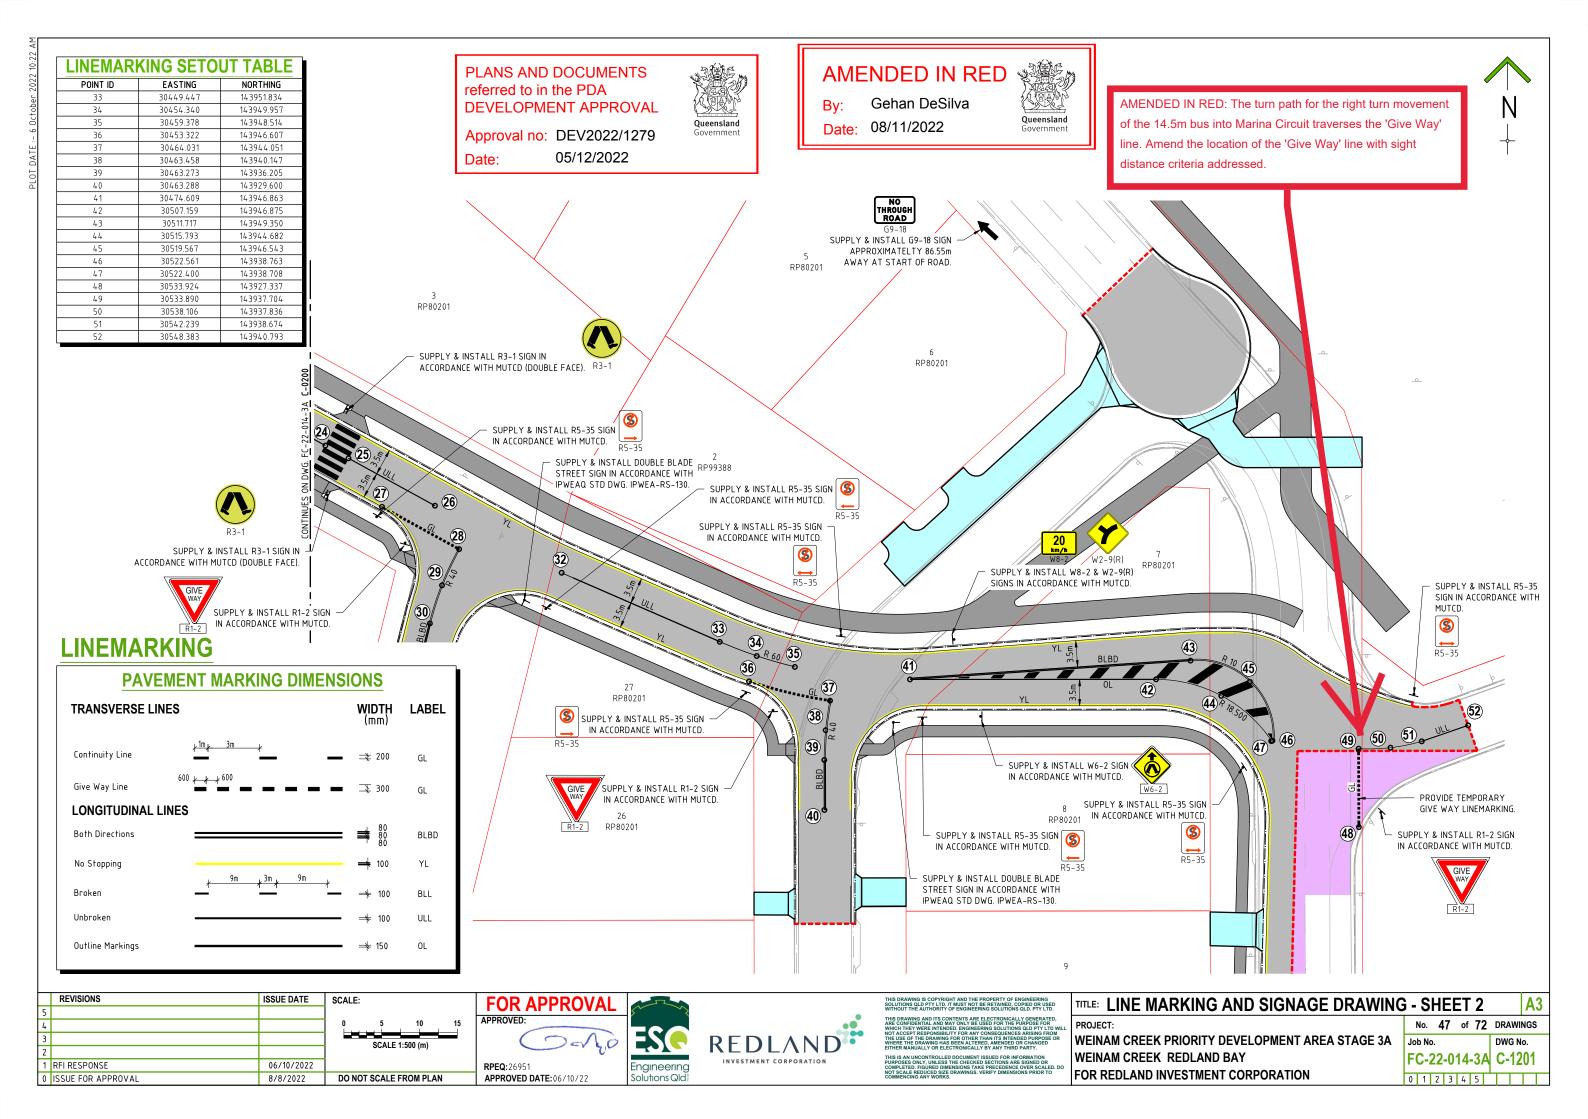


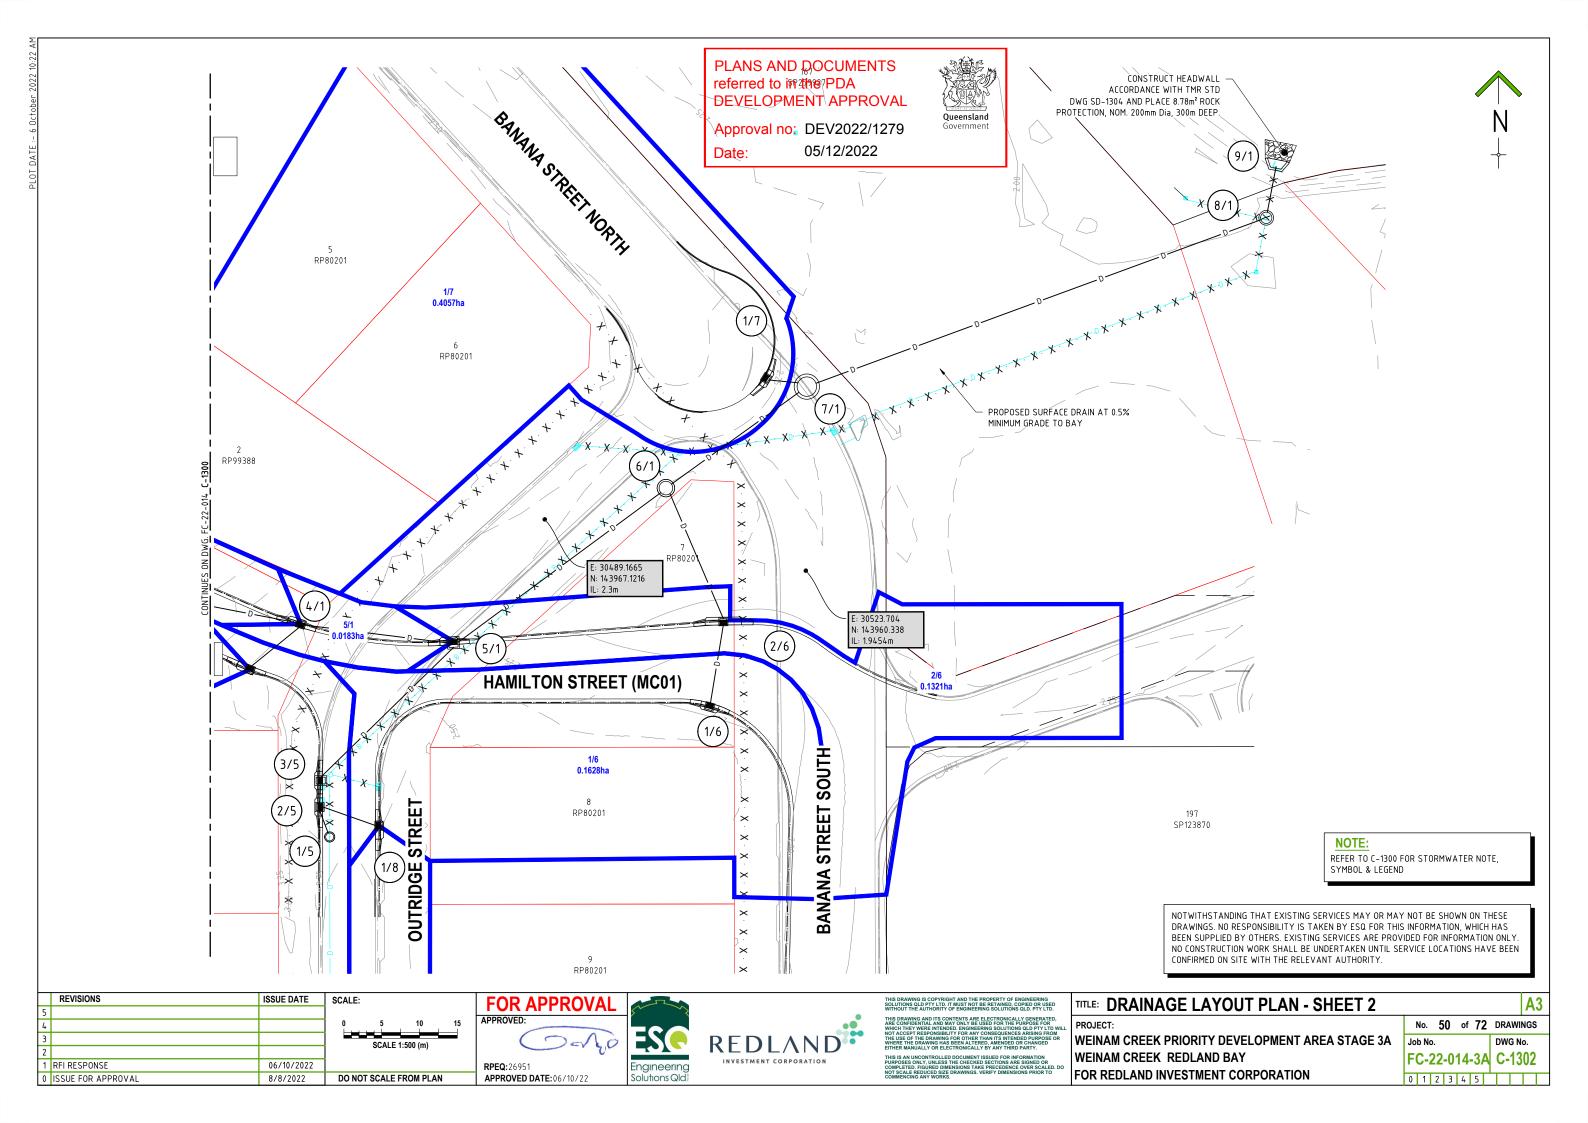

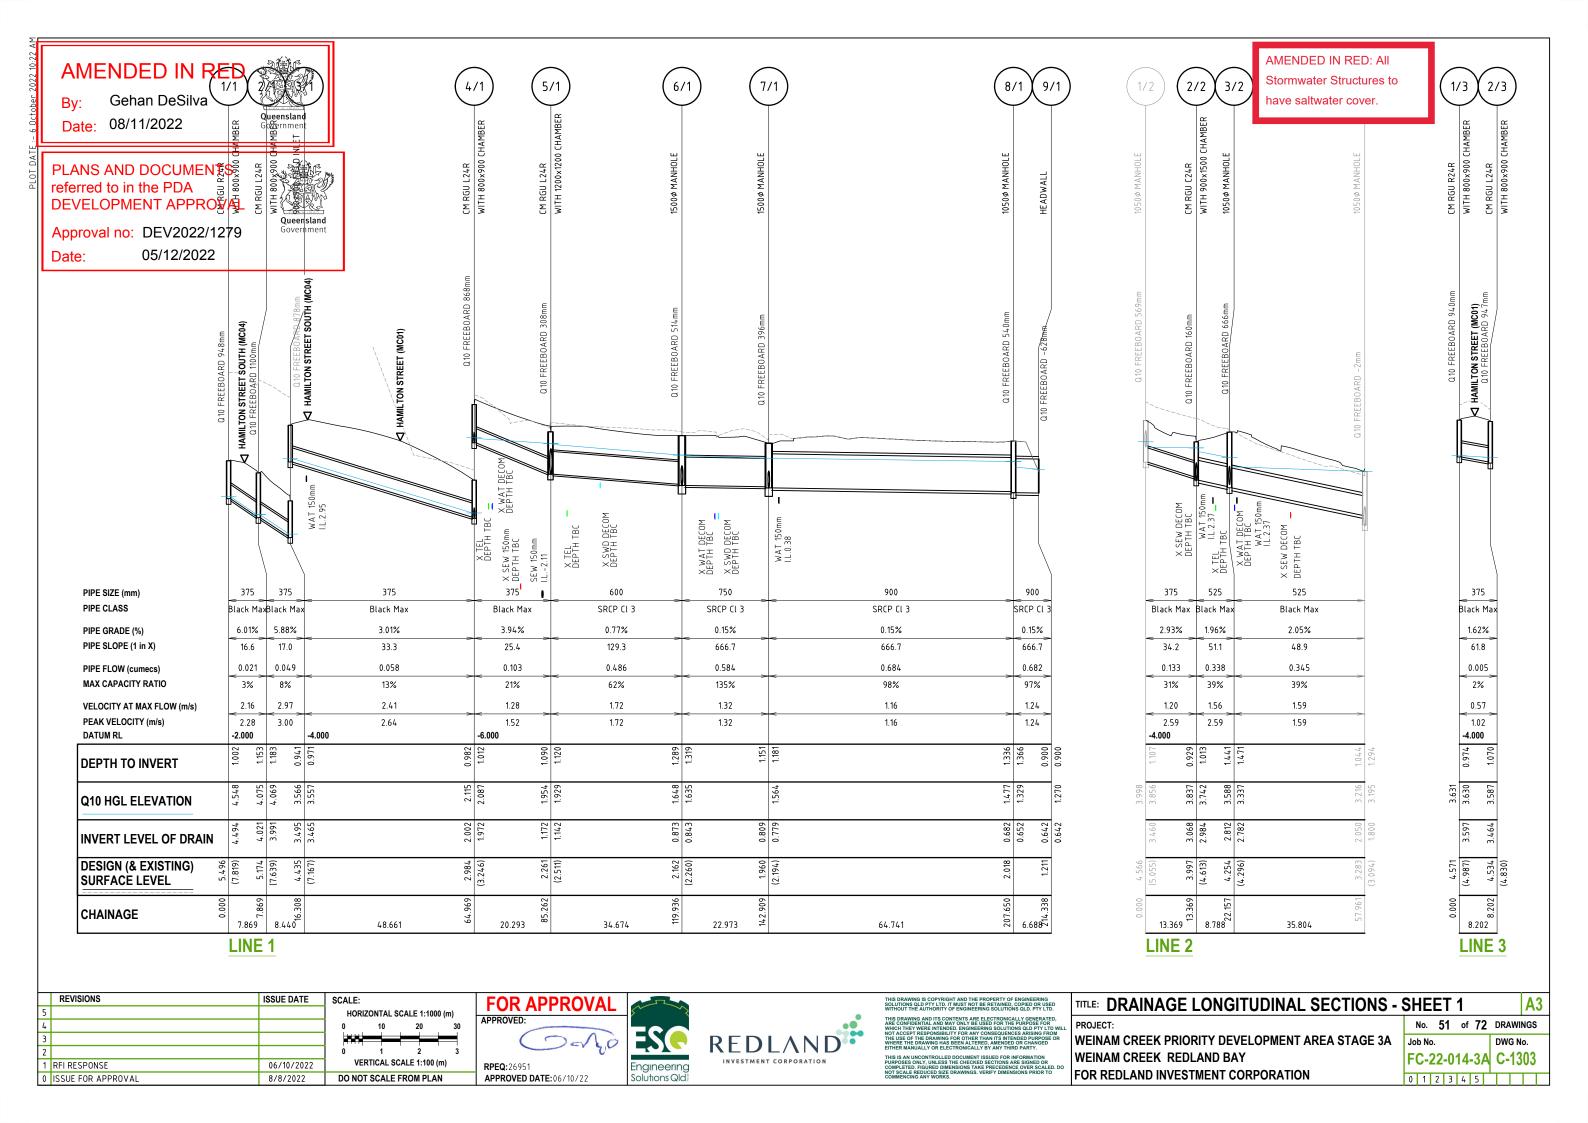

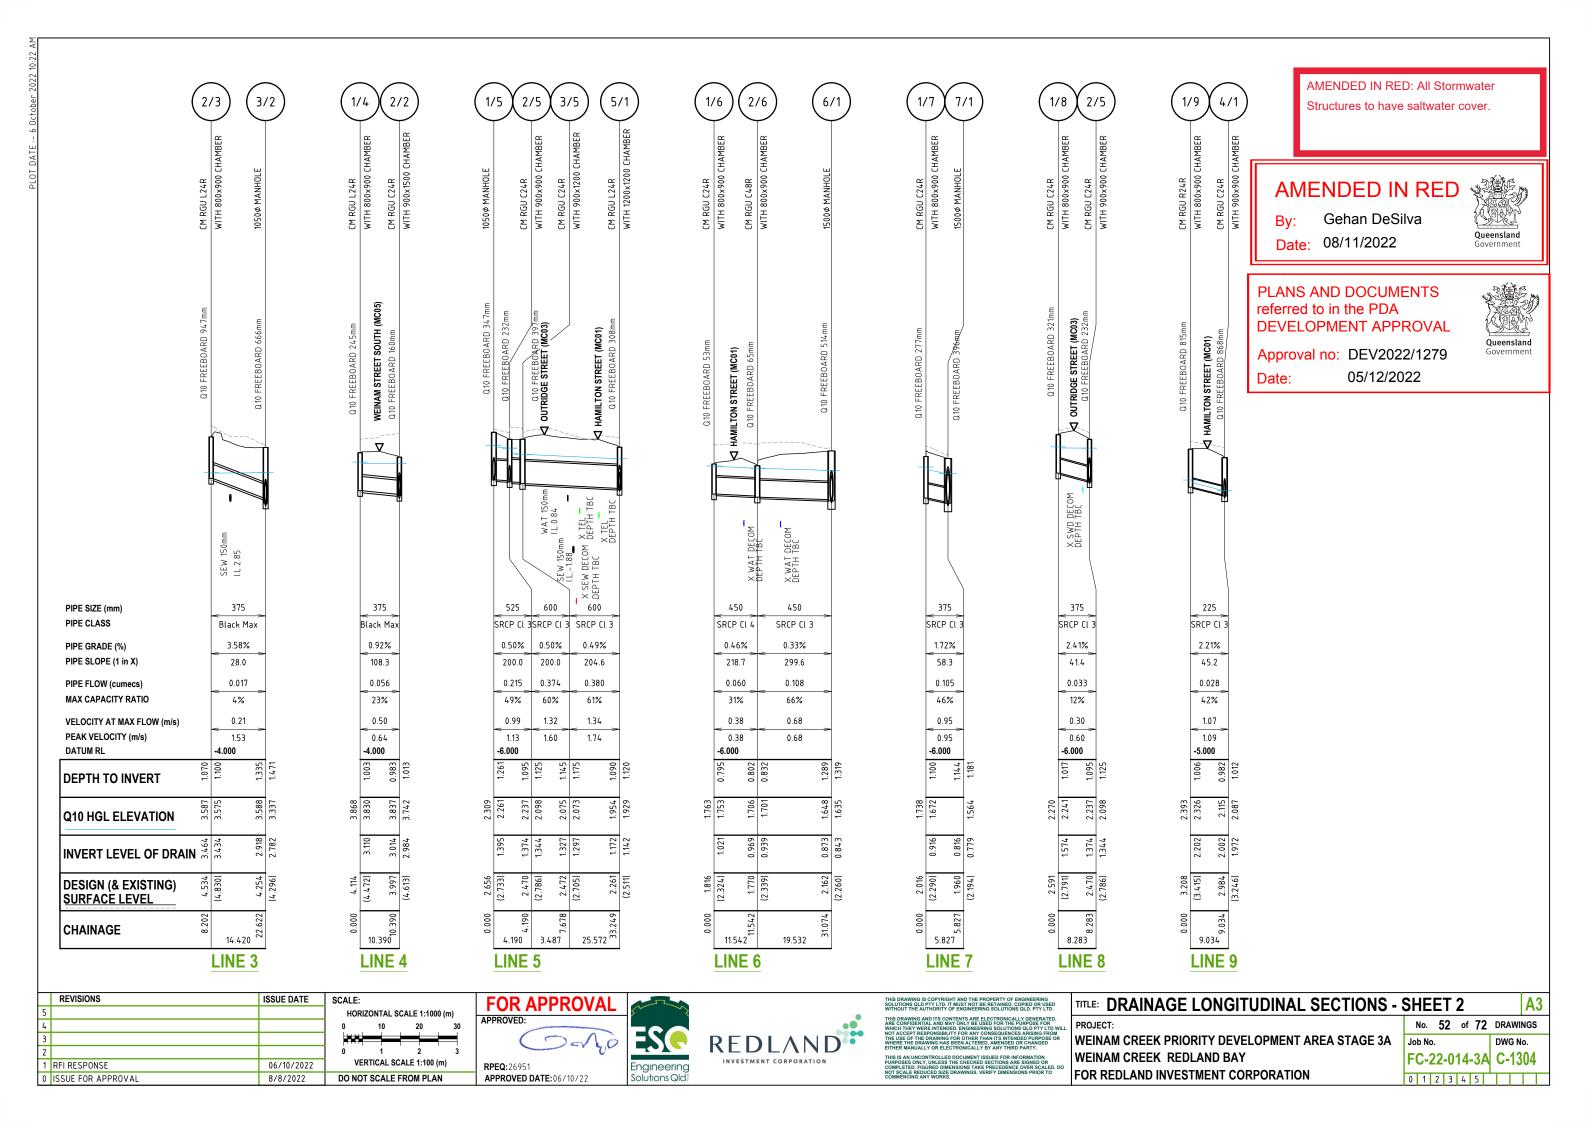

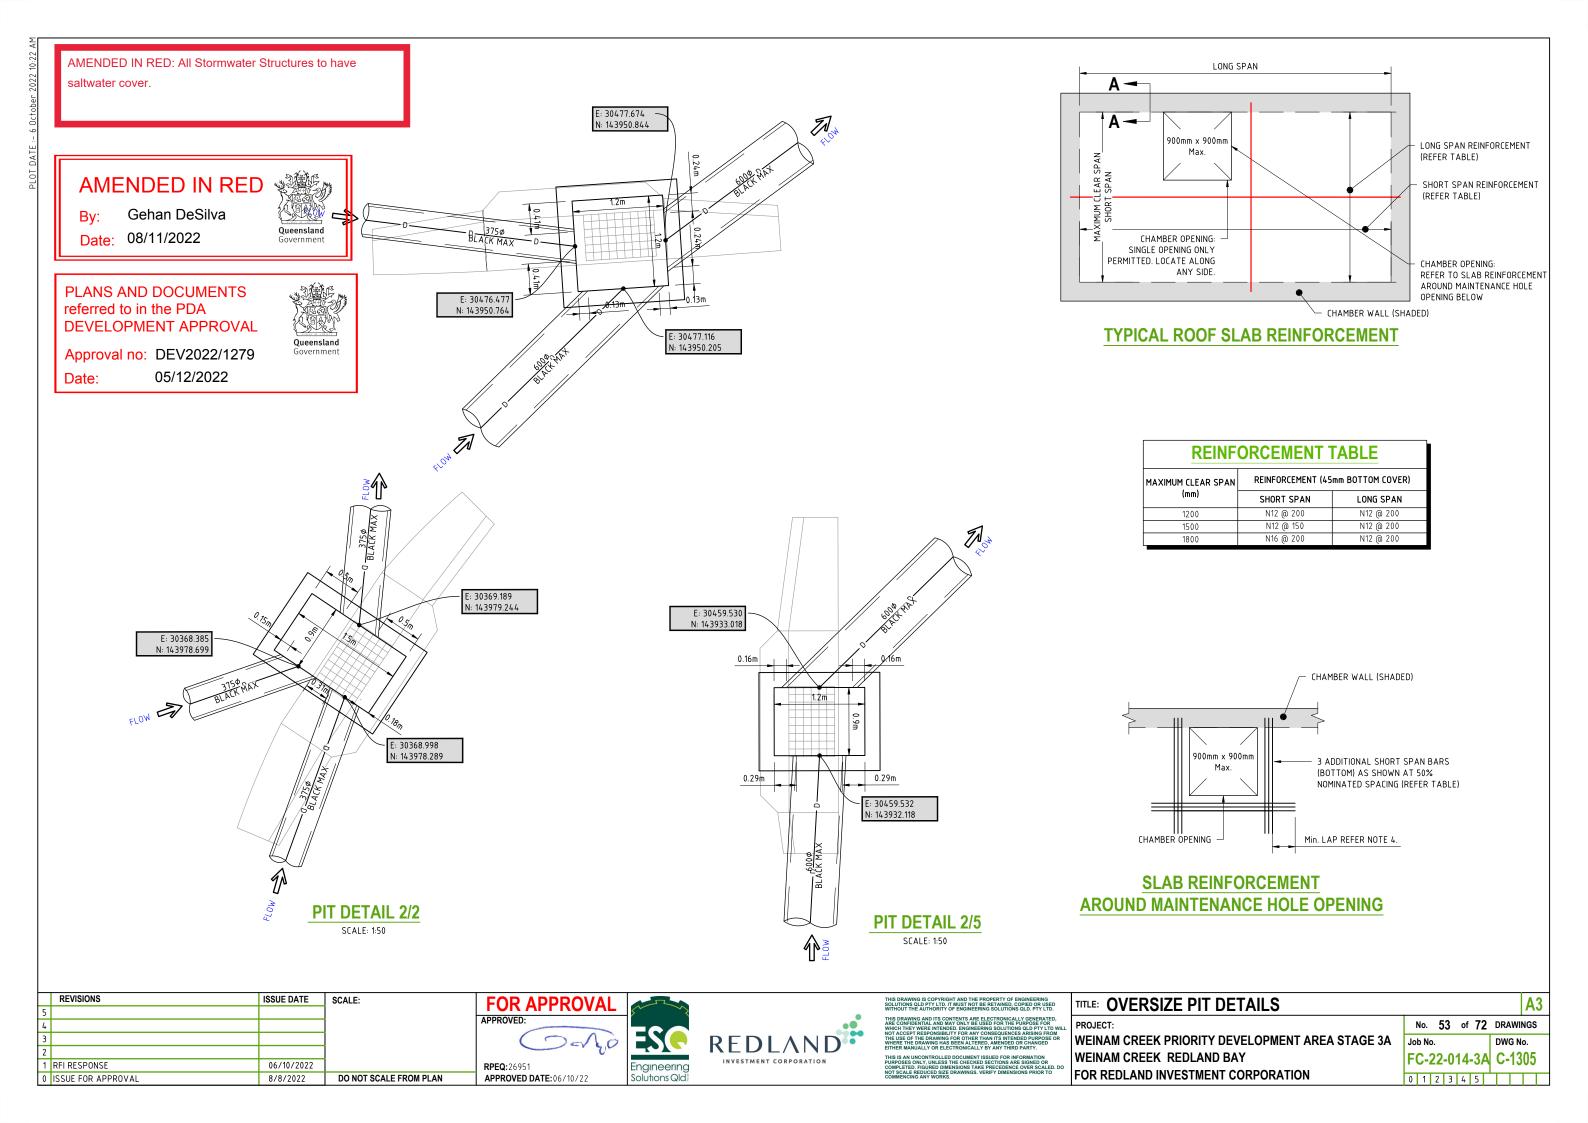

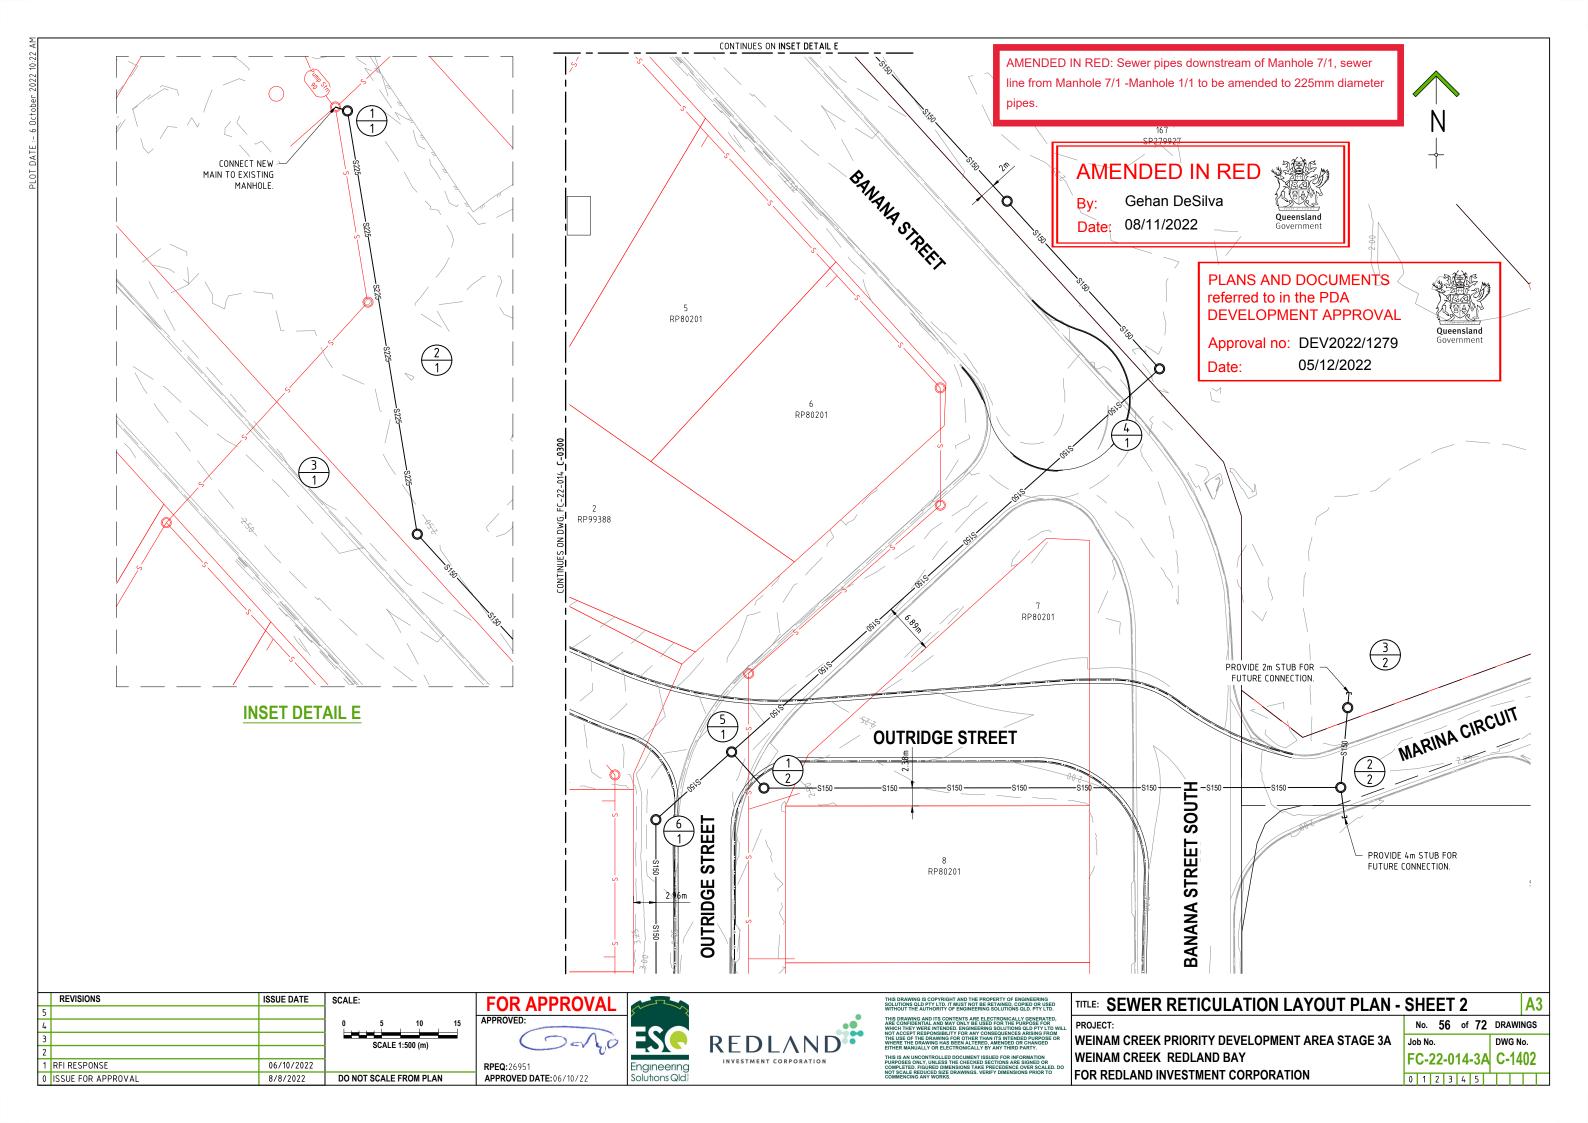

7/1 2/1 3/1 1/1 5/1 6/1 MANHOLE 1/1 to be amended to 225mm diameter pipes. JUNCTION NAME AMENDED IN RED -NE ANGLE DFLECTION Gehan DeSilva HOUSE CONNECTION TYPE Date: 08/11/2022 DOWNSTREAM DISTANCE B D.I. B .:. B ... D .:. LID TYPE PLANS AND DOCUMENTS DROP TYPE 0.03 0.03 0.03 0.03 0.03 0.03 0.03 referred to in the PDA **DEVELOPMENT APPROVAL** HAMILTON STREET (MC01) OUTRIDGE STREET (MC03) Approval no: DEV2022/1279 05/12/2022 Date: D WAT150m I.L.2.02 D SWD375m I.L.1.42 BREAK IN & CONNECT PROVIDE 2.0m STUB FOR FUTURE CONNECTION. TO EXISTING MANHOLE PIPE SIZE (mm) 225 150 150 150 150 150 PP SN8 PIPE CLASS PP SN8 PIPE GRADE (%) 0.333% 0.333% 0.556% 0.556% \_0.556% 0.556% PIPE SLOPE (1 in x) 300.299 179.851 300.297 300.302 179.856 179.857 179.860 179.857 DATUM R.L. -6.000 5.528 DEPTH TO INVERT -3.169 INVERT LEVEL 2.359 EXISTING SURFACE LEVEL 2.359 DESIGN SURFACE LEVEL 137.464 203.836 CHAINAGE 13.439 5 1.674 33.326 22.512 79.952 66.372 21.357 17.087 LINE 1 REVISIONS ISSUE DATE SCALE: **FOR APPROVAL** TITLE: SEWER LONGITUDINAL SECTIONS - SHEET 1 HORIZONTAL SCALE 1:1000 (m) APPROVED: REDLAND

INVESTMENT CORPORATION

Engineering

VERTICAL SCALE 1:100 (m)

DO NOT SCALE FROM PLAN

RPEQ:26951

APPROVED DATE: 06/10/22

06/10/2022

8/8/2022

1 RFI RESPONSE

0 ISSUE FOR APPROVAL

AMENDED IN RED: Sewer pipes downstream of Manhole 7/1, sewer line from Manhole 7/1 -Manhole





WEINAM CREEK PRIORITY DEVELOPMENT AREA STAGE 3A WEINAM CREEK REDLAND BAY FOR REDLAND INVESTMENT CORPORATION

No. 57 of 72 DRAWINGS Job No. DWG No. FC-22-014-3A C-1403 0 1 2 3 4 5

2/2 3/2 JUNCTION NAME H. ANGLE DFLECTION HOUSE CONNECTION TYPE DOWNSTREAM DISTANCE D.I. LID TYPE DROP TYPE 0.03 1.45 0.10 BANANA STREET SOUTH (MC02) HAMILTON STREET (MC01) ⇗ D WAT1 I.L.1.65 \_150\_ PIPE SIZE (mm) 150 150 PIPE CLASS ūΡVĆ uPVC uPVC 3,173% 1.000% PIPE GRADE (%) 1.000% PIPE SLOPE (1 in x) 31.519 99.959 100.004 -6.000 DATUM R.L. 2.987 **DEPTH TO INVERT** -2.049 -0.397 0.396 INVERT LEVEL .621 EXISTING SURFACE LEVEL DESIGN SURFACE LEVEL CHAINAGE 6.389 76.333 18.293 LINE 2

(2/X7 (4/X7 < 2.81 HAMILTON 1 STREET (MC01) WEINAM STREET 1 NORTH (MC06 BREAK IN & CONNECT TO EXISTING MANHOLE. RAISE MANHOLE TO MATCH DESIGN SURFACE LEVEL. BREAK IN & CONNECT TO EXISTING MANHOLE. 150 PP SN8 3.460% 28.904 -4.000 1.780 43.356 LINE 3

REVISIONS ISSUE DATE SCALE: HORIZONTAL SCALE 1:1000 (m) VERTICAL SCALE 1:100 (m) 1 RFI RESPONSE 06/10/2022 0 ISSUE FOR APPROVAL 8/8/2022 DO NOT SCALE FROM PLAN

**FOR APPROVAL** APPROVED:







			_
TITLE: SEWER	I UNCITIDINAL	SECTIONS - SHEET 2	

**WEINAM CREEK PRIORITY DEVELOPMENT AREA STAGE 3A** WEINAM CREEK REDLAND BAY FOR REDLAND INVESTMENT CORPORATION

 	_					
No.	58	of	72	DRAWI	NGS	
Job No.				DWG N	lo.	
FC-2	22-0	14-	3A	C-14	104	
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Queensland

PLANS AND DOCUMENTS

**DEVELOPMENT APPROVAL** 

Approval no: DEV2022/1279


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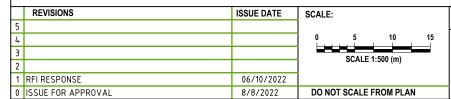
referred to in the PDA

Date:

A3

	WATER RETICULATION LIVE WORKS TABLE					
No.	DESCRIPTION	DIA.	LOCATION			
1	REDLAND WATER TO EXCAVATED TO NEW WATERMAIN PREVIOUSLY CONSTRUCTED BY CONTRACTOR AND REMOVED DEAD END CAP AND THEN CONNECTED TO EXISTING 150¢ WATERMAIN, INCLUDING INSTALLATION OF REQUIRED FITTINGS. REDLAND WATER TO BACKFILLED WATERMAIN INCLUDING TEMPORARY SURFACE RESTORATION.	150	ROAD RESERVE HAMILTON STREET ADJACENT LOT 1 ON 169111			
2	REDLAND WATER TO EXCAVATED TO NEW WATERMAIN PREVIOUSLY CONSTRUCTED BY CONTRACTOR AND REMOVED DEAD END CAP AND THEN CONNECTED TO EXISTING 150¢ WATERMAIN, INCLUDING INSTALLATION OF REQUIRED FITTINGS. REDLAND WATER TO BACKFILLED WATERMAIN INCLUDING TEMPORARY SURFACE RESTORATION.	150	ROAD RESERVE WEINAM STREET ADJACENT LOT 1 ON 169111			
3	REDLAND WATER TO EXCAVATED TO NEW WATERMAIN PREVIOUSLY CONSTRUCTED BY CONTRACTOR AND REMOVED DEAD END CAP AND THEN CONNECTED TO EXISTING 150¢ WATERMAIN, INCLUDING INSTALLATION OF REQUIRED FITTINGS. REDLAND WATER TO BACKFILLED WATERMAIN INCLUDING TEMPORARY SURFACE RESTORATION.	150	ROAD RESERVE WEINAM STREET NORTH ADJACENT LOT 2 ON RP80201			
4	REDLAND WATER TO EXCAVATED TO NEW WATERMAIN PREVIOUSLY CONSTRUCTED BY CONTRACTOR AND REMOVED DEAD END CAP AND THEN CONNECTED TO EXISTING 150¢ WATERMAIN, INCLUDING INSTALLATION OF REQUIRED FITTINGS. REDLAND WATER TO BACKFILLED WATERMAIN INCLUDING TEMPORARY SURFACE RESTORATION.	150	ROAD RESERVE HAMILTON STREET SOUTH ADJACENT LOT 8 ON RP107394			
5	REDLAND WATER TO EXCAVATED TO NEW WATERMAIN PREVIOUSLY CONSTRUCTED BY CONTRACTOR AND REMOVED DEAD END CAP AND THEN CONNECTED TO EXISTING 150¢ WATERMAIN, INCLUDING INSTALLATION OF REQUIRED FITTINGS. REDLAND WATER TO BACKFILLED WATERMAIN INCLUDING TEMPORARY SURFACE RESTORATION.	150	ROAD RESERVE OUTRIDGE STREET ADJACENT LOT 26 ON RP80201			
6	REDLAND WATER TO EXCAVATED TO NEW WATERMAIN PREVIOUSLY CONSTRUCTED BY CONTRACTOR AND REMOVED DEAD END CAP AND THEN CONNECTED TO EXISTING 150¢ WATERMAIN, INCLUDING INSTALLATION OF REQUIRED FITTINGS. REDLAND WATER TO BACKFILLED WATERMAIN INCLUDING TEMPORARY SURFACE RESTORATION.	150	ROAD RESERVE BANANA STREET NORTH ADJACENT LOT 6 ON RP80201			
7	REDLAND WATER TO EXCAVATED TO NEW WATERMAIN PREVIOUSLY CONSTRUCTED BY CONTRACTOR AND REMOVED DEAD END CAP AND THEN CONNECTED TO EXISTING 150¢ WATERMAIN, INCLUDING INSTALLATION OF REQUIRED FITTINGS. REDLAND WATER TO BACKFILLED WATERMAIN INCLUDING TEMPORARY SURFACE RESTORATION.	150	ROAD RESERVE BANANA STREET SOUTH ADJACENT LOT 9 ON RP80201			



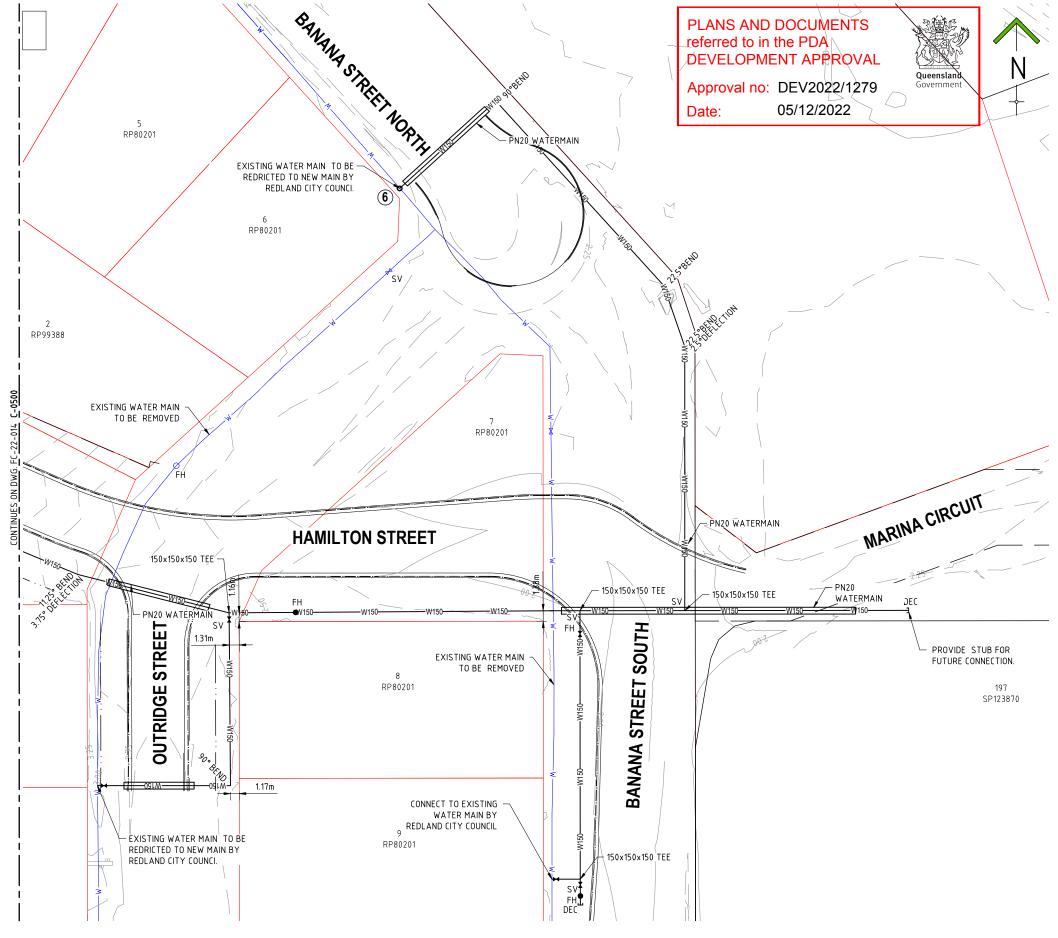

APPROVAL

APPROVED:

RPEQ:26951
APPROVED DATE:06/10/22





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ΓLE:	WATER	RETICUL	ATION I	AYOUT	PI AN -	SHEET 2	

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WEINAM CREEK PRIORITY DEVELOPMENT AREA STAGE 3A
WEINAM CREEK REDLAND BAY
FOR REDLAND INVESTMENT CORPORATION

No. 60 of 72 DRAWINGS


Job No. DWG No.

FC-22-014-3A C-1501

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# Appendix D ADG Preliminary Plans



FULL SIZE ON ORIGINAL D 10 20 30 40 50 60 70 80 90 1
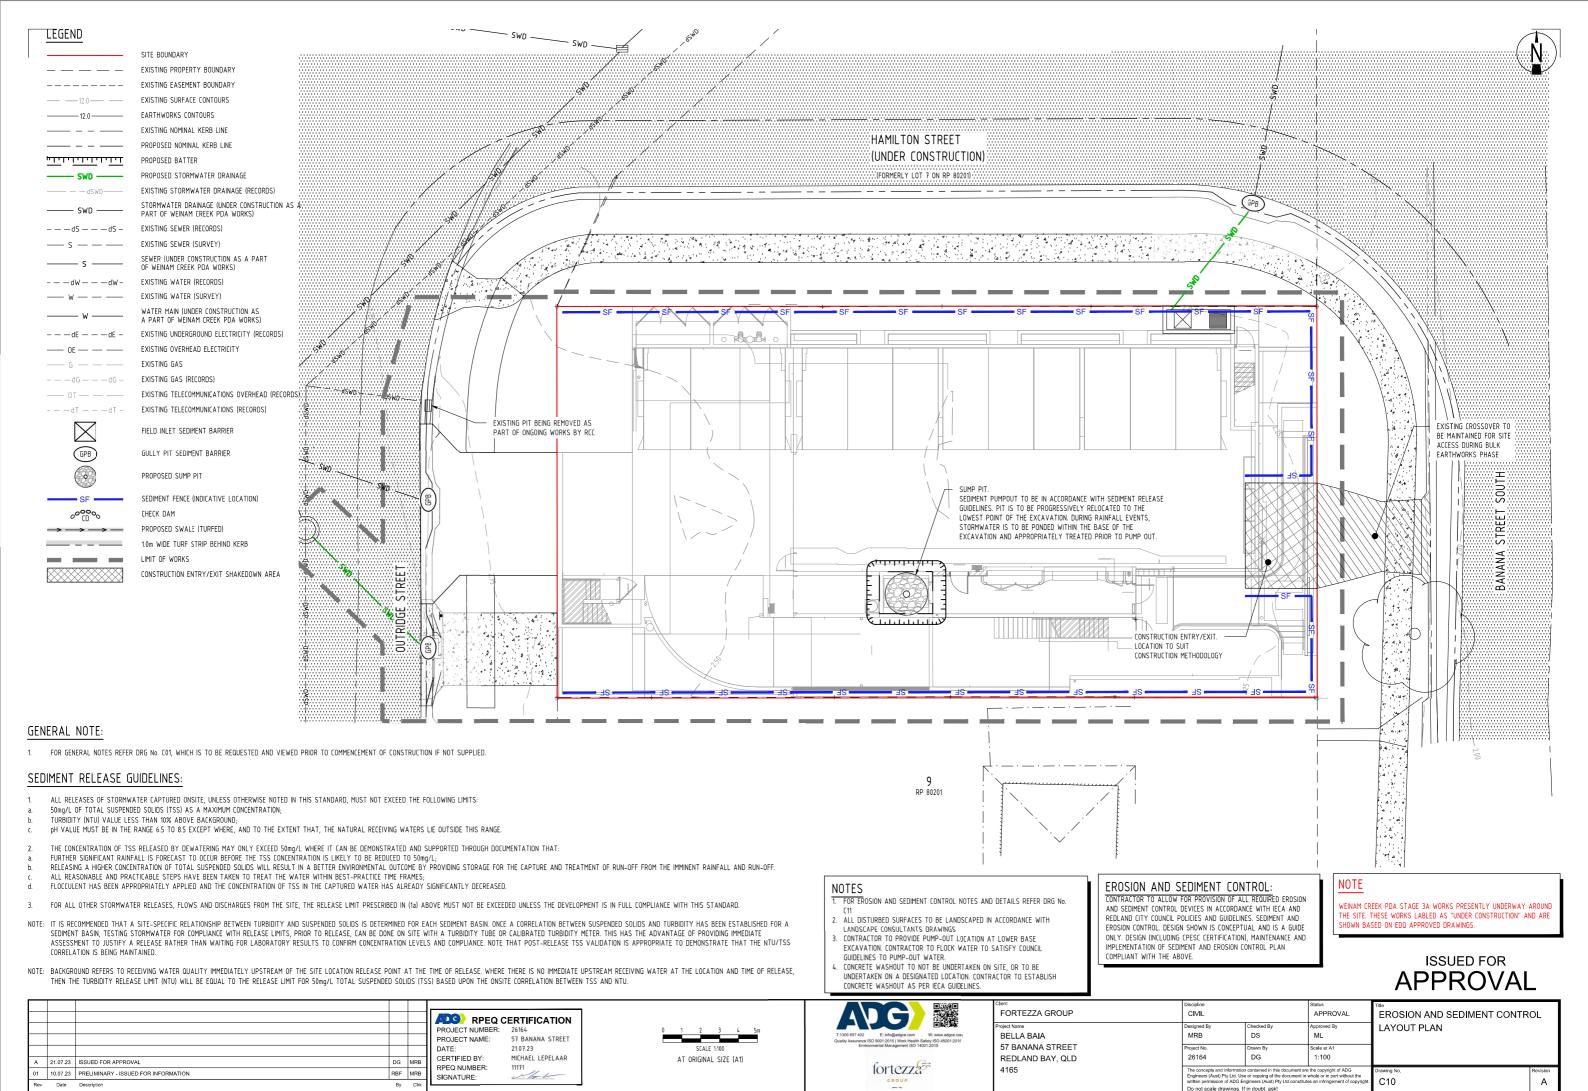
#### NOTES:

#### SEDIMENT CONTROL

- ALL EROSION AND SEDIMENT CONTROL MEASURES TO BE IN ACCORDANCE WITH INTERNATIONA EROSION CONTROL ASSOCIATION (IECA) AUSTRALIA GUIDELINES AND THE SPECIFICATIONS.
- EROSION AND SEDIMENT CONTROL DETAILS SHOWN ARE MINIMUM REQUIREMENTS. IT IS THE CONTRACTORS RESPONSIBILITY TO INSTALL ADDITIONAL CONTROL MEASURES AS DEEMED NECESSARY THROUGHOUT CONSTRUCTION.
- THE CONTRACTOR IS RESPONSIBLE TO MAINTAIN ALL SEDIMENT CONTROL DEVICES IN A FUNCTIONAL ORDER AND REPLACE ALL BLOCKED SEDIMENT DEVICES AS REQUIRED UNTIL SUCCESSFUL OFF MAINTENANCE OF WORKS.
- 4. CONSTRUCTION OF ALL SEDIMENT MANAGEMENT DEVICES TO THE SATISFACTION OF THE SUPERINTENDENT. SHALL BE COMPLETED AND EFFECTIVE PRIOR TO:
  - a. STRIPPING OF TOPSOIL AND GRASS.
  - b. BULK EARTHWORKS TO THE SITE.
  - SERVICES INSTALLATION.
  - d. PAVEMENT CONSTRUCTION
- ALL SEDIMENT MANAGEMENT MEASURES ARE TO REMAIN IN PLACE UNTIL INSTRUCTION IS RECEIVED IN WRITING FROM THE SUPERINTENDENT TO REMOVE ALL OR PART OF THE SILT CONTROL APPLICATIONS.
- THE BULK EARTHWORKS AND SEDIMENT CONTROL LAYOUT PLAN SHALL BE READ IN CONJUNCTION WITH THE APPROVED DRAWINGS.
- PRIOR TO COMMENCEMENT OF CONSTRUCTION APPROVAL IS TO BE OBTAINED FROM THE SUPERINTENDENT FOR THE LOCATION OF THE SITE ACCESS POINT AND WASH DOWN AREA WHICH ARE TO BE MAINTAINED THROUGHOUT THE CONSTRUCTION PERIOD.
- 8. IF EROSION AND SEDIMENT CONTROL DEVICES HAVE BEEN FOUND TO BE DIFFERENT OR FAILED IN SERVICE, CORRECTIVE ACTION IS TO BE UNDERTAKEN IMMEDIATELY WHICH MAY INCLUDE AMENDMENTS' ADDITIONS TO THE ORIGINAL APPROVED EROSION CONTROL PLANS. SUCH AMENDMENTS ARE TO BE APPROVED BY SUPERINTENDENT, IF DEEMED NECESSARY AND RELEVANT.

### OVERALL

- TEMPORARY DRAINAGE CONTROL FLOW SHOULD BE DIVERTED AROUND THE WORK SITE WHERE POSSIBLE.
- ALL DRAINAGE EROSION AND SEDIMENT CONTROLS TO BE INSTALLED AND BE OPERATIONAL BEFORE COMMENCING UP-SLOPE EARTHWORKS.
- IN AREAS WHERE RUNOFF TURBIDITY IS TO BE CONTROLLED, EXPOSED SURFACES TO BE EITHER MULCHED, COVERED WITH EROSION CONTROL BLANKETS OR TURFED IF EARTHWORKS ARE EXPECTED TO BE DELAYED FOR MORE THAN 14 DAYS.

#### SEDIMENT FENCE

10. FOR SEDIMENT FENCE STANDARD DETAIL AND SPECIFICATION REFER TO INTERNATIONAL EROSION CONTROL ASSOCIATION AUSTRALASIA (IECA) BEST PRACTICES STANDARD DRAWINGS SF-01 AND SF-02 SEDIMENT FENCE.

#### TEMPORARY CONSTRUCTION ENTRY/EXIT

FOR CONSTRUCTION ENTRY / EXIT STANDARD DETAIL AND SPECIFICATION REFER TO INTERNATIONAL EROSION CONTROL ASSOCIATION AUSTRALASIA (IECA) BEST PRACTICES STANDARD DRAWINGS EXIT-01 AND EXIT-02 CONSTRUCTION EXIT - ROCK PAD (CONSTRUCTION SITES ONLY), EXIT-03 - ROCK PADS FOR BUILDING SITES AND EXIT-04 AND EXIT-05 CONSTRUCTION EXIT-

#### KERB INLET

FOR KERB INLET STANDARD DETAIL AND SPECIFICATION REFER TO INTERNATIONAL EROSION CONTROL ASSOCIATION AUSTRALASIA (IECA) BEST PRACTICES STANDARD DRAWING ESC-03 KERB INLET SEDIMENT TRAPS.

#### CHECK DAMS

FOR CHECK DAM STANDARD DETAIL AND SPECIFICATION REFER TO INTERNATIONAL EROSION CONTROL ASSOCIATION AUSTRALASIA (IECA) BEST PRACTICES STANDARD DRAWING RCD-01 CHECK

#### REVEGETATION

FOR REVEGETATION STANDARD SPECIFICATION REFER TO INTERNATIONAL EROSION CONTROL ASSOCIATION AUSTRALASIA (IECA) BEST PRACTICES STANDARD DRAWING R-01 REVEGETATION

#### FIELD INLET

15. FOR FIELD INLET STANDARD DETAIL AND SPECIFICATION REFER TO INTERNATIONAL EROSION CONTROL ASSOCIATION AUSTRALASIA (IECA) BEST PRACTICES STANDARD DRAWING ESC-02 GRATED STORMWATER (FIELD) INLET SEDIMENT TRAP.

21.07.23 ISSUED FOR APPROVAL

10.07.23 PRELIMINARY - ISSUED FOR INFORMATION

- FOR EROSION AND SEDIMENT CONTROL LAYOUT
- PLAN REFER DRG No. C10 CONTRACTOR TO PROVIDE FINAL ESC DESIGN TO SUIT PROPOSED CONSTRUCTION METHODOLOGY

#### OPERATION AND MAINTENANCE

IN ACCORDANCE WITH RCC ESC GUIDELINES, ALL ESC MEASURES SHALL BE INSPECTED:

AT LEAST DAILY (WHEN WORK IS OCCURRING ON SITE) OR WEEKLY (WHEN WORK IS NOT OCCURRING ON SITE

WITHIN 24 HOURS OF EXPECTED RAIN; AND

WITHIN 18 HOURS OF A RAINFALL EVENT (I.E. AN EVENT OF SUFFICIENT INTENSITY AND DURATION TO MOBILISE SEDIMENT ON SITE).

CONSTRUCTION SITE

UNBOUND PAVEMENT MATERIAL (GRAVEL) TO

MRS11.05, EXCLUDE MATERIAL FINER THAN AS

GRADING B. TABLE 9 OF DMR SPECIFICATION

GEOFABRIC FABRIC

BIDIM A24 OR

RUNOFF TO BE DIRECTED

SIEVE 2.36mm.

TO A SEDIMENT TRAP

17. IN ACCORDANCE WITH RCC ESC GUIDELINES, MAINTENANCE OF ESC MEASURES SHALL OCCUR IN ACCORDANCE WITH THE FOLLOWING TABLE:

#### MAINTENANCE SCHEDULE

ESC MEASURE	MAINTENANCE TRIGGER	TIMEFRAME FOR COMPLETION OF MAINTENANCE
SEDIMENT BASINS	WHEN SETTLED SEDIMENT EXCEEDS THE VOLUME OF THE SEDIMENT STORAGE ZONE (SEE COUNCIL'S SEDIMENT BASIN DESIGN GUIDELINES)	WITHIN 7 DAYS OF THE INSPECTION
OTHER ESC MEASURES	THE CAPACITY OF ESC MEASURES FALLS BELOW 75%	BY THE END OF THE DAY

#### **GENERAL**

CIVIL CONTRACTOR IS TO PROVIDE AN UPDATED PROGRAM OF ESC MAINTENANCE AND CONTROL OF ALL STAGES OF WORK FOR APPROVAL BY THE SUPERINTENDENT.


#### PUMP-OUT NOTES:

COLLECTED STORMWATER IS TREATED WITH AN APPROPRIATE FLOCCULATING AGENT PRIOR TO PUMP OUT BY LICENSED CONTRACTOR AFTER EVERY RAIN EVENT. SEDIMENT TO BE CLEANED OUT ON REGULAR BASIS.

#### IECA STANDARD DRAWINGS REGISTER

DRAWING NUMBER	DRAWING DESCRIPTION
EXIT-01	CONSTRUCTION EXIT - ROCK PAD
EXIT-02	CONSTRUCTION EXIT - ROCK PAD
EXIT-03	ROCK PADS FOR BUILDING SITES
CD-01	CATCH DRAINS
CD-02	CATCH DRAINS (EARTH LINED)
RCD-01	CHECK DAMS
FF-01	FILTER FENCE
SF-01	SEDIMENT FENCE
SF-02	SEDIMENT FENCE
ESC-02	GRATED STORMWATER (FIELD) INLET SEDIMENT TRAP
ESC-03	KERB INLET SEDIMENT TRAPS
R-01	REVEGETATION - GENERAL
SP-01	SUMP PITS
L0G-01	GEO LOGS (COIR LOGS)

\*DRAWINGS TO BE READ IN CONJUNCTION WITH INTERNATIONAL FROSION CONTROL ASSOCIATION AUSTRALASIA (IECA) BEST PRACTICES STANDARD DRAWINGS AND SPECIFICATIONS.

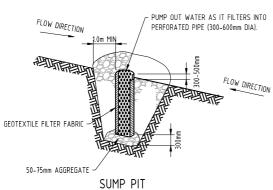

RPEQ CERTIFICATION

57 BANANA STREET

MICHAEL LEPELAAR

21.07.23

11171

PROJECT NUMBER:

PROJECT NAME:

CERTIFIED BY:

RPEQ NUMBER:

SIGNATURE

RBF MRB

### SEDIMENT FENCE DETAIL


#### **APPROVAL** FORTEZZA GROUP CIVII APPROVAL EROSION AND SEDIMENT CONTROL NOTES AND DETAILS MRB DS MI 26164 DG 1:50

SAND BAG CHECK DAM SILT FENCE ON BACK OF KERB-

SANDBAGS

PROVIDE SAND BAGS ACROSS FLOW PATH. PROVIDE TURF AROUND SAND BAGS, TO A MINIMUM OF 1m IN

FRONT AND 2m BEHIND. EXTENT TO BE DETERMINED ON SITE BY SUPERINTENDENT.

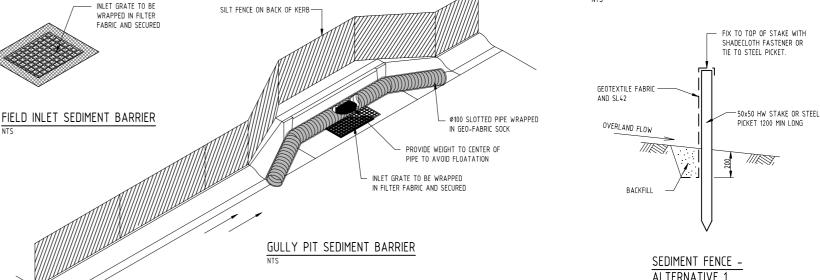


CATTLE GRID 3.0m NOM WIDTH

SET 300mm ABOVE GROUND

TEMPORARY CONSTRUCTION ENTRY/EXIT

**ALTERNATIVE 1** TUOHTIW) XAM 000F SL42 FABRIC, 2000 MAX C)

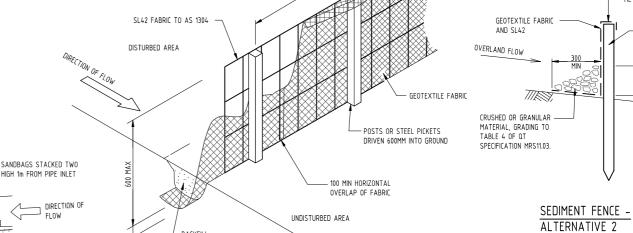

HEADWALL INLET SEDIMENT PROTECTION

HEADWALL TYPE VARIES

fortezza?

FI OW

4165

L BACKFILL

BELLA BAIA 57 BANANA STREET REDLAND BAY, QLD

C11

**ISSUED FOR** 

EXTENT AND SETOUT OF CHECK DAMS TO BE

PROPOSED ON SITE BY CONTRACTOR TO THE

FIX TO TOP OF STAKE WITH SHADECLOTH FASTENER OR


50x50 HW STAKE OR STEEL


PICKET 1200 MIN LONG


11123


TIE TO STEEL PICKET.

SATISFACTION OF THE SUPERINTENDENT

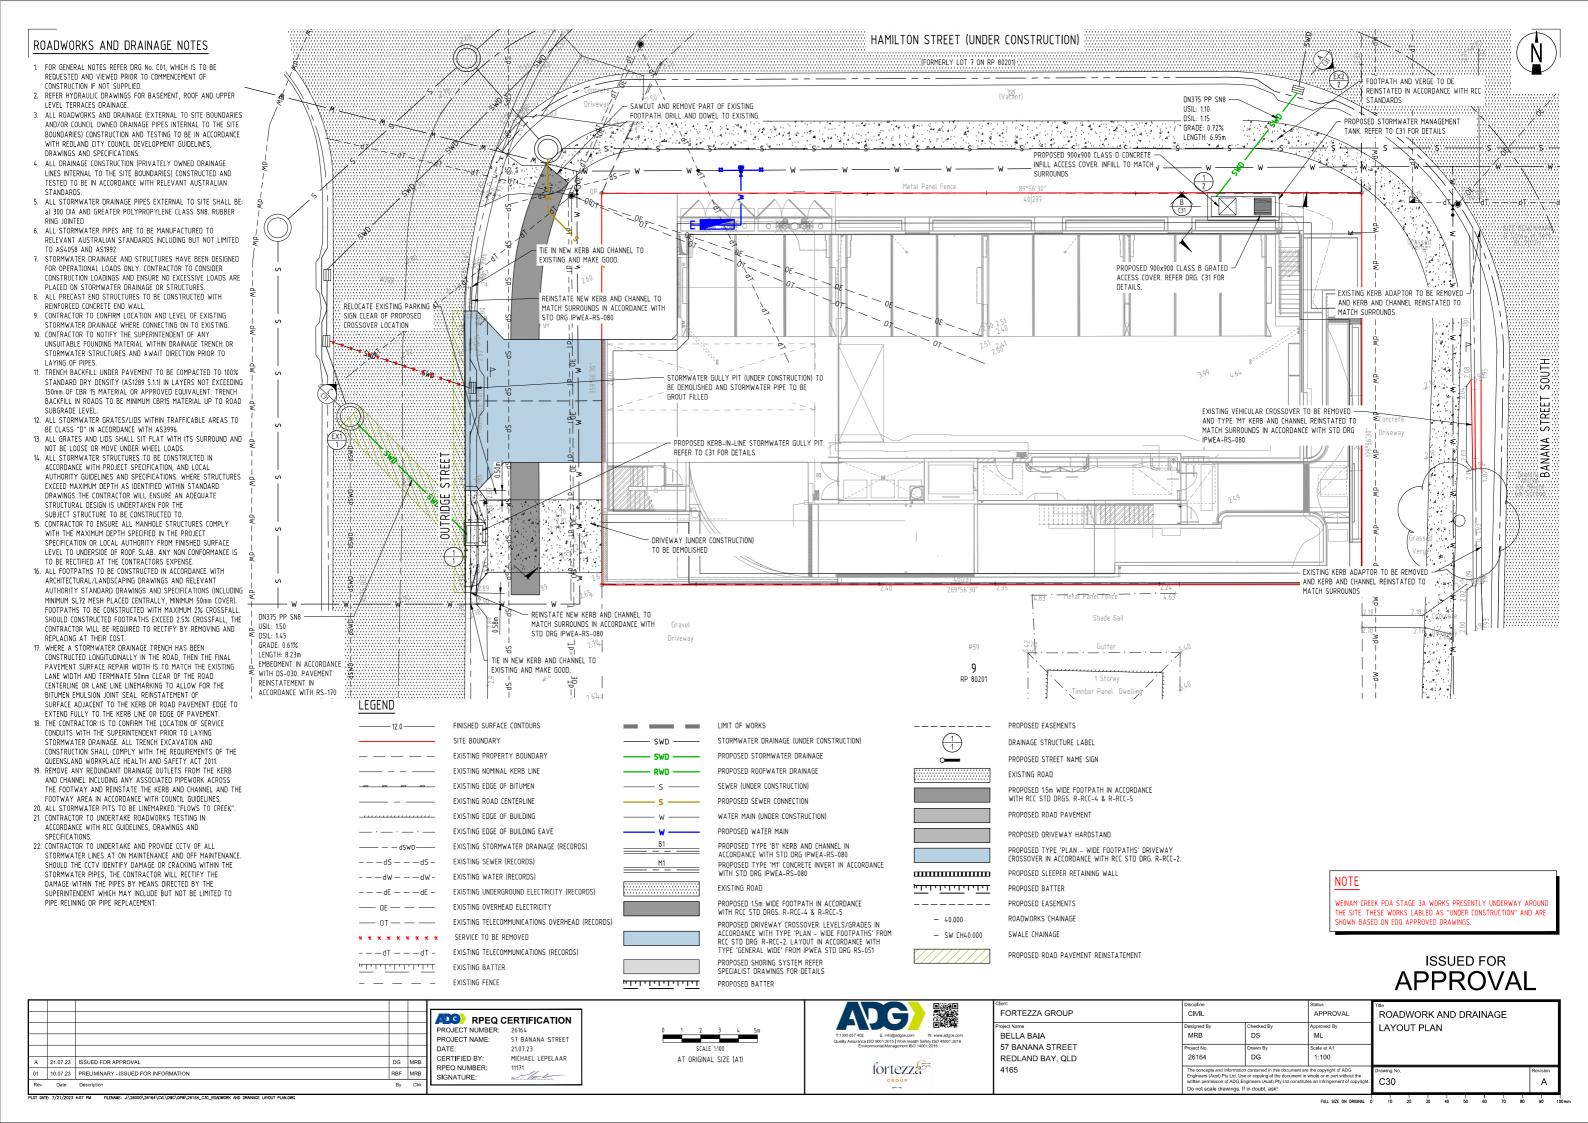

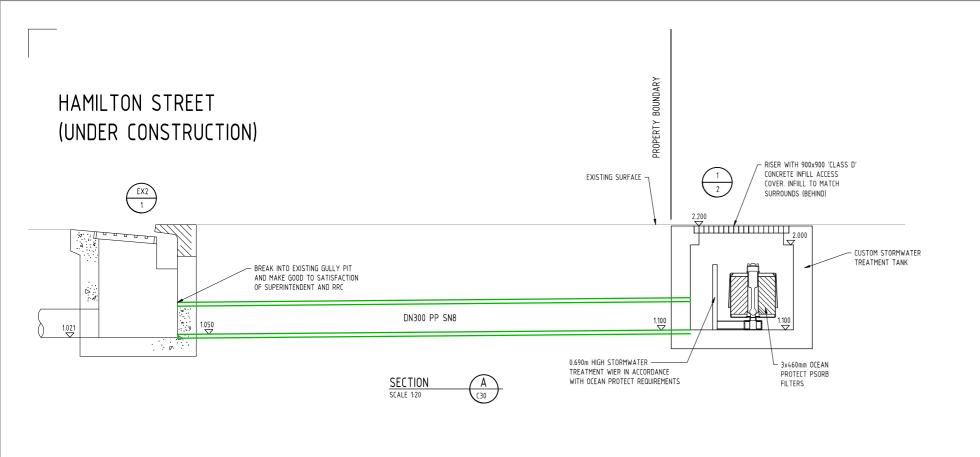

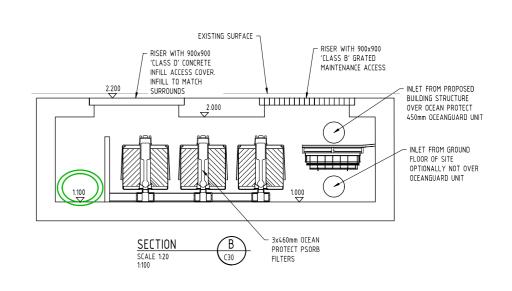

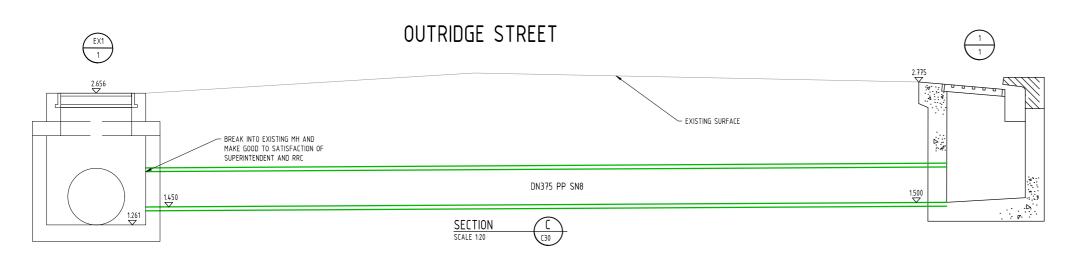

RPEQ CERTIFICATION
PROJECT NUMBER: 26164

PROJECT NAME:

CERTIFIED BY:

RPEQ NUMBER:

SIGNATURE:

RBF MRB

57 BANANA STREET

21.07.23 MICHAEL LEPELAAR



AT ORIGINAL SIZE (A1)

STD IPWEA GULLY PIT 1/1 SETOUT DETAILS (LIL - ON-GRADE PIT - M1 KERB)

SCALE 1:25 @ A1

NOTE: DIMENSIONS IN MILLIMETRES

A 21.07.23 ISSUED FOR APPROVAL

01 10.07.23 PRELIMINARY - ISSUED FOR INFORMATION


TYPICAL KERB REPLACEMENT DETAIL

	G	
	E: info@adgce.com 9001:2015   Work Health : ental Management ISO 14	
1	fortezza	À.

Client	Discipline		Status	Title
FORTEZZA GROUP	CIVIL		APPROVAL	R
Project Name	Designed By	Checked By	Approved By	lΝ
BELLA BAIA	MRB	DS	ML	· ·
57 BANANA STREET	Project No.	Drawn By	Scale at A1	1
REDLAND BAY, QLD	26164	DG	1:100	
4165		n contained in this document are		Draw

ROADWORK AND DRAINAGE NOTES AND DETAILS C31

ISSUED FOR **APPROVAL** 

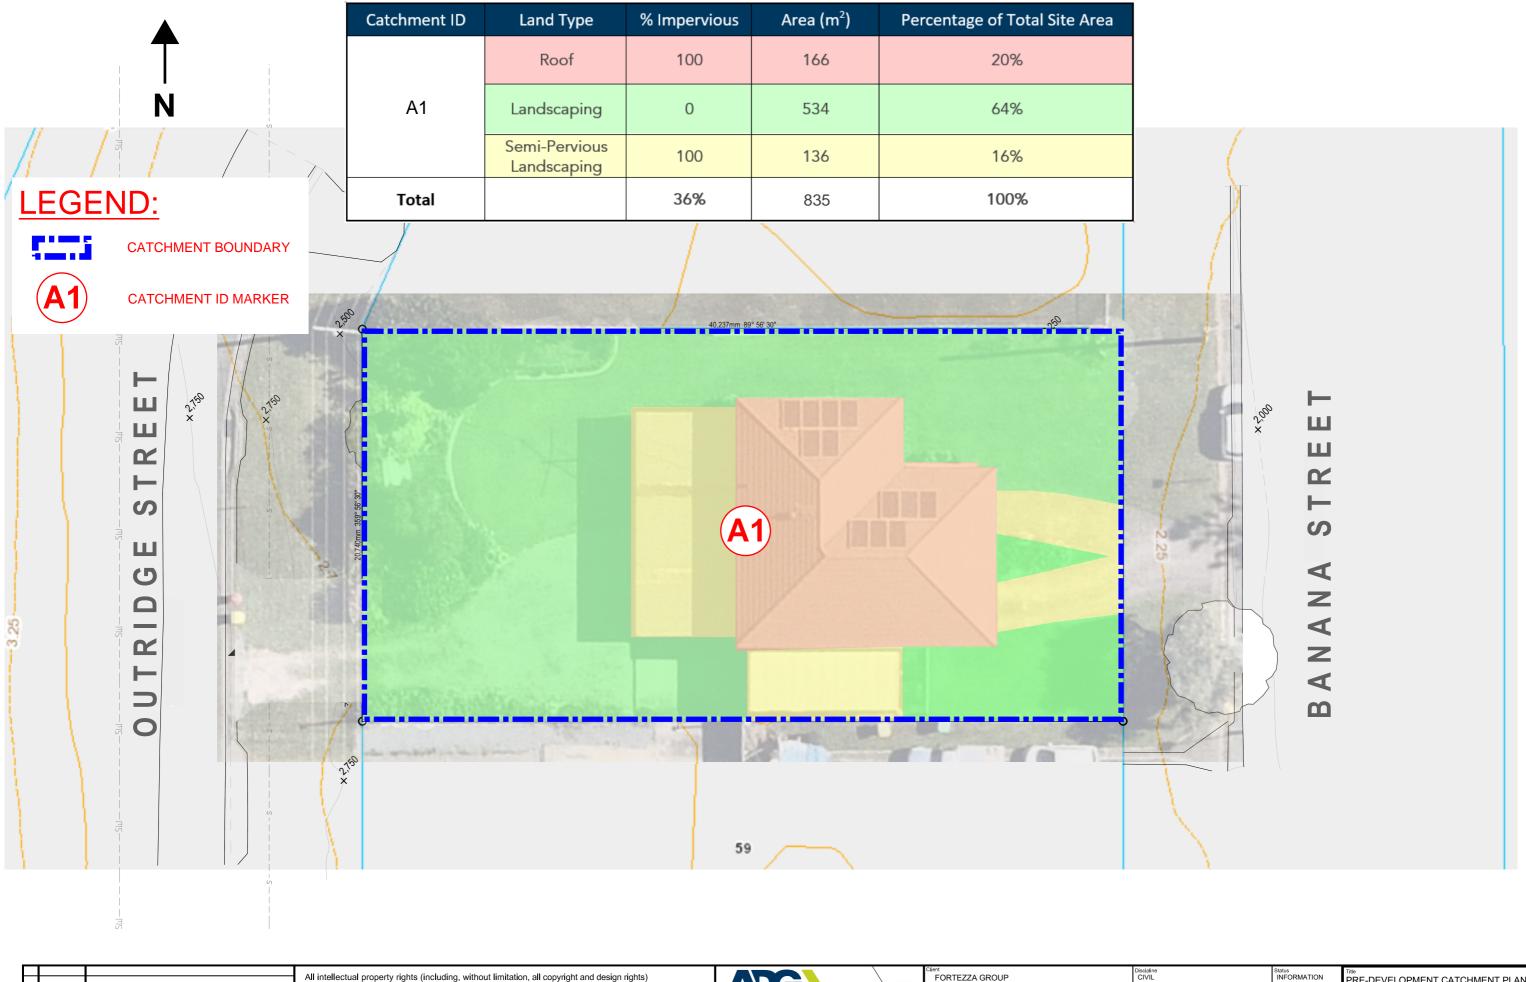

# **LEGEND**:

**CATCHMENT BOUNDARY** 



**CATCHMENT ID MARKER** 

PROPOSED TREATMENT TANK

PROPOSED STORMWATER PIPE

# HAMILTON STREET

**Catchment ID** 

B1

(Directed into Stormsack upstream

of Stormfilters)

(Discharges directly into Stormfilters)

Total

(UNDER CONSTRUCTION)

**GULLY PIT** (UNDER CONSTRUCTION) LĽ ш ш ш 2 S ш **B1** 4 Z 4  $\mathbf{m}$ 

**PRELIMINARY** NOT FOR CONSTRUCTION

$\vdash$		
03	04.08.23	ISSUED FOR INFORMATION - UPDATED ARCH PLANS
02	07.07.23	ISSUED FOR INFORMATION
01	04.08.22	ISSUED FOR INFORMATION
Rev	Date	Description

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GROUP
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lent FORTEZZA GROUP	Discipline CIVIL		Status PRELIMINARY	POST-DEVELOPMENT CATCHMENT PL	T PLAN	
BELLA BAIA	Designed By MK	Checked By KS	Approved By KS			
57 BANANA STREET, REDLAND BAY	Project No. 26164	Drawn By MK	Scale NTS (at A3)			
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Area (m²)

35

27

199

345

143

47

40

835

**Land Type** 

Roof

Pool

Landscaping

Hardstand

Landscaping

Hardstand

Driveway

Percentage of Total Site Area

4%

3%

24%

41%

17%

6%

5%

100%



## Appendix E MUSIC Model Data



#### **MUSIC Model Information**


#### Introduction:


The quality of stormwater runoff and the impact of the proposed stormwater quality improvement measures were analyzed using MUSIC Version 6.3.0 according to the MUSIC Modeling Guidelines, Water by Design. The source nodes in the model are split into various types and a summary of the area breakdown is presented below:

#### Meteorological Data:

The MUSIC model was carried out using the following parameters:

- Modeling period should be 10-years with a time step of 6 minutes
- The nearest available 6-minute time step rainfall series to the subject site is the 40265 Redlands station, with a mean annual rainfall of 1,088 mm, and data from: 1/1/1997 to 31/12/2006.

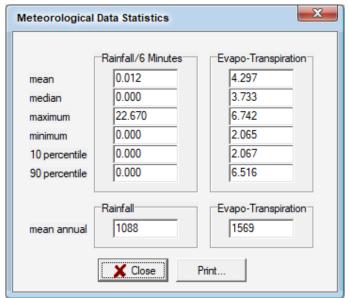

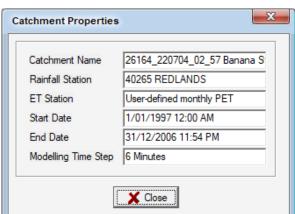

The mean annual evaporation was 1,569 mm.

#### Source Nodes, Fractions Impervious:

The areas of the source nodes were estimated as per SK02 in Appendix D.


#### Source Nodes - Pollutant Exports:

Rainfall runoff and pollutant export parameters were assigned per Tables 3.7 and 3.8 of the Water by Design MUSIC Modeling Guidelines.


The rainfall runoff and pollutant export parameters for an urban residential development were adopted.



Modelled Filter Chamber Attributes:

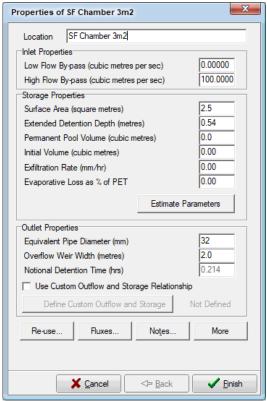



#### Modelled Psorb Stormfilter Attributes:

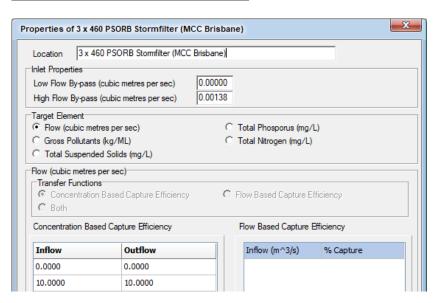




#### Modelled Psorb Stormfilter Attributes (continued 1):

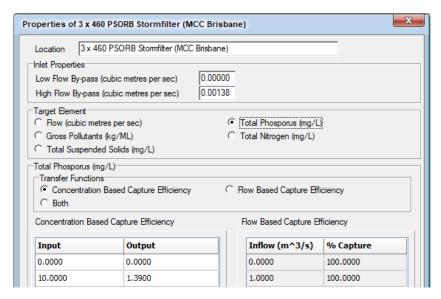


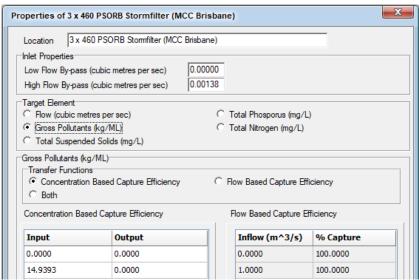

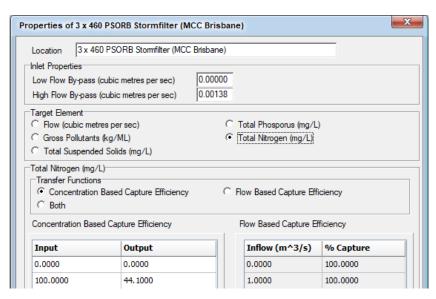





#### Modelled Psorb Stormfilter Attributes (continued 2):

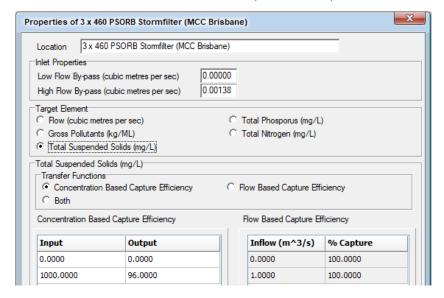


#### Modelled Oceanquard Attributes:

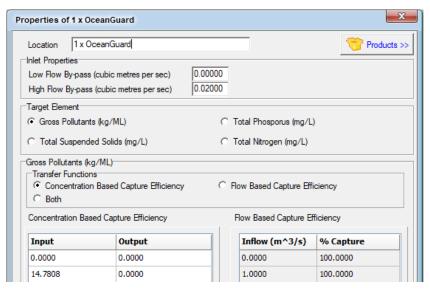


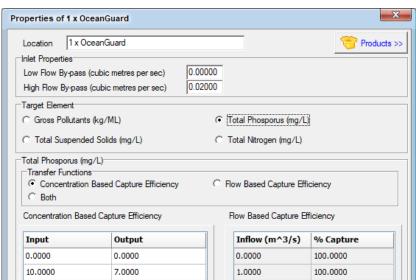




#### Modelled Oceanguard Attributes (continued):

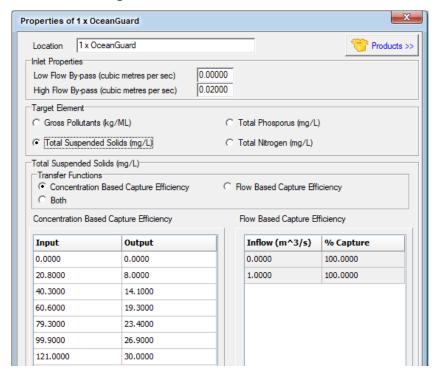

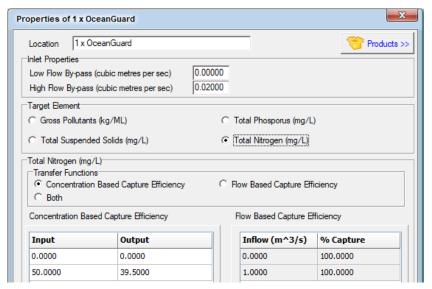



#### Modelled Grass-Lined Swale Attributes:

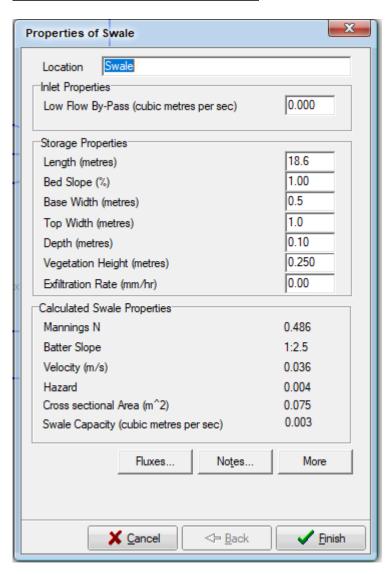

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