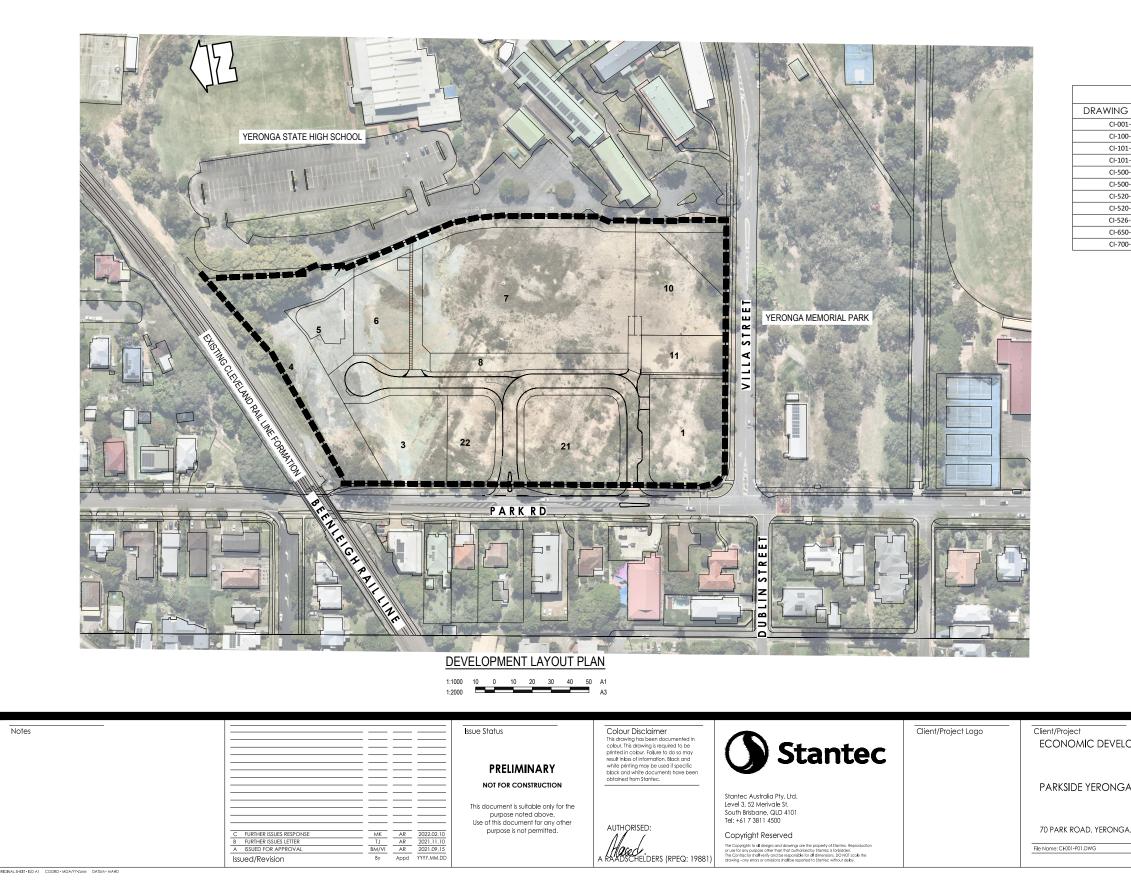
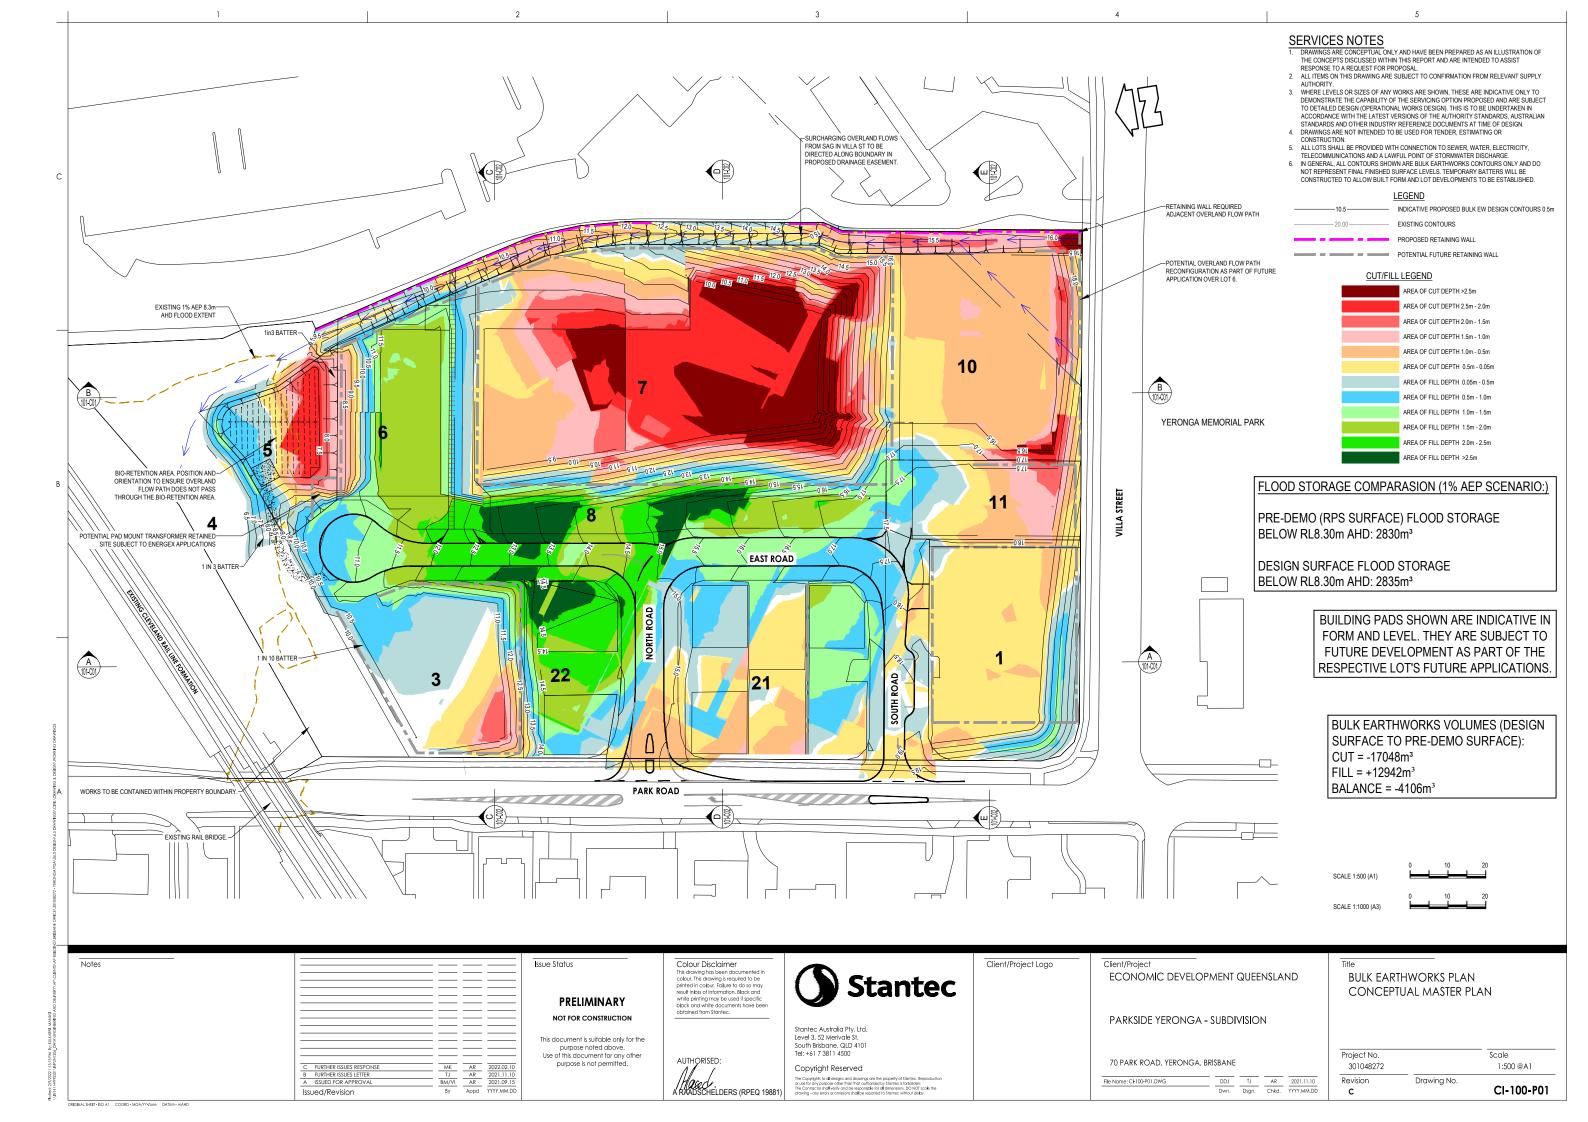
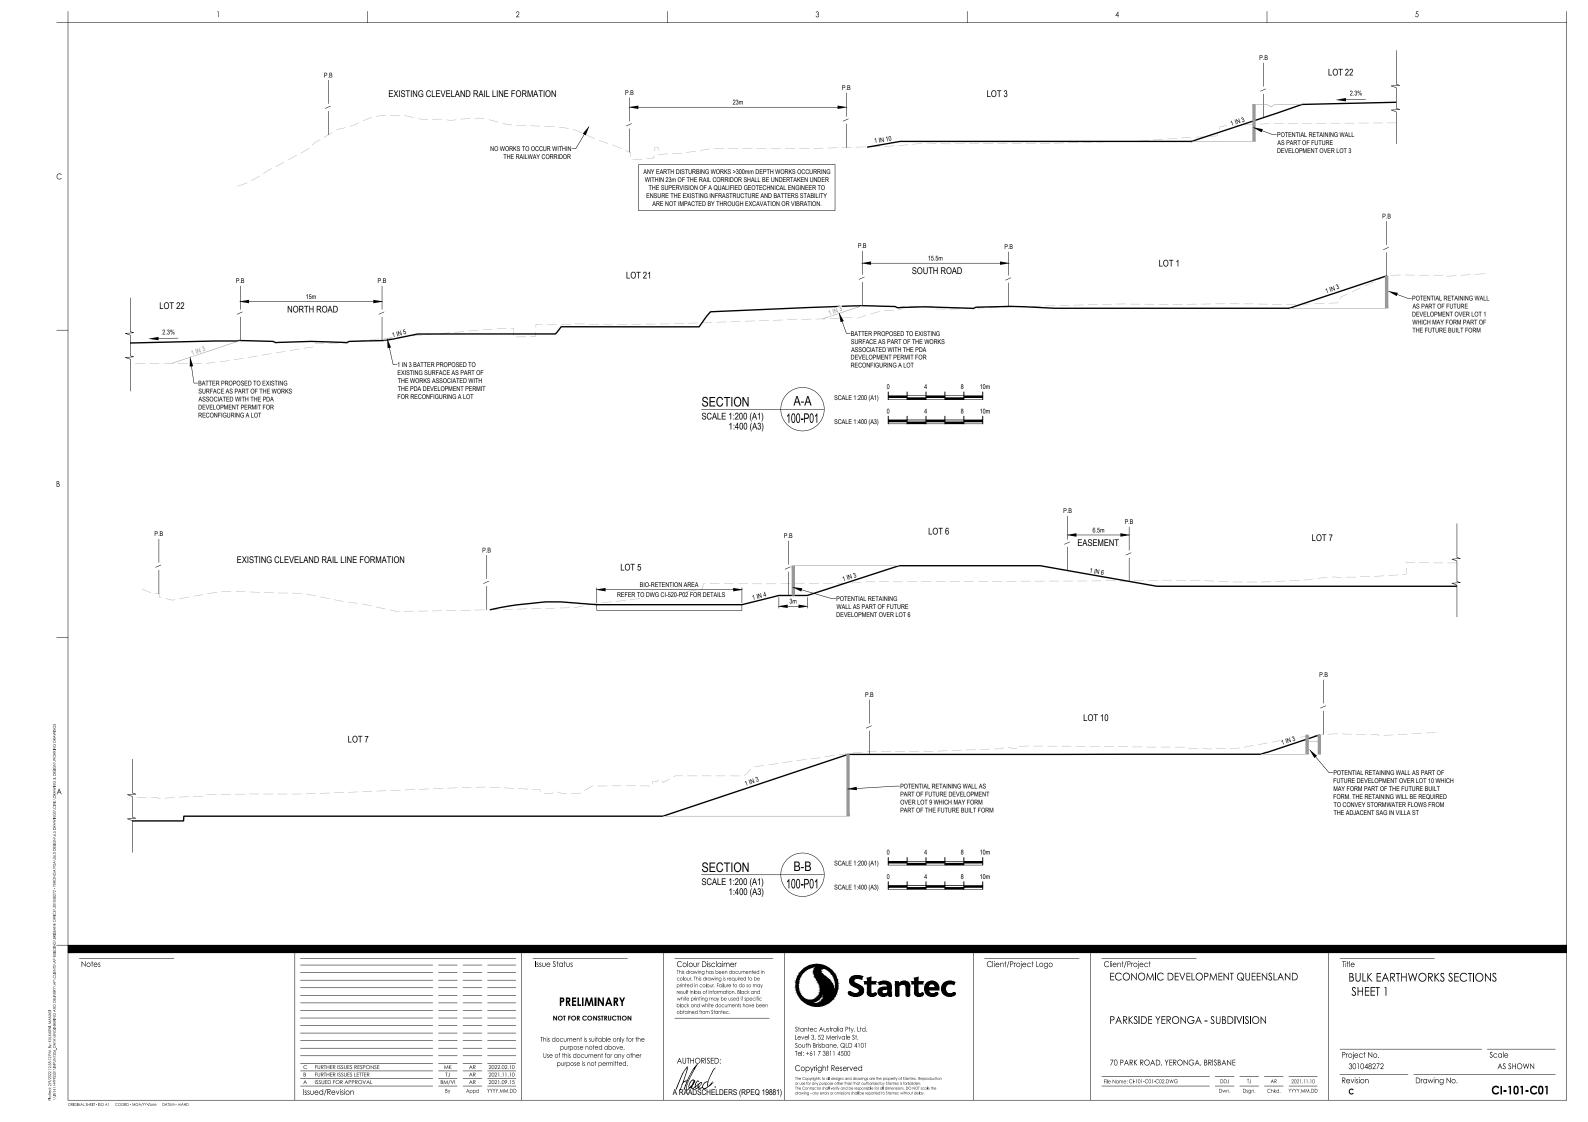
# ECONOMIC DEVELOPMENT QUEENSLAN PARKSIDE YERONGA - SUBDIVISION 70 PARK ROAD, YERONGA, BRISBANE

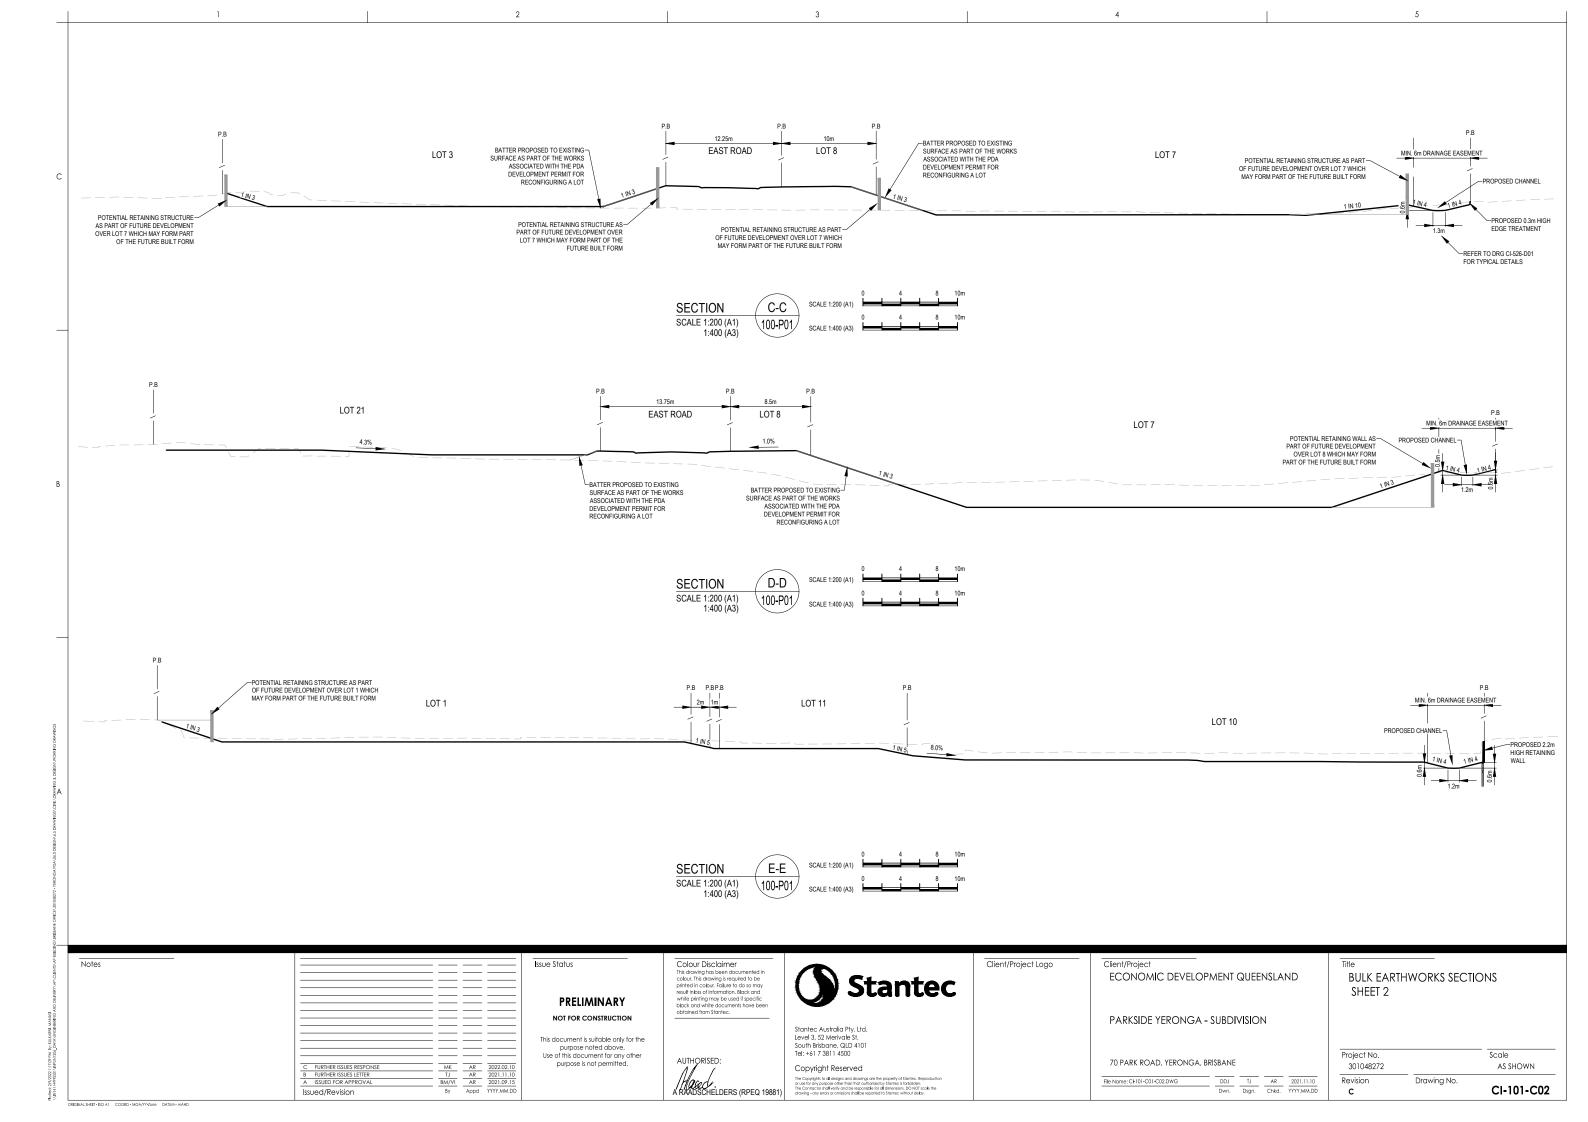


| DRAWING REGISTRY |   |  |  |  |  |  |
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| NUMBER           | DRAWING DESCRIPTION                             |  |  |  |  |  |
| -P01             | COVER SHEET, DRAWING REGISTRY AND LOCALITY PLAN |  |  |  |  |  |
| -P01             | BULK EARTHWORKS PLANCONCEPTUAL MASTER PLAN      |  |  |  |  |  |
| -C01             | BULK EARTHWORKS SECTIONS SHEET 1                |  |  |  |  |  |
| -C02             | BULK EARTHWORKS SECTIONS SHEET 2                |  |  |  |  |  |
| -P01             | CONCEPTUAL STORMWATER EXTERNAL CATCHMENT PLAN   |  |  |  |  |  |
| -P02             | CONCEPTUAL STORMWATER QUALITY CATCHMENT PLAN    |  |  |  |  |  |
| -P01             | CONCEPTUAL STORMWATER DRAINAGE PLAN             |  |  |  |  |  |
| -P02             | CONCEPTUAL STORMWATERMANAGEMENT PLAN            |  |  |  |  |  |
| -D01             | STORMWATER DRAINAGE DETAILS                     |  |  |  |  |  |
| -P01             | EXTERNAL WATER AUGMENTATIONCONCEPT PLAN         |  |  |  |  |  |
| -P01             | COMBINED SERVICES PLANCONCEPTUAL MASTER PLAN    |  |  |  |  |  |

| OPMENT QUEENSLAND | Title<br>COVER SHEET AND D | RAWING REGISTRY    |
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| a - Subdivision   |                            |                    |
|                   |                            |                    |
| A, BRISBANE       | Project No.<br>301048272   | Scale<br>1:1000@A1 |









| Notes |  |
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| Issued/Revision                                  | Ву          | Appd | YYYY.MM.DD            |   |

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Client/Project Logo

70 PARK ROAD, YERONGA, BRISBANE

File Name: CI-500-P01.DWG

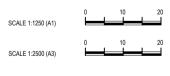
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### LEGEND

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PROPOSED 0.5m CONTOURS & HEIGHT PROPOSED CATCHMENT BOUNDARY INDICATIVE STORMWATER LINE & MANHOLE INDICATIVE STORMWATER LINE & PIT INDICATIVE STORMWATER OVERLAND FLOW PATH EXISTING STORMWATER LINE & MANHOLE EXISTING STORMWATER LINE & GULLY EXISTING STORMWATER LINE TO BE REMOVED

PROPOSED CATCHMENT LABEL



## OPMENT QUEENSLAND

## a - subdivision

| DDJ  | TJ    | AR    | 2021.11.10 |
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## CONCEPTUAL STORMWATER EXTERNAL CATCHMENT PLAN

Project No. 301048272

Revision

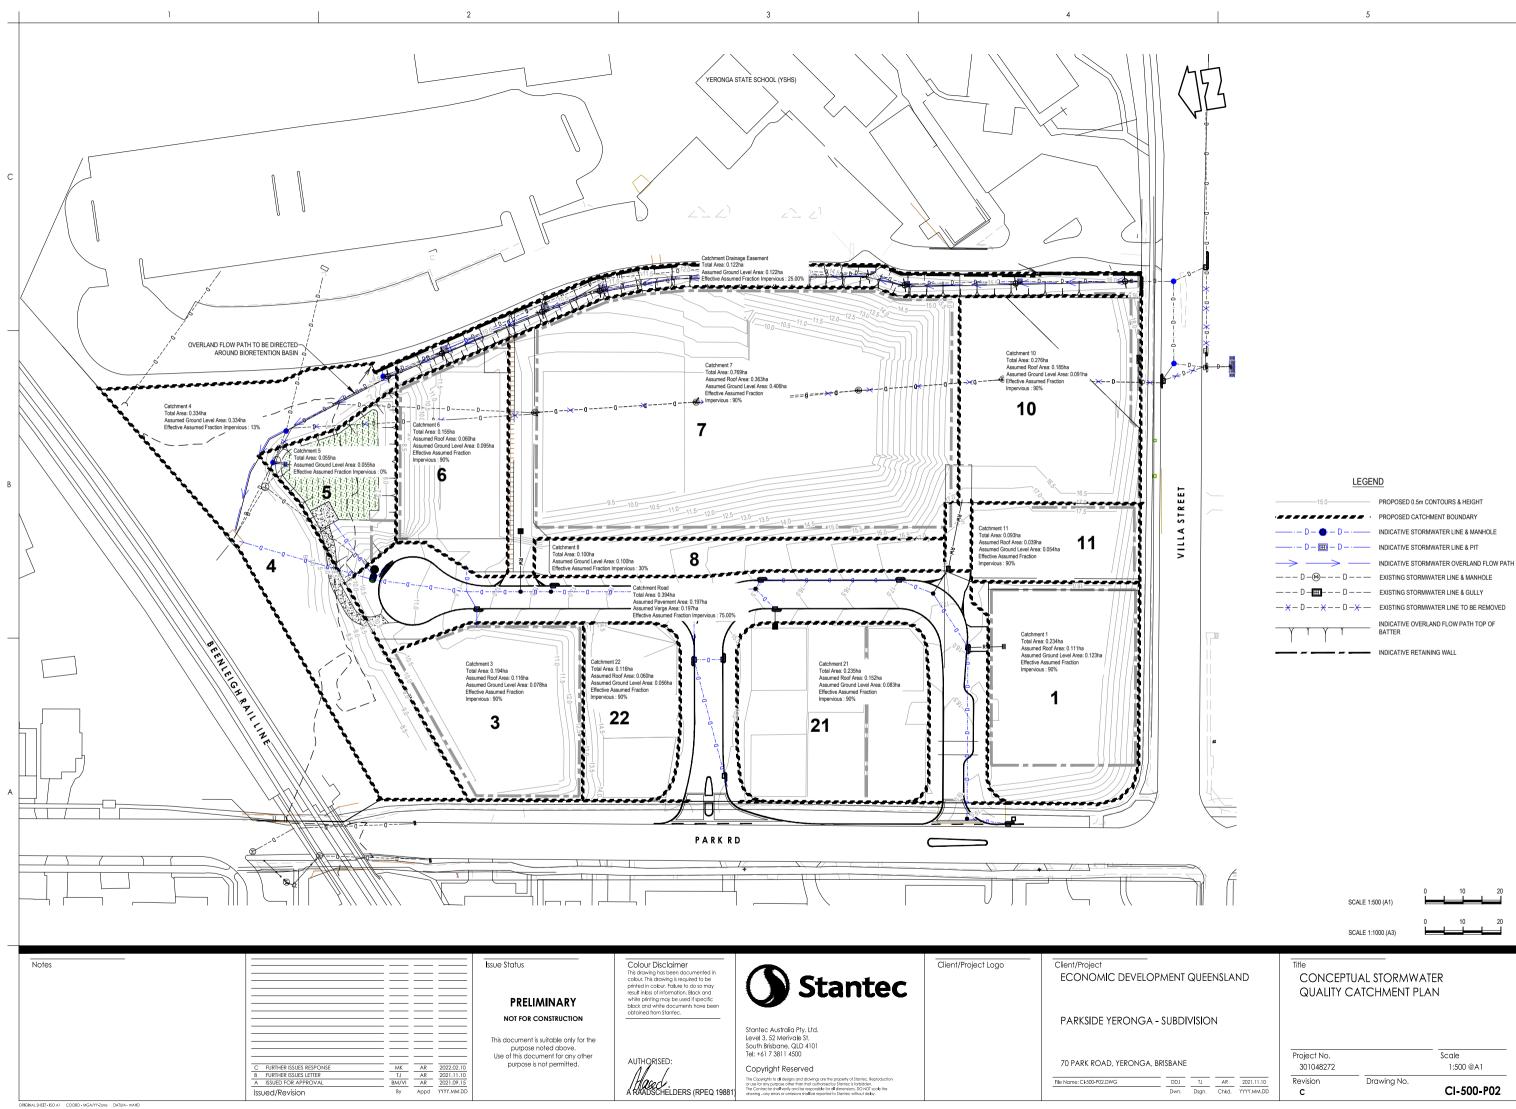
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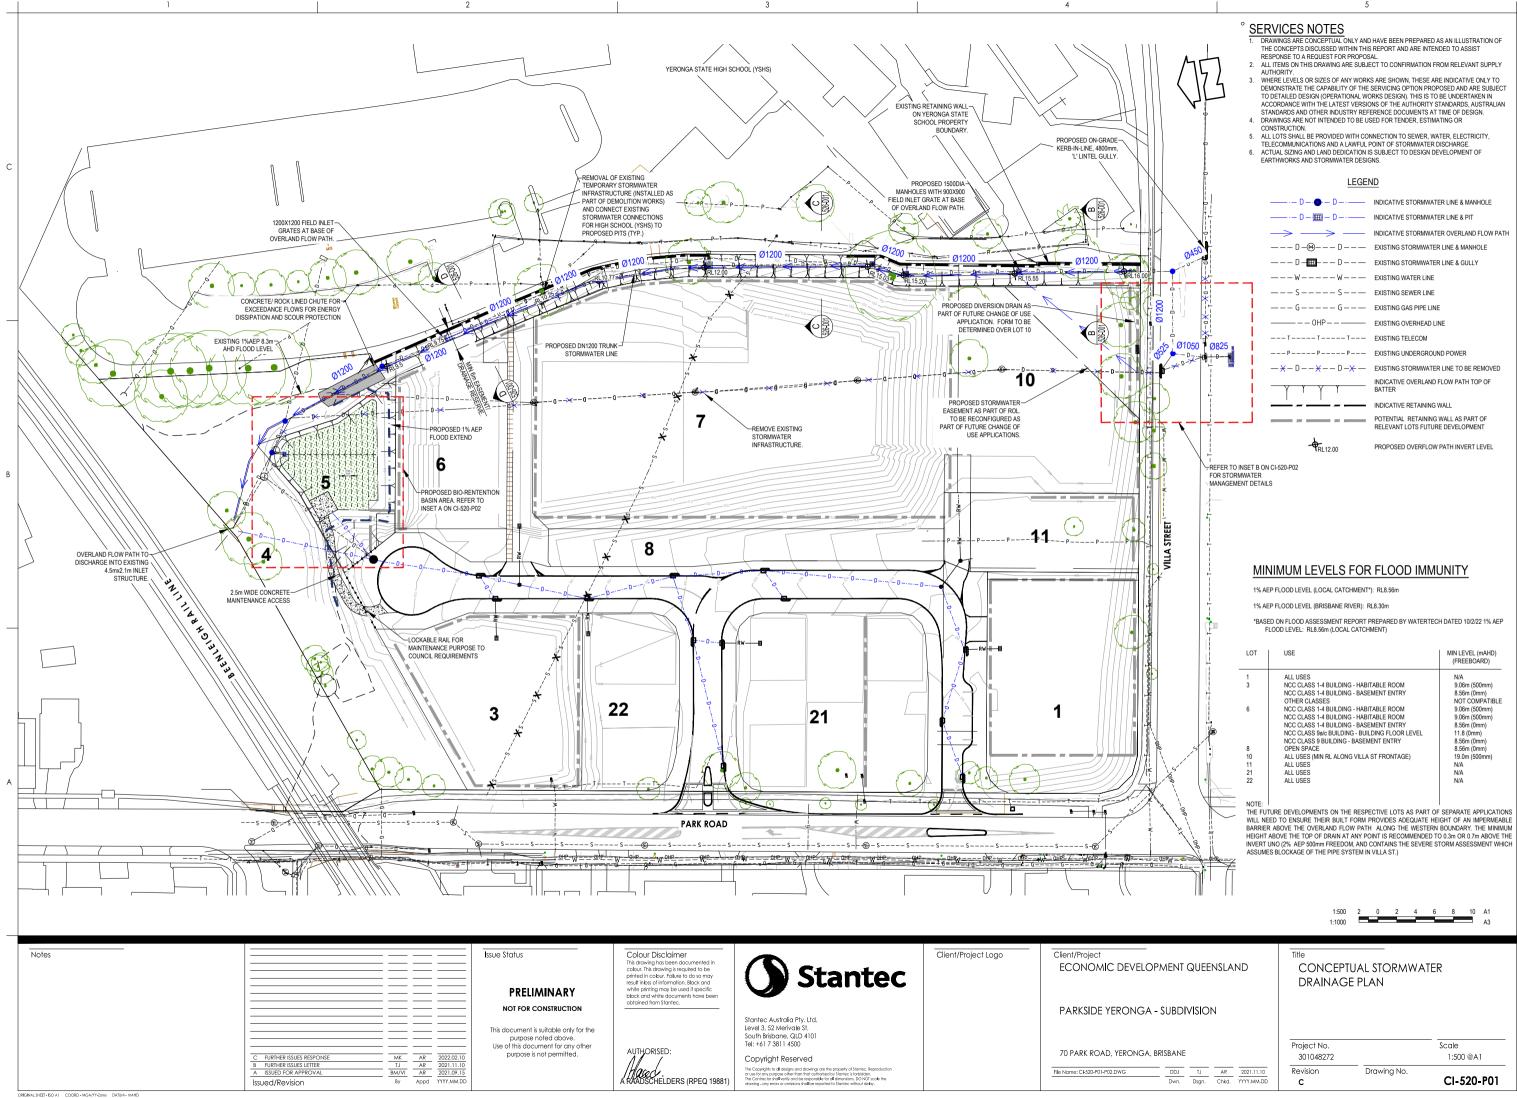
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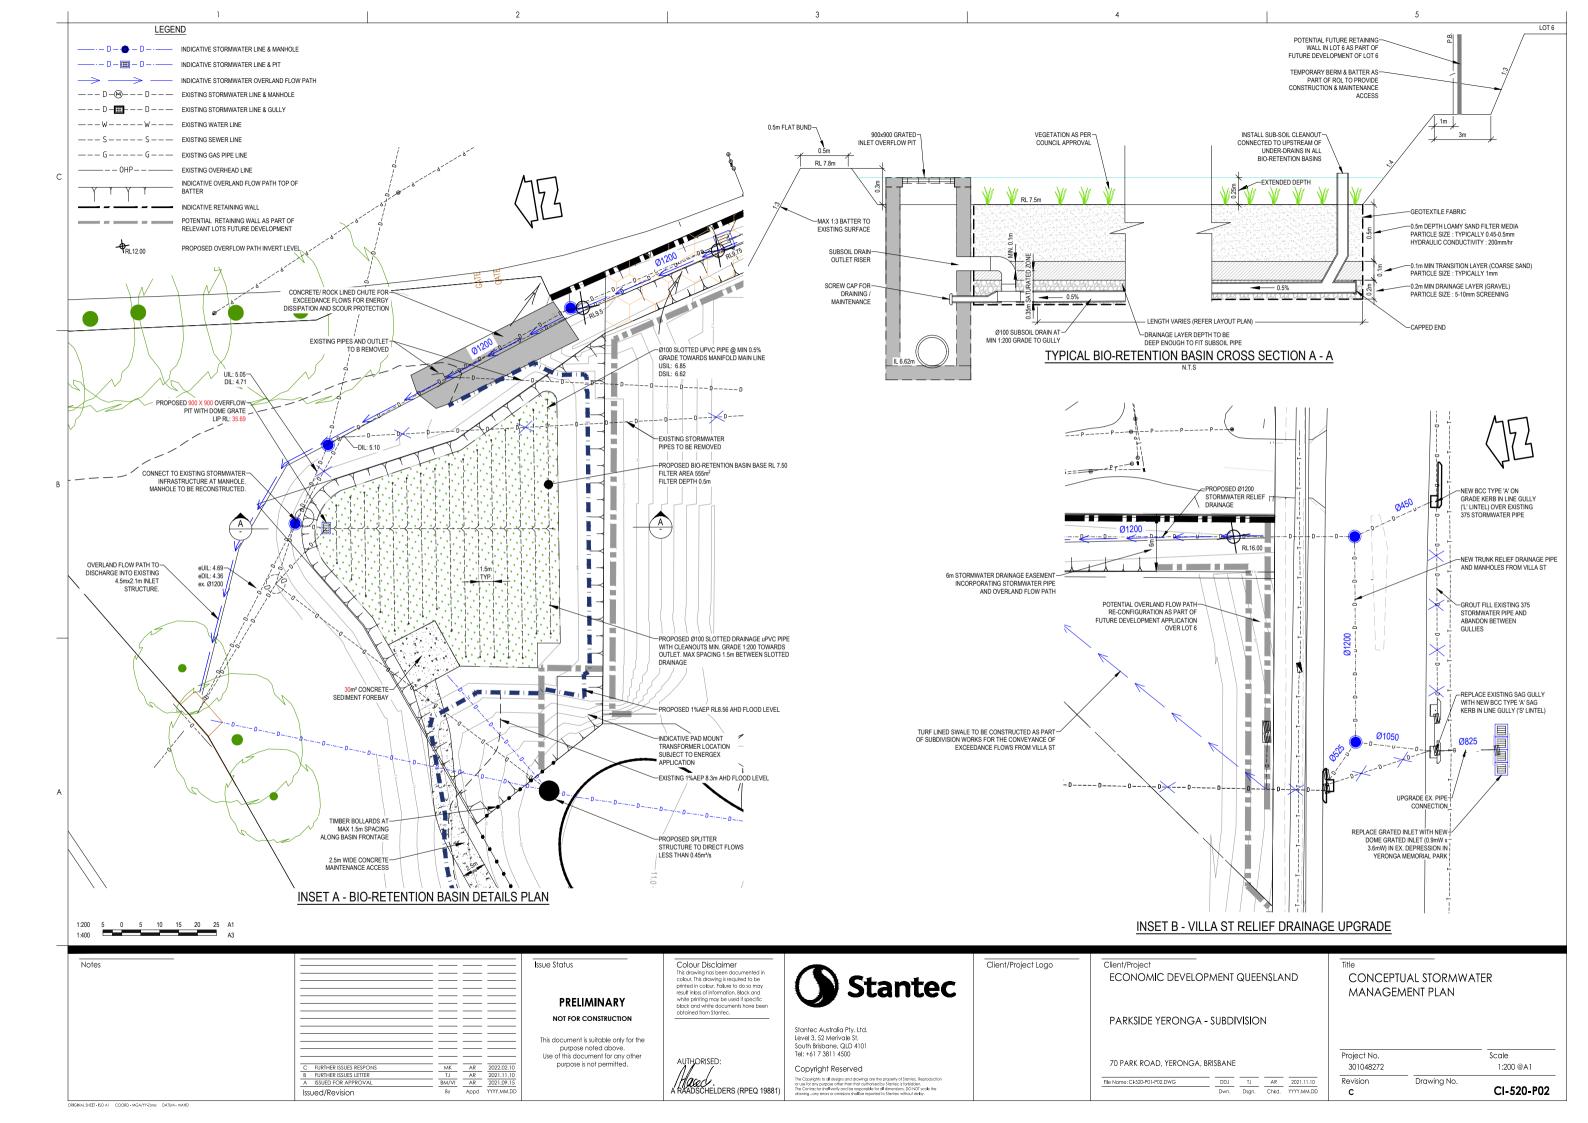
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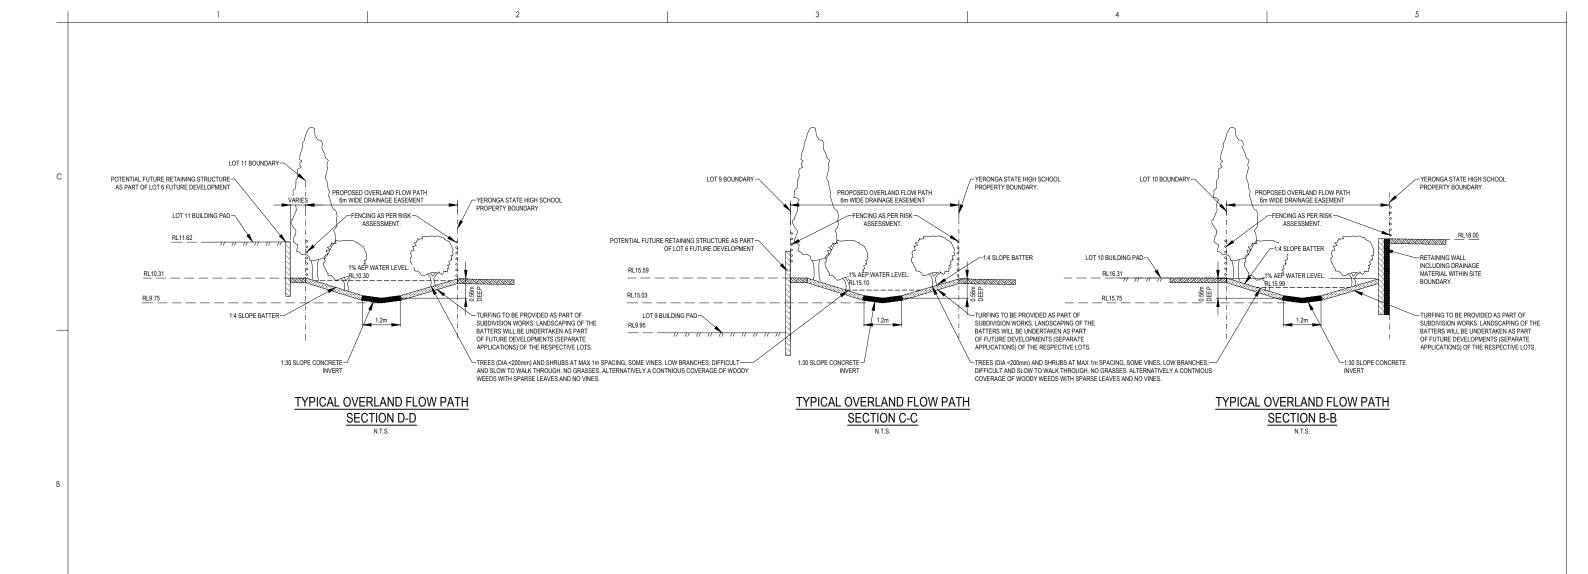
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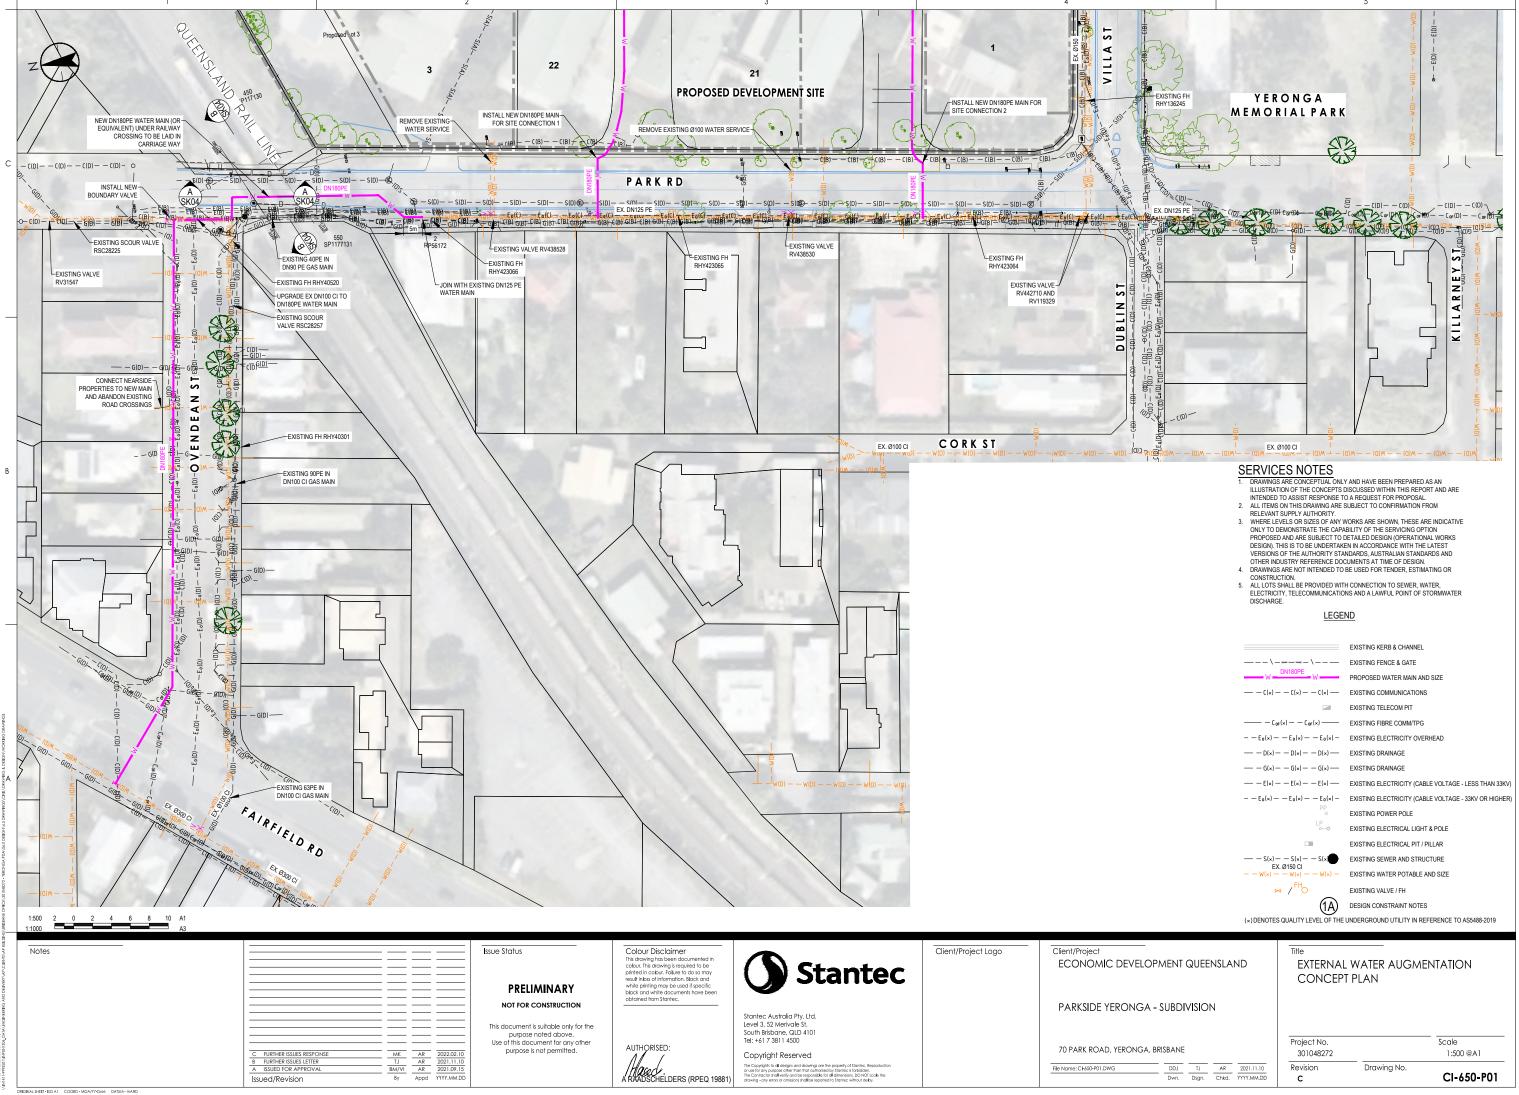






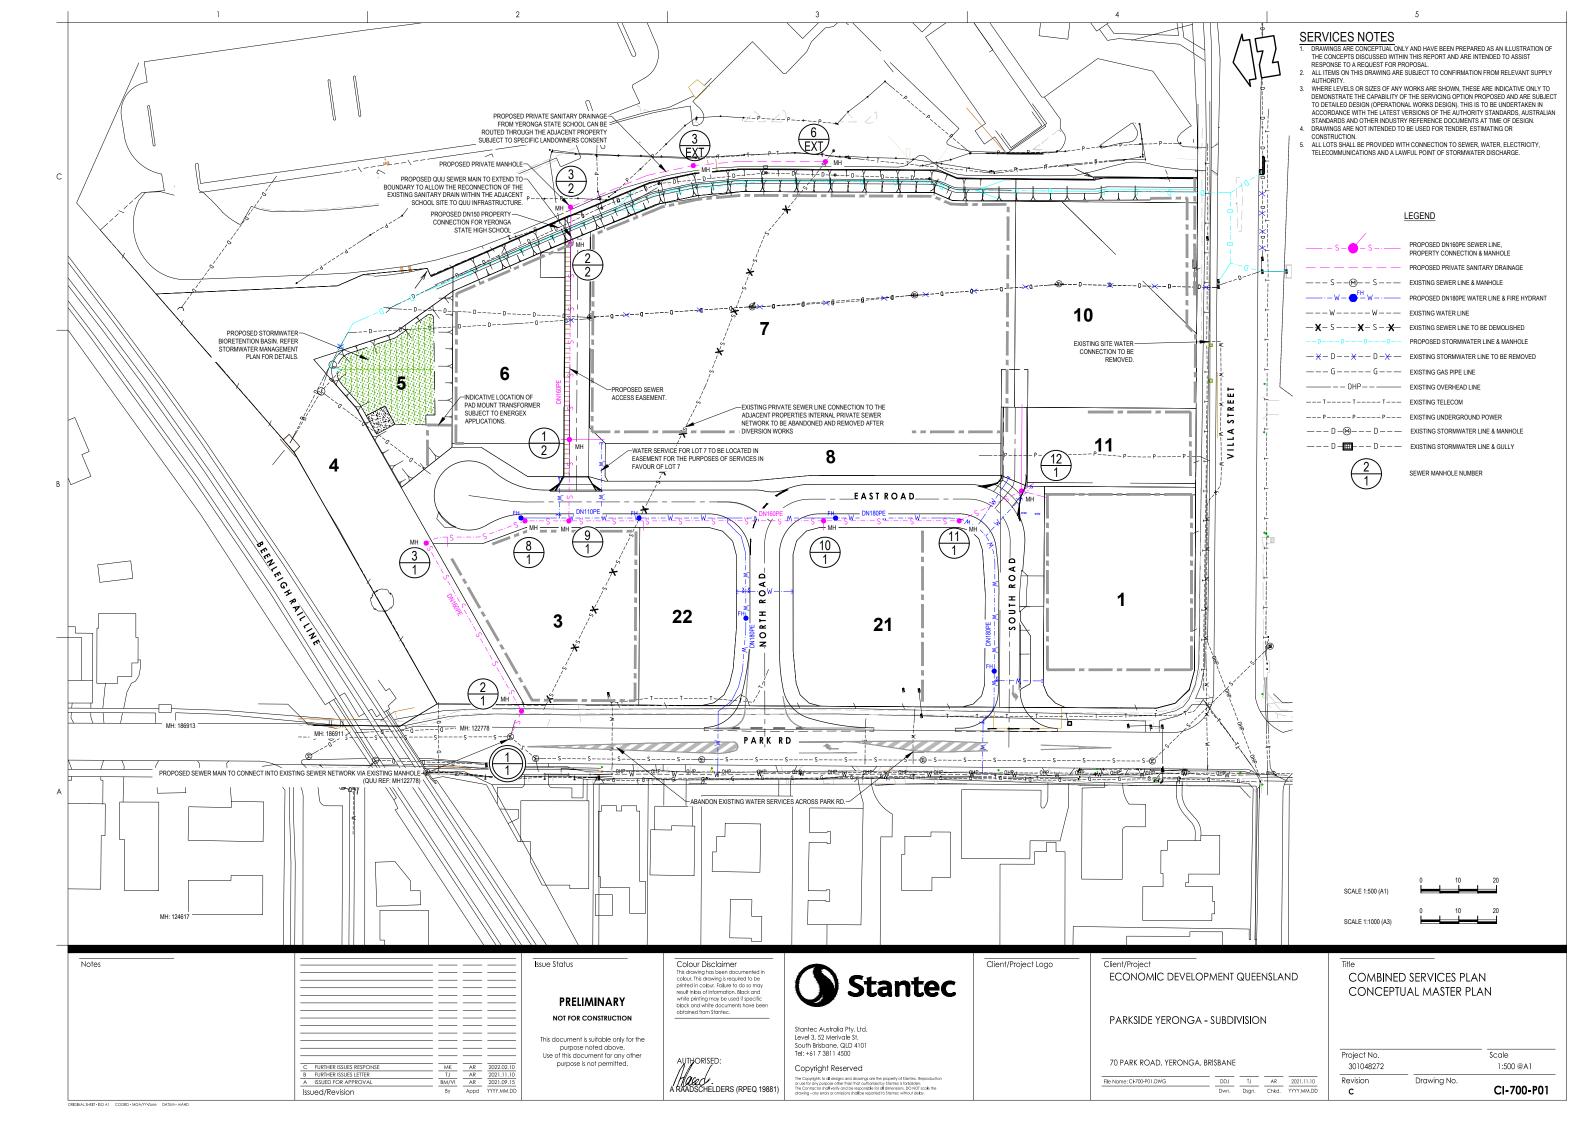


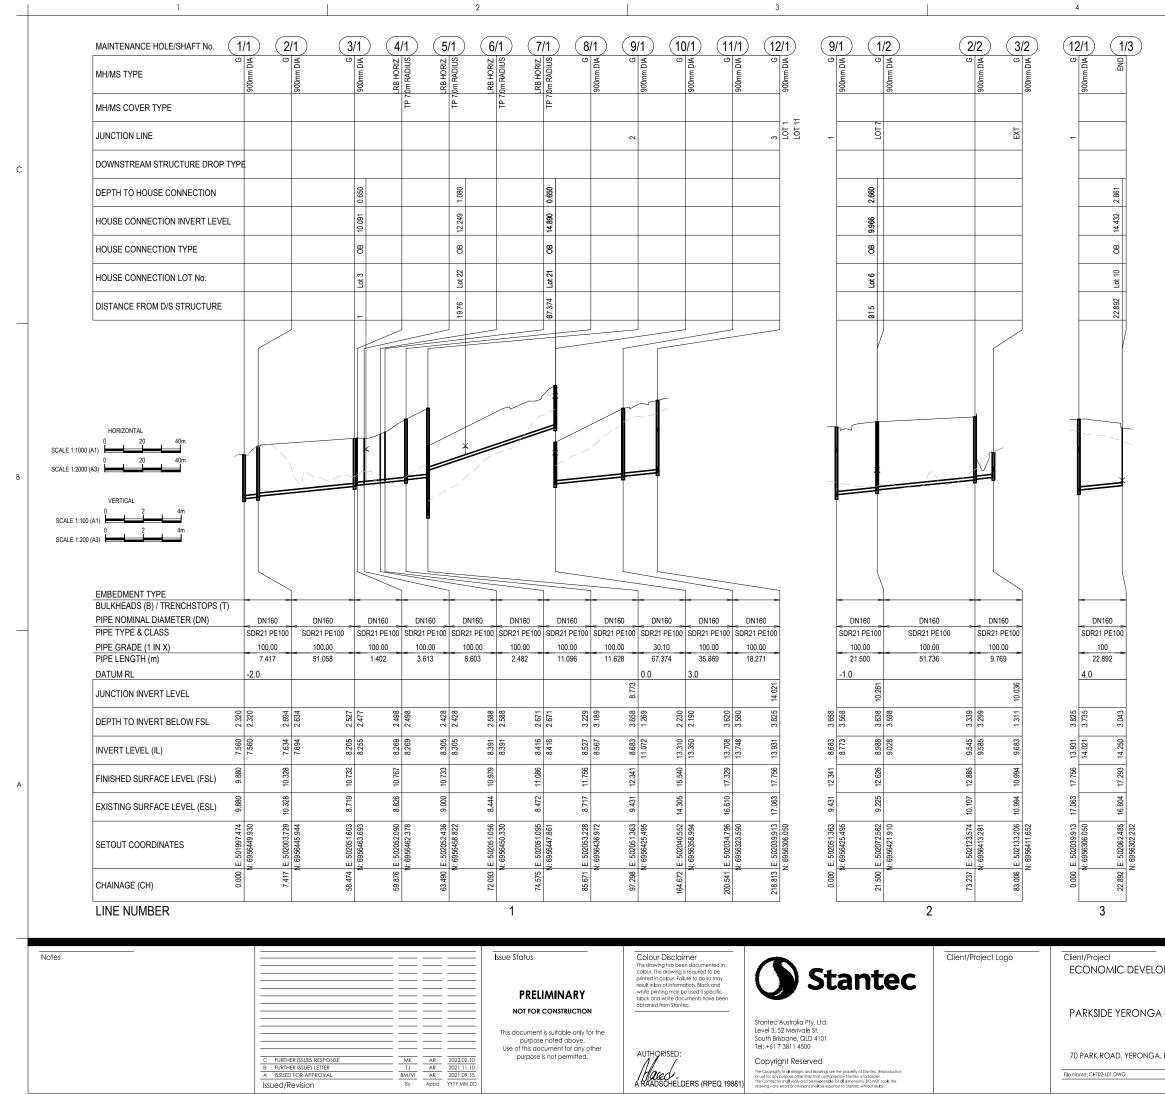
| Notes |  | Issue Status   | Colour Disclaimer<br>This drawing has been documented in<br>colour. This drawing is required to be<br>printed in colour. Failure to do so may<br>result inos of information. Black and | Stantec  | Client/Project Logo | Client/Project         Title           ECONOMIC DEVELOPMENT QUEENSLAND         STORMWATER DRAINAGE   |                          | ge details |
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| ( <u>3</u> /<br>0   | 2 MID MM006    | ) (1/E  | TP 70m RADIUS  | ) 2/E   | TP 7.0m RADIUS | ) <u>3/E</u>                                   | 900mm DIA      | T) 4/E ZINOH BNT                               | TP 7 0m RADIUS X | 5/E ZINOH BN-                                 | TP 70m RADIUS  | ) <u>6/E</u>                                   | 900mm DIA          |
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|                     | -              | PRIVATE<br>DN150<br>PVC SN8<br>50.00<br>21.194<br>0 |                | PRIVATE<br>DN150<br>PVC SN8<br>50.00<br>1.286 | -              | PRIVATE<br>DN150<br>PVC SN8<br>50.00<br>11.837 | -              | PRIVATE<br>DN150<br>PVC SN8<br>25.00<br>12.110 | -                | PRIVATE<br>DN150<br>PVC SN8<br>25.00<br>0.672 | -              | PRIVATE<br>DN150<br>PVC SN8<br>25.00<br>22.202 |                    |
| 9.683 1.311         | 10.036 0.958   | 10.460 1.138  | 10.460 1.138   | 10.485  | 10.485 1.157   | 10.722 1.316                                   | 10.968 1.071   | 11.452 0.965                                   | 11.452 0.965     | 11.479 0.959                                  | 11.479 0.959   | 12.367 1.130                                   |                    |
| 10.994 10.994 9     | 11             | 11.598 11.598 10                                    |                | 11.643 11.643 10                              | 1              | 12.038 12.038 10                               | 1(             | 12.417 12.417 1                                | -                | 12.439 12.439 1                               | -              | 13.497 13.497 12                               |                    |
| 0.000 E: 502133.206 | N: 6956411.652 | 21.194 E: 502138.075                                | N: 6956391.025 | 22.480 E: 502138.255                          | N: 6956389.753 | 34.317 E: 502138.824                           | N: 6956377.930 | 46.427 E: 502137.974                           | N: 6956365.850   | 47.100 E: 502137.895                          | N: 6956365.182 | 69.302 E: 502134.220                           | N: 6956343.287     |
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| C |  | MAINTENANCE HOLE/SHAFT No.     12/1     1/LOT     12/1     1/LOT     1/2/1     1/LOT       MH/MS TYPE     0     0     0     0     0     0     0       MH/MS COVER TYPE     0     0     0     0     0     0     0       JUNCTION LINE     -     -     -     -     -     -     -       DOWNSTREAM STRUCTURE DROP TYPE     -     -     -     -     -     -       HOUSE CONNECTION INVERT LEVEL     10     10     10     10     10     10       HOUSE CONNECTION INVERT LEVEL     10     10     10     10     10     10       HOUSE CONNECTION INVERT LEVEL     10     10     10     10     10     10       HOUSE CONNECTION INVERT LEVEL     10     10     10     10     10     10       HOUSE CONNECTION INTYPE     80     10     10     10     10     10       IDISTANCE FROM D/S STRUCTURE     10     10     10     10     10     10 |
| В | HORIZONTAL<br>SCALE 1:1000 (A1)<br>SCALE 1:2000 (A3)<br>VERTICAL<br>SCALE 1:100 (A1)<br>0<br>20<br>40m<br>VERTICAL<br>SCALE 1:100 (A1)<br>0<br>2<br>4m<br>SCALE 1:100 (A1)<br>0<br>2<br>4m<br>SCALE 1:100 (A1)<br>0<br>2<br>4m<br>SCALE 1:100 (A1)<br>0<br>2<br>4m<br>SCALE 1:100 (A3) |  |
| 4 |  | EMBEDMENT TYPE       BULKHEADS (b) TRENCHSTOPS (T)       PIPE TYPE & CLASS       SDR21 FE100       PIPE TYPE & CLASS       DATUM RL       DEPTH TO INVERT LEVEL       DEPTH TO INVERT LEVEL       DEPTH TO INVERT LEVEL       SETOUT COORDINATES       SETOUT COORDINATES       OBTOW       SETOUT COORDINATES       DOTO       THNE NUMBER       LOT 1         LOT 1     LOT 1  |
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SEWER LONGITUDINAL SECTION - 2

Project No. 301048272 Scale 1:100 @A1 Revision C Drawing No. CI-702-L02

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