

DEV2020/1098 - SUPPORTING
DOCUMENT ONLY

COLOURED SHOTCRETE
'HOLCIM GEOSTONE SANDSTONE'

4A SERVICES
TUNNEL SLAB

4B PORTION OF ENTRY SLAB
REMOVED FOR CLARITY

COLOURED SHOTCRETE
'HOLCIM GEOSTONE SANDSTONE'

TECCO MESH

SERVICES BATTER TO REMAIN
IN GREY CONCRETE

SHOTCRETE BETWEEN PILES TO
BE NATURAL GREY IN COLOUR

WALL 2

SHOTCRETE BETWEEN PILES TO
BE NATURAL GREY IN COLOUR

3D RETENTION WALL VIEW

SCALE:

SHOTCRETE GREY

HATCHING DENOTES HYDROMULCH OR
SIMILAR TO BATTER. REFER TO
GEOTECHNICAL SPECIFICATIONS FOR
FINAL SLOPE AND FINISH

REFER TO CIVIL
ENGINEERING
DRAWINGS FOR
RETAINING BATTER
DESIGN

WALL NOTES

(UNLESS NOTED OTHERWISE ON PLAN)

- SHOTCRETE TO BATTERED AREA ABOVE CAPPING BEAM TO BE COLOURED.
- ALL SHOTCRETE BELOW THE CAPPING BEAM AND BETWEEN PILES TO BE NATURAL GREY FINISH.

COLOURED CONCRETE TO BE HOLCIM 'GEOSTONE - SANDSTONE IN
COLOUR TO HAVE A ROUGH WOOD FLOAT FINISH

3D RETENTION WALL VIEW 2

SCALE

PROPERTY INFORMATION:

LOT 546 ON SP289113
PARISH OF NORTH BRISBANE
BRISBANE CITY COUNCIL

BCC DRAINAGE PLAN No: 116502

300 HERSTON ROAD,
HERSTON, QLD, 4006

SCALE

CALBRE PROJECT NUMBER
19-000558

NOTES

- REFER DRAWINGS S-0001 & S-0003 FOR STRUCTURAL NOTES.
- SETOUT DIMENSIONS & ALL OF ALL ELEMENTS TO ARCHITECTURAL DETAILS. ENGINEER TO BE NOTIFIED IF STRUCTURAL DRAWINGS VARY FROM CURRENT ARCHITECT'S PRIOR TO THE COMMENCEMENT OF ANY WORKS.
- REFER DRAWINGS S-0300 TO S-0301 FOR TYPICAL DETAILS.

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ENSURE DRAWING IS PRINTED IN COLOUR

REV	DESCRIPTION	DATE
K	FOR REVIEW AND APPROVAL	15.04.21
J	FOR REVIEW AND APPROVAL	08.04.21
I	FOR REVIEW AND APPROVAL	01.04.21
H	FOR REVIEW AND APPROVAL	05.03.21
G	FOR REVIEW AND APPROVAL	26.02.21
F	FOR REVIEW AND APPROVAL	23.10.20
E	PRELIMINARY ISSUE	16.08.19

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CLIENT



PROJECT



STAGE 4B

DRAWING TITLE
RETENTION 3D VIEW

APPROVED

PROJECT STATUS
STAGE 4B

SHEET STATUS
DESIGN DEVELOPMENT

SCALE @ A1
AS INDICATED

DRAWN
FS

PROJECT NUMBER
NC-4B

DRAWING NUMBER
S-1005


REV
K

RETENTION DESIGN BASED OFF
GEOTECHNICAL INFORMATION PREPARED BY
DOUGLAS PARTNERS REPORT. CONTRACTOR
IS RESPONSIBLE FOR FINAL DESIGN
REQUIREMENTS.

DISCLAIMER

FINAL DESIGN TO BE FURTHER DEVELOPED
BASED ON GEOTECHNICAL ADVICE AND SITE
FINDINGS AS EXCAVATION PROCEEDS AND THE
ROCK FACE IS EXPOSED

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- CONTRACTOR TO COMPLETE DILATATION REPORT ON ALL NEIGHBOURING STRUCTURES, ROADS AND SERVICES PRIOR TO COMMENCING ANCHORING WORKS.
- CONTRACTOR TO ACCURATELY LOCATE ALL SERVICES (SW, GAS, WATER, TELECOMS, SEWER) PRIOR TO COMMENCING WORKS. ANCHORING DESIGN TO ALLOW MINIMUM EXISTING SERVICES CLEARANCES. CONTRACTOR TO ARRANGE FOR APPROVAL FOR WORKS FROM ASSET OWNERS.
- CONTRACTOR TO COMPLETE OCTV SCAN OF SERVICES PRIOR TO CONSTRUCTION.
- FINAL OCTV TO BE COMPLETED POST CONSTRUCTION.
- GROUND ANCHORS ARE NOT TO EXTEND BEYOND 10m OF THE REAL PROPERTY BOUNDARY.

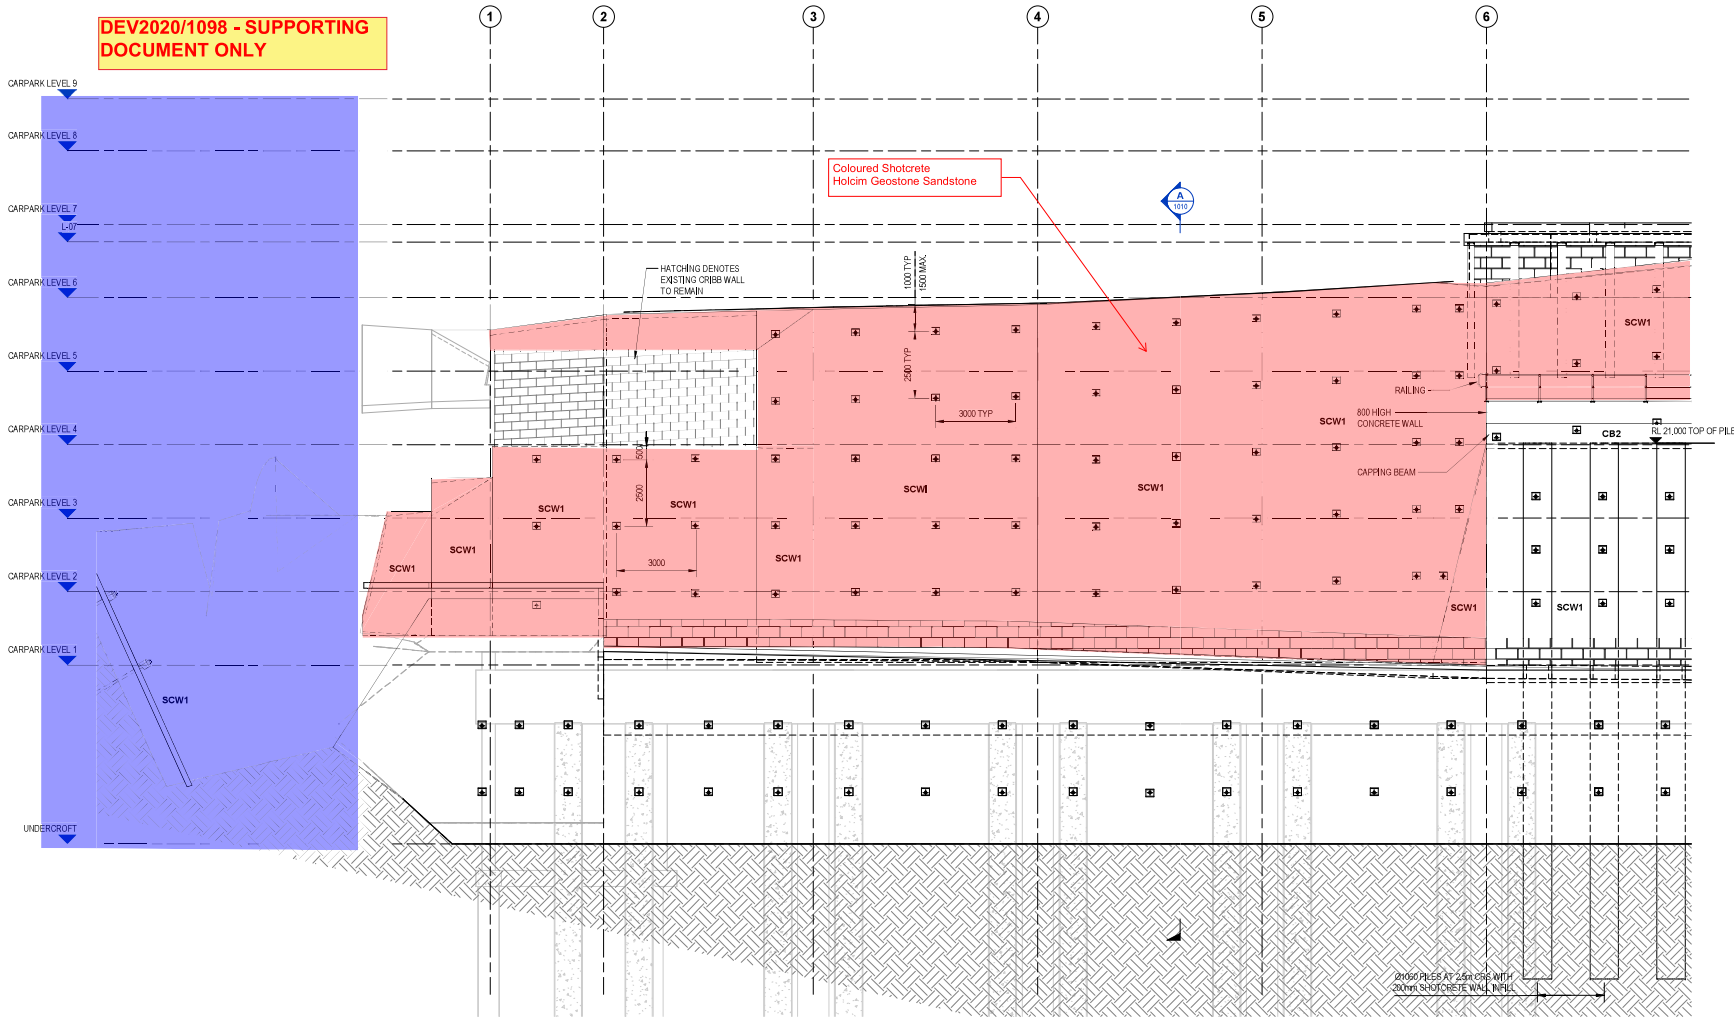CONTRACTOR TO CARRY OUT ALL SERVICES
SEARCHES OF NEIGHBOURING PROPERTIES

NOTWITHSTANDING THAT EXISTING SERVICES
MAY OR MAY NOT BE SHOWN ON THE JOB
DRAWINGS, IT IS THE CONTRACTOR'S
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OF ANY UNDERGROUND SERVICES IN THIS AREA
AND IT IS THE CONTRACTOR'S RESPONSIBILITY
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LEGEND

(UNLESS NOTED OTHERWISE ON PLAN)

- DENOTES EXISTING SITE BOUNDARY
- ⊕ DENOTES ROCK BOLT LOCATION

SHOTCRETE WALL SCHEDULE

MARK	THICKNESS
SCW1	200

SOLDIER PILE SCHEDULE

PILE TYPE	PILE DIAMETER (mm)	PILE LENGTH TYPICAL (m)	REINFORCEMENT MAIN BARS	REINFORCEMENT SPIRAL
N	1080	20 TO 24	14A28	N13-350

ANCHOR SCHEDULE (INDICATIVE)

ROW ID	WORKING LOAD (kN)	NOMINAL DIAMETER	STEEL GRADE	LENGTH	SPACING	INCLINATION DEGREES
A1	500	DIA. 50	500/550	14m	2.5m	30°
A2	800	DIA. 63.5	500/550	15m	2.5m	40°
A3	800	DIA. 63.5	500/550	20m	2.5m	30°

RETAINING WALL 2 - PART A

SCALE: 1 : 100

CAPPING BEAM SCHEDULE

TYPE MARK	DEPTH	WIDTH	REBAR kg/m³
CB2	800	1250	180

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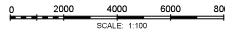
PROPERTY INFORMATION:

LOT 546 ON SP289113
PARISH OF NORTH BRISBANE
BRISBANE CITY COUNCIL

BCC DRAINAGE PLAN No: 116502

300 HERSTON ROAD,
HERSTON, QLD, 4006

SCALE



CALIBRE PROJECT NUMBER

19-000558

NOTES

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- SETOUT, DIMENSIONS AND R.L.s OF ALL ELEMENTS TO ARCHITECTURAL DETAILS. ENGINEER TO BE NOTIFIED IF STRUCTURAL DRAWINGS VARY FROM CURRENT ARCHITECT'S PRIOR TO THE COMMENCEMENT OF ANY WORKS.
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PROJECT



STAGE 4B

DRAWING TITLE
RETENTION ELEVATIONS - SHEET 1

APPROVED

PROJECT STATUS

STAGE 4B

SHEET STATUS

DESIGN DEVELOPMENT

SCALE @ A1

AS INDICATED

DRAWN

FS

PROJECT NUMBER


NC-4B

DRAWING NUMBER

S-1006

REV

K

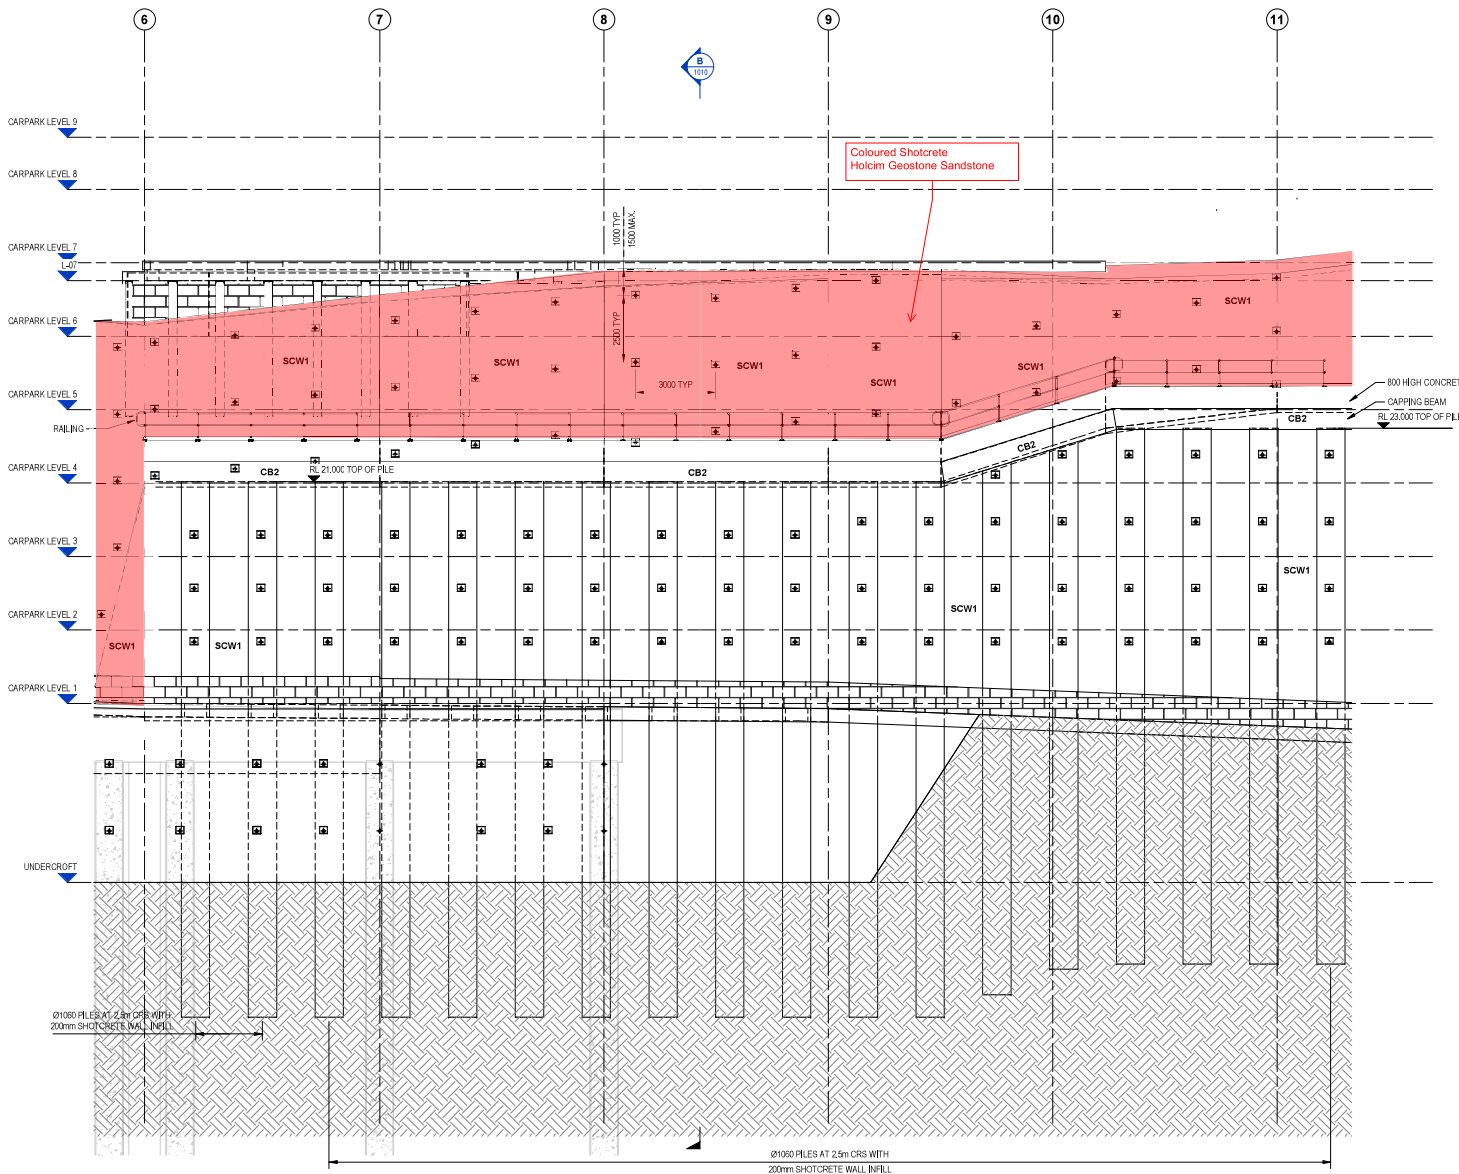

RETAINING WALL 2 - PART B

SCALE: 1:100

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SOLDIER PILE SCHEDULE				
PILE TYPE	PILE DIAMETER (mm)	PILE LENGTH TYPICAL (m)	REINFORCEMENT MAIN BARS	REINFORCEMENT SPIRAL
N	1080	20 TO 24	14N28	N12-350

ANCHOR SCHEDULE (INDICATIVE)					
ROW ID	WORKING LOAD (kN)	NOMINAL DIAMETER	STEEL GRADE	LENGTH	INCLINATION DEGREES
A1	500	D16.50	500/550	14m	2.5m
A2	800	D16.50	500/550	15m	2.5m
A3	900	D16.50	500/550	20m	2.5m

LEGEND

(UNLESS NOTED OTHERWISE ON PLAN)

- DENOTES EXISTING SITE BOUNDARY
- ⊕ DENOTES ROCK BOLT LOCATION

DEV2020/1098 - SUPPORTING
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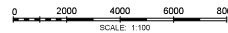
PROPERTY INFORMATION:

LOT 546 ON SP289113
PARISH OF NORTH BRISBANE
BRISBANE CITY COUNCIL

BCC DRAINAGE PLAN No: 116502

300 HERSTON ROAD,
HERSTON, QLD, 4006

SCALE



CALIBRE PROJECT NUMBER

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PROJECT



STAGE 4B

DRAWING TITLE
RETENTION ELEVATIONS - SHEET 2

APPROVED

PROJECT STATUS

STAGE 4B

SHEET STATUS

DESIGN DEVELOPMENT

SCALE @ A1

AS INDICATED

DRAWN

FS

PROJECT NUMBER

NC-4B

DRAWING NUMBER

S-1007

REV

K


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CALBRE PROJECT NUMBER
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PROJECT



STAGE 4B

DRAWING TITLE
RETENTION ELEVATIONS - SHEET 3

APPROVED

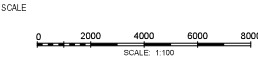PROJECT STATUS
STAGE 4B

SHEET STATUS
DESIGN DEVELOPMENT


SCALE @ A1
AS INDICATED

PROJECT NUMBER
NC-4B

DRAWING NUMBER
S-1008

REV
K

Original Sheet Size A1 - 841 x 594mm

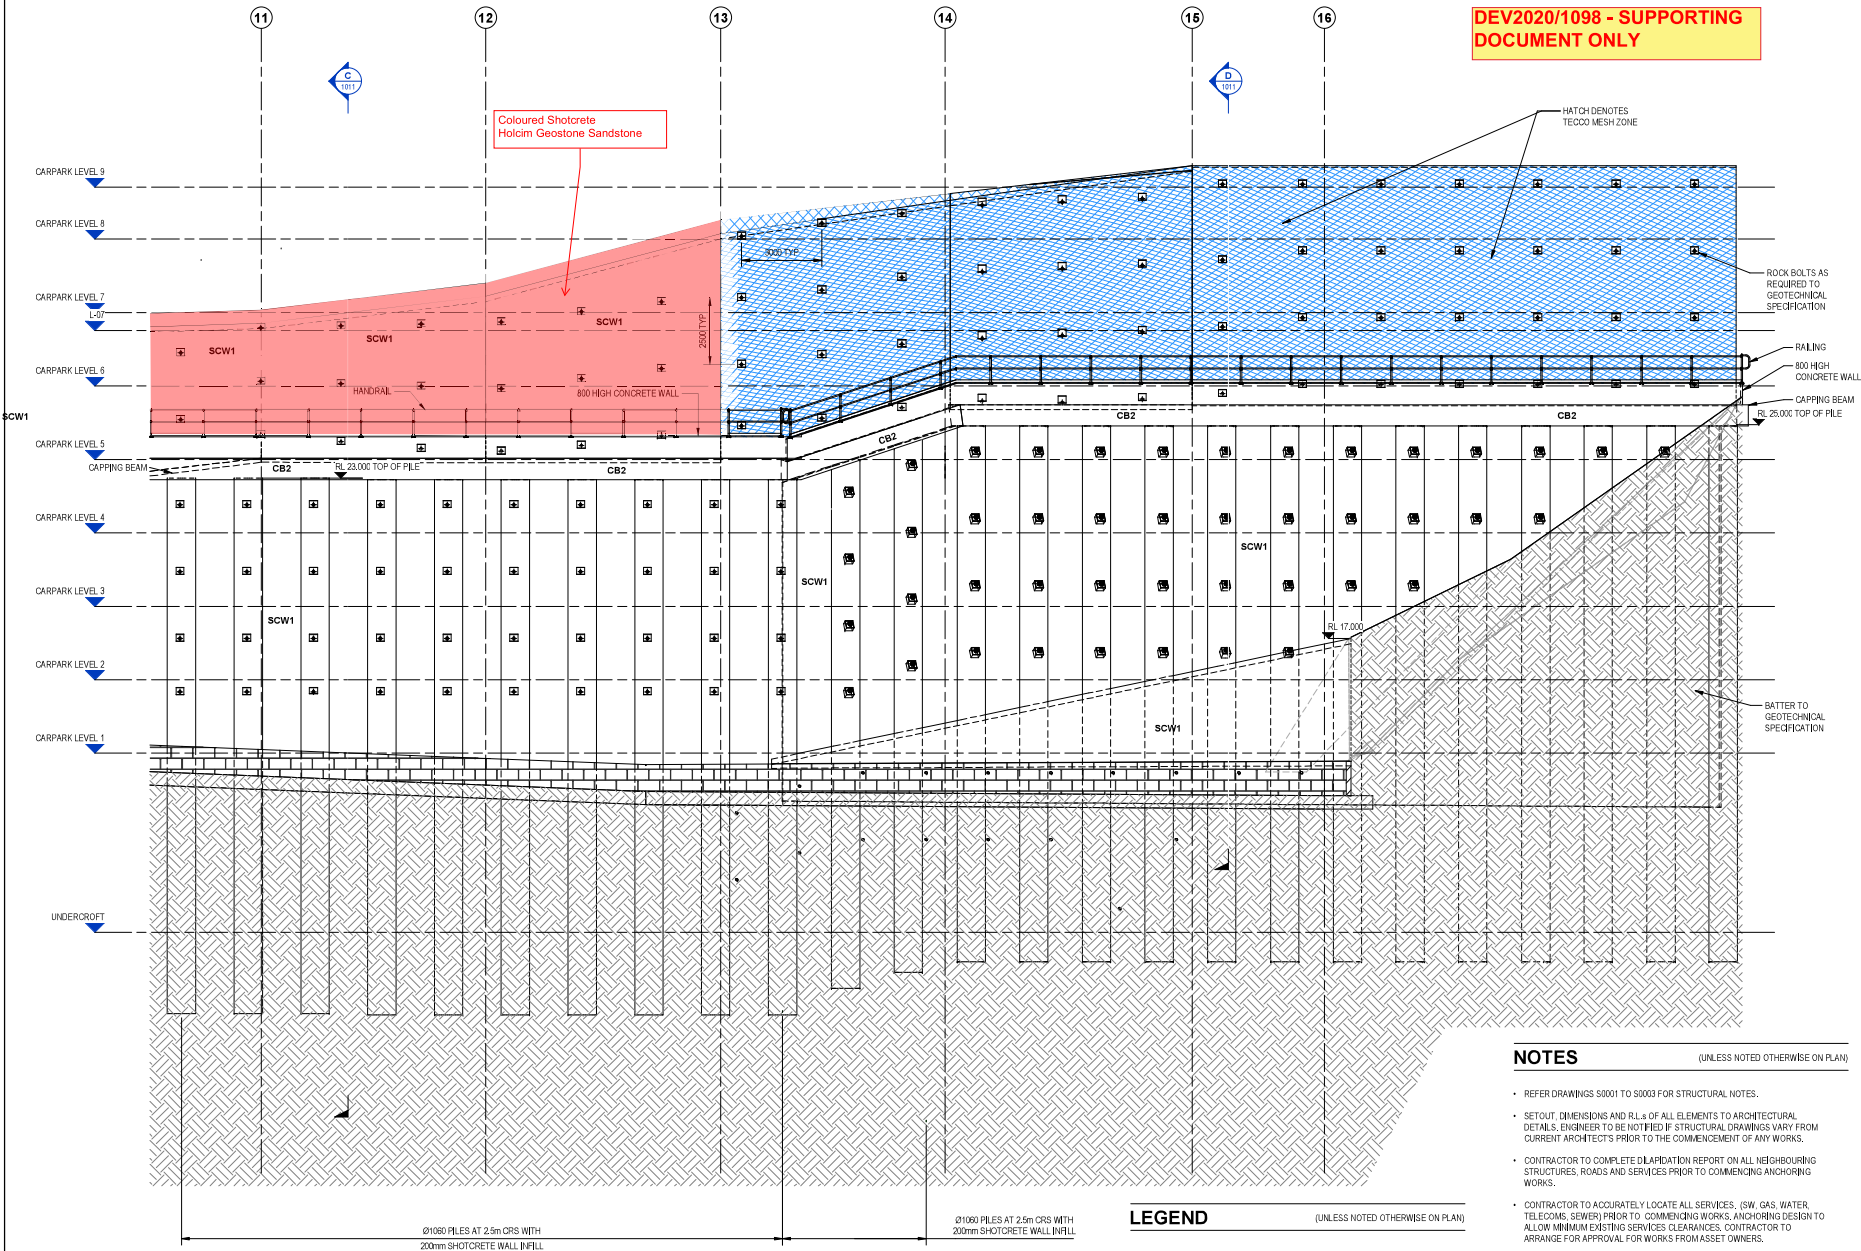

NOTES

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LEGEND

(UNLESS NOTED OTHERWISE ON PLAN)

- DENOTES EXISTING SITE BOUNDARY
- ⊕ DENOTES ROCK BOLT LOCATION

SHOTCRETE WALL SCHEDULE

MARK	THICKNESS
SCW1	200

CAPPING BEAM SCHEDULE

TYPE MARK	DEPTH	WIDTH	REBAR kg/m ³
CB2	800	1250	180

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SOLDER PILE SCHEDULE				
PILE TYPE	PILE DIAMETER (mm)	PILE LENGTH TYPICAL (m)	REINFORCEMENT MAIN BARS	REINFORCEMENT SPIRAL
N	1060	20 TO 24	14N28	N12-350

ANCHOR SCHEDULE (INDICATIVE)					
ROW ID	WORKING LOAD (kN)	NOMINAL DIAMETER	STEEL GRADE	LENGTH	SPACING
A1	500	DA 50	500/550	14m	2.5m
A2	800	DA 63.5	500/550	15m	2.5m
A3	800	DA 63.5	500/550	20m	2.5m

RETAINING WALL 2 - PART C

SCALE: 1:100

Ø1060 PILES AT 2.5m CRS WITH
200mm SHOTCRETE WALL INFILL

Ø1060 PILES AT 2.5m CRS WITH
200mm SHOTCRETE WALL INFILL